



1. THE CONTRACTOR AND SUBCONTRACTORS SHALL OBTAIN A COPY OF THE RHODE ISLAND DEPARTMENT OF TRANSPORTATION "STANDARD SPECIFICATIONS FOR ROAD AND BRIDGES" (LATEST EDITION), ITS SUPPLEMENTS, AND BECOME FAMILIAR WITH THE CONTENTS PRIOR TO COMMENCING WORK.
2. THE CONTRACTOR SHALL BE RESPONSIBLE FOR FURNISHING ALL MATERIAL AND LABOR TO CONSTRUCT THE FACILITY AS SHOWN AND DESCRIBED IN THE CONSTRUCTION DOCUMENTS IN ACCORDANCE WITH THE APPROPRIATE APPROVING AUTHORITIES, SPECIFICATIONS AND REQUIREMENTS. CONTRACTOR SHALL CLEAR AND GRUB ALL AREAS UNLESS OTHERWISE INDICATED, REMOVING TREES, STUMPS, ROOTS, MUCK, EXISTING PAVEMENT AND ALL OTHER DELETERIOUS MATERIAL.
3. EXISTING UTILITIES SHOWN ARE LOCATED ACCORDING TO THE INFORMATION AVAILABLE TO THE ENGINEER AT THE TIME OF THE TOPOGRAPHIC SURVEY AND HAVE NOT BEEN INDEPENDENTLY VERIFIED BY THE OWNER OR THE ENGINEER. GUARANTEE IS NOT MADE THAT ALL EXISTING UNDERGROUND UTILITIES ARE SHOWN OR THAT THE LOCATION OF THOSE SHOWN ARE ENTIRELY ACCURATE. FINDING THE ACTUAL LOCATION OF ANY EXISTING UTILITIES IS THE CONTRACTOR'S RESPONSIBILITY AND SHALL BE DONE BEFORE HE COMMENCES ANY WORK IN THE VICINITY. FURTHERMORE, THE CONTRACTOR SHALL BE FULLY RESPONSIBLE FOR ANY AND ALL DAMAGES DUE TO THE CONTRACTOR'S FAILURE TO EXACTLY LOCATE AND PRESERVE ANY AND ALL UNDERGROUND UTILITIES. THE OWNER OR ENGINEER WILL ASSUME NO LIABILITY FOR ANY DAMAGES SUSTAINED OR COST INCURRED BECAUSE OF THE OPERATIONS IN THE VICINITY OF EXISTING UTILITIES OR STRUCTURES, NOR FOR TEMPORARY BRACING AND SHORING OF SAME. IF IT IS NECESSARY TO SHORE, BRACE, SWING OR RELOCATE A UTILITY, THE UTILITY COMPANY OR DEPARTMENT AFFECTED SHALL BE CONTACTED AND THEIR PERMISSION OBTAINED REGARDING THE METHOD TO USE FOR SUCH WORK.
4. IT IS THE CONTRACTOR'S RESPONSIBILITY TO CONTACT THE VARIOUS UTILITY COMPANIES WHICH MAY HAVE BURIED OR AERIAL UTILITIES WITHIN OR NEAR THE CONSTRUCTION AREA BEFORE COMMENCING WORK. THE CONTRACTOR SHALL PROVIDE 3 BUSINESS DAYS MINIMUM NOTICE TO ALL UTILITY COMPANIES PRIOR TO BEGINNING CONSTRUCTION. A LIST OF THE UTILITY COMPANIES WHICH THE CONTRACTOR MUST CALL BEFORE COMMENCING WORK IS PROVIDED ON THE COVER SHEET OF THE CONSTRUCTION PLANS. THIS LIST SERVES AS A GUIDE ONLY AND IS NOT INTENDED TO LIMIT THE UTILITY COMPANIES WHICH THE CONTRACTOR MAY WISH TO NOTIFY.
5. THE CONTRACTOR SHALL BE RESPONSIBLE FOR OBTAINING ALL REQUIRED CONSTRUCTION PERMITS AND BONDS IF REQUIRED PRIOR TO CONSTRUCTION.
6. THE CONTRACTOR SHALL HAVE AVAILABLE AT THE JOB SITE AT ALL TIMES ONE COPY OF THE CONSTRUCTION DOCUMENTS INCLUDING PLANS, SPECIFICATIONS, AND SPECIAL CONDITIONS AND COPIES OF ANY REQUIRED CONSTRUCTION PERMITS INCLUDING THE NATIONAL POLLUTANT DISCHARGE ELIMINATION SYSTEM (NPDES) PERMIT AND ASSOCIATED STORMWATER POLLUTION PREVENTION PLAN (SWPPP).
7. ANY DISCREPANCIES ON THE DRAWINGS SHALL BE IMMEDIATELY BROUGHT TO THE ATTENTION OF THE OWNER AND ENGINEER BEFORE COMMENCING WORK. NO FIELD CHANGES OR DEVIATIONS FROM DESIGN ARE TO BE MADE WITHOUT PRIOR APPROVAL OF THE OWNER AND NOTIFICATION TO THE ENGINEER.
8. ALL COPIES OF COMPACTION, CONCRETE AND OTHER REQUIRED TEST RESULTS ARE TO BE SENT TO THE OWNER AND DESIGN ENGINEER OF RECORD DIRECTLY FROM THE TESTING AGENCY.
9. THE CONTRACTOR SHALL BE RESPONSIBLE FOR SUBMITTING TO THE ENGINEER A CERTIFIED RECORD SURVEY SIGNED AND SEALED BY A PROFESSIONAL LAND SURVEYOR REGISTERED IN THE STATE OF RHODE ISLAND DEPICTING THE ACTUAL FIELD LOCATION OF ALL CONSTRUCTED IMPROVEMENTS THAT ARE REQUIRED BY THE JURISDICTIONAL AGENCIES FOR THE CERTIFICATION PROCESS. ALL SURVEY COSTS WILL BE THE CONTRACTORS RESPONSIBILITY.
10. THE CONTRACTOR SHALL BE RESPONSIBLE FOR DOCUMENTING AND MAINTAINING AS-BUILT INFORMATION WHICH SHALL BE RECORDED AS CONSTRUCTION PROGRESSES OR AT THE COMPLETION OF APPROPRIATE CONSTRUCTION INTERVALS AND SHALL BE RESPONSIBLE FOR PROVIDING AS-BUILT DRAWINGS TO THE OWNER FOR THE PURPOSE OF CERTIFICATION TO JURISDICTIONAL AGENCIES AS REQUIRED. ALL AS-BUILT DATA SHALL BE COLLECTED BY A STATE OF RHODE ISLAND PROFESSIONAL LAND SURVEYOR WHOSE SERVICES ARE ENGAGED BY THE CONTRACTOR.
11. ANY WELLS DISCOVERED ON SITE THAT WILL HAVE NO USE MUST BE PLUGGED BY A LICENSED WELL DRILLING CONTRACTOR IN A MANNER APPROVED BY ALL JURISDICTIONAL AGENCIES. CONTRACTOR SHALL BE RESPONSIBLE FOR OBTAINING ANY WELL ABANDONMENT PERMITS REQUIRED.
12. ANY WELL DISCOVERED DURING EARTH MOVING OR EXCAVATION SHALL BE REPORTED TO THE APPROPRIATE JURISDICTIONAL AGENCIES WITHIN 24 HOURS AFTER DISCOVERY IS MADE.
13. THE CONTRACTOR SHALL BE RESPONSIBLE FOR VERIFYING THAT THE PROPOSED IMPROVEMENTS SHOWN ON THE PLANS DO NOT CONFLICT WITH ANY KNOWN EXISTING OR OTHER PROPOSED IMPROVEMENTS. IF ANY CONFLICTS ARE DISCOVERED, THE CONTRACTOR SHALL NOTIFY THE OWNER PRIOR TO INSTALLATION OF ANY PORTION OF THE SITE WORK THAT WOULD BE AFFECTED. FAILURE TO NOTIFY OWNER OF AN IDENTIFIABLE CONFLICT PRIOR TO PROCEEDING WITH INSTALLATION RELIEVES OWNER OF ANY OBLIGATION TO PAY FOR A RELATED CHANGE ORDER.
14. IN ACCORDANCE WITH THE GEOTECHNICAL ENGINEER'S REPORT FOR THE SITE, ALL FILL FOR PAVEMENT OR BUILDING PAD SUBGRADE SHALL BE STRUCTURAL FILL AND COMPACTED TO 95% ASTM D-1557 (MODIFIED PROCTOR), UNLESS OTHERWISE DIRECTED BY THE GEOTECHNICAL ENGINEER.
15. DURING CONSTRUCTION, NO WORK ON THE SITE SHALL BEGIN BEFORE 8:00AM OR EXTEND LATER THAN 5PM MONDAY THROUGH SATURDAY. NO WORK ON SUNDAYS OR BANK HOLIDAYS.

1. ALL MATERIAL REMOVED FROM THIS SITE BY THE CONTRACTOR SHALL BE DISPOSED OF BY THE CONTRACTOR IN A LEGAL MANNER.
2. REFER TO THE TOPOGRAPHIC SURVEY FOR ADDITIONAL DETAILS OF EXISTING STRUCTURES, ETC., LOCATED WITHIN THE PROJECT SITE. UNLESS OTHERWISE NOTED, ALL EXISTING BUILDINGS, STRUCTURES, FOUNDATIONS, SLABS, CONCRETE, ASPHALT, DEBRIS PILES, SIGNS, AND ALL APPURTENANCES ARE TO BE REMOVED FROM THE SITE BY THE FOUNDATIONS CONTRACTOR AND PROPERLY DISPOSED OF IN A LEGAL MANNER AS PART OF THIS CONTRACT. SOME ITEMS TO BE REMOVED MAY NOT BE DEPICTED ON THE TOPOGRAPHIC SURVEY. IT IS THE CONTRACTOR'S RESPONSIBILITY TO VISIT THE SITE AND DETERMINE THE FULL EXTENT OF ITEMS TO BE REMOVED. IF ANY ITEMS ARE IN QUESTION, THE CONTRACTOR SHALL CONTACT THE OWNER PRIOR TO REMOVAL OF SAID ITEMS.
3. THE CONTRACTOR SHALL REFER TO THE DEMOLITION PLAN FOR DEMOLITION/PRESERVATION OF EXISTING TREES. ALL TREES NOT SPECIFICALLY SHOWN TO BE PRESERVED OR RELOCATED SHALL BE REMOVED AS A PART OF THIS CONTRACT. TREE PROTECTION FENCING SHALL BE INSTALLED PRIOR TO ANY DEMOLITION.

1. ALL PAVING, CONSTRUCTION, MATERIALS, AND WORKMANSHIP WITHIN STATE AND TOWN RIGHT-OF-WAY SHALL BE IN ACCORDANCE WITH LOCAL OR STATE SPECIFICATIONS AND STANDARDS (LATEST EDITION) OR RIDOT SPECIFICATIONS AND STANDARDS (LATEST EDITION) IF NOT COVERED BY STATE OR TOWN REGULATIONS.
2. ALL UNPAVED AREAS IN EXISTING RIGHTS-OF-WAY DISTURBED BY CONSTRUCTION SHALL BE REGRADED AND SODDED.
3. TRAFFIC CONTROL ON ALL TOWN AND STATE RIGHTS-OF-WAY SHALL MEET THE REQUIREMENTS OF THE MANUAL OF UNIFORM TRAFFIC CONTROL DEVICES (U.S. DOT/FHA) AND THE REQUIREMENTS OF THE STATE AND ANY LOCAL AGENCY HAVING JURISDICTION. IN THE EVENT THAT THE CONTRACT DOCUMENTS AND THE JURISDICTIONAL AGENCY REQUIREMENTS ARE NOT IN AGREEMENT, THE MOST STRINGENT SHALL GOVERN.
4. THE CONTRACTOR SHALL GRADE THE SITE TO THE ELEVATIONS INDICATED AND SHALL REGRADE WASHOUTS WHERE THEY OCCUR AFTER EVERY RAINFALL UNTIL A GRASS STAND IS WELL ESTABLISHED OR ADEQUATE STABILIZATION OCCURS.
5. ALL OPEN AREAS WITHIN THE PROJECT SITE SHALL BE SODDED UNLESS INDICATED OTHERWISE ON THE LANDSCAPE PLAN.
6. ALL AREAS INDICATED AS PAVEMENT SHALL BE CONSTRUCTED IN ACCORDANCE WITH THE TYPICAL PAVEMENT SECTIONS AS INDICATED ON THE DRAWINGS.
7. WHERE EXISTING PAVEMENT IS INDICATED TO BE REMOVED AND REPLACED, THE CONTRACTOR SHALL SAW CUT A MINIMUM 2" DEEP FOR A SMOOTH AND STRAIGHT JOINT AND REPLACE THE PAVEMENT WITH THE SAME TYPE AND DEPTH OF MATERIAL AS EXISTING OR AS INDICATED.
8. WHERE NEW PAVEMENT MEETS THE EXISTING PAVEMENT, THE CONTRACTOR SHALL SAW CUT THE EXISTING PAVEMENT A MINIMUM 2" DEEP FOR A SMOOTH AND STRAIGHT JOINT AND MATCH THE EXISTING PAVEMENT ELEVATION WITH THE PROPOSED PAVEMENT UNLESS OTHERWISE INDICATED.
9. THE CONTRACTOR SHALL INSTALL FILTER FABRIC OVER ALL DRAINAGE STRUCTURES FOR THE DURATION OF CONSTRUCTION AND UNTIL ACCEPTANCE OF THE PROJECT BY THE OWNER. ALL DRAINAGE STRUCTURES SHALL BE CLEARED OF DEBRIS AS REQUIRED DURING AND AT THE END OF CONSTRUCTION TO PROVIDE POSITIVE DRAINAGE FLOWS.
10. IF DEWATERING IS REQUIRED, THE CONTRACTOR SHALL OBTAIN ANY APPLICABLE REQUIRED PERMITS. THE CONTRACTOR IS TO COORDINATE WITH THE OWNER AND THE DESIGN ENGINEER PRIOR TO ANY EXCAVATION. EFFLUENT FROM DEWATERING OPERATIONS SHALL BE FILTERED OR PASSED THROUGH AN APPROVED SEDIMENT TRAPPING DEVICE, SEDIMENTATION TANK OR STRAW BALE/SILT FENCE PIT, OR BOTH, AND DISCHARGED IN A MANNER THAT DOES NOT ADVERSELY AFFECT ADJACENT PROPERTIES, WETLANDS, WATERWAYS OR THE STORM DRAINAGE SYSTEM. CONTRACTOR IS RESPONSIBLE FOR SIZING TANK OR PITS BASED ON PROPOSED FLOWS FROM DEWATERING OPERATIONS.
11. STRIP TOPSOIL AND ORGANIC MATTER FROM ALL AREAS OF THE SITE AS REQUIRED. IN SOME CASES TOPSOIL MAY BE STOCKPILED ON SITE FOR PLACEMENT WITHIN LANDSCAPED AREAS BUT ONLY AS DIRECTED BY THE OWNER.
12. FIELD DENSITY TESTS SHALL BE TAKEN AT INTERVALS IN ACCORDANCE WITH THE LOCAL JURISDICTIONAL AGENCY OR TO MEET HIGHWAY STANDARDS. IN THE EVENT THAT THE CONTRACT DOCUMENTS AND THE JURISDICTIONAL AGENCY REQUIREMENTS ARE NOT IN AGREEMENT, THE MOST STRINGENT SHALL GOVERN.
13. ALL SLOPES AND AREAS DISTURBED BY CONSTRUCTION SHALL BE GRADED AS PER PLANS. THE AREAS SHALL THEN BE SODDED OR SEEDED AS SPECIFIED IN THE PLANS. FERTILIZED, MULCHED, WATERED AND MAINTAINED UNTIL HARDY GRASS GROWTH IS ESTABLISHED IN ALL AREAS. ANY AREAS DISTURBED FOR ANY REASON PRIOR TO FINAL ACCEPTANCE OF THE JOB SHALL BE CORRECTED BY THE CONTRACTOR AT NO ADDITIONAL COST TO THE OWNER. ALL EARTHEN AREAS WILL BE SODDED OR SEEDED AND MULCHED AS SHOWN ON THE LANDSCAPING PLAN.
14. ALL CUT OR FILL SLOPES SHALL BE 4 (HORIZONTAL):1 (VERTICAL) OR FLATTER UNLESS OTHERWISE SHOWN.
15. THE CONTRACTOR SHALL BE RESPONSIBLE FOR THE CONTROL OF DUST AND DIRT RISING AND SCATTERING IN THE AIR DURING CONSTRUCTION AND SHALL PROVIDE WATER SPRINKLING OR OTHER SUITABLE METHODS OF CONTROL. THE CONTRACTOR SHALL COMPLY WITH ALL GOVERNING REGULATIONS PERTAINING TO ENVIRONMENTAL PROTECTION.
16. SOD, WHEN CALLED FOR, MUST BE INSTALLED AND MAINTAINED ON EXPOSED SLOPES WITHIN 48 HOURS OF COMPLETING FINAL GRADING, AND AT ANY OTHER TIME AS NECESSARY, TO PREVENT EROSION, SEDIMENTATION OR TURBID DISCHARGES.
17. THE CONTRACTOR SHALL ENSURE THAT ISLAND PLANTING AREAS AND OTHER PLANTING AREAS ARE NOT COMPACTED AND DO NOT CONTAIN ROAD BASE MATERIALS. THE CONTRACTOR SHALL ALSO EXCAVATE AND REMOVE ALL UNDESIRABLE MATERIAL FROM ALL AREAS ON THE SITE TO BE PLANTED AND PROPERLY DISPOSED OF IN A LEGAL MANNER.
18. THE CONTRACTOR SHALL ENSURE THAT ALL ONSITE DRAINAGE PIPES AND NEXT DOWNSTREAM DRAINAGE PIPE ARE CLEARED FOLLOWING CONSTRUCTION.

1. CONTRACTOR SHALL VERIFY AND BE RESPONSIBLE FOR ALL DIMENSIONS AND CONDITIONS AT THE JOB SITE.
2. FOUNDATION CONCRETE MAY BE PLACED DIRECTLY INTO NEAT EXCAVATIONS, PROVIDED THE SIDES OF THE EXCAVATION ARE STABLE. WHERE CAVING OCCURS, PROVIDE SHORING. TYPE AND METHOD OF SHORING SHALL BE AT CONTRACTORS OPTIONS.
3. THE EXCAVATION SHALL BE KEPT DRY AT ALL TIMES. GROUND WATER, IF ENCOUNTERED, SHALL BE PUMPED FROM THE EXCAVATIONS.
4. CONCRETE SHALL BE LABORATORY DESIGNED, MACHINE MIXED, PRODUCING 3,000 PSI (MINIMUM) AT 28 DAYS, UNLESS OTHERWISE NOTED IN CONTRACT DOCUMENTS.
5. CEMENT SHALL BE TESTED PORTLAND CEMENT CONFORMING TO ASTM C150, TYPE II ONLY.
6. AGGREGATES SHALL CONFORM TO ASTM C33 & B GRADE PER STANDARD SPECIFICATIONS. MAXIMUM SIZE OF AGGREGATE SHALL BE 1-1/2 INCHES.
7. REINFORCING STEEL SHALL BE DEFORMED BARS CONFORMING TO ASTM A615, GRADE 60 (60,000 PSI).
8. HOOKS AND BENDS SHALL CONFORM TO ACI STANDARD 318. LATEST REVISIONS. INSIDE DIAMETER OF HOOKS AND BENDS SHALL BE AT LEAST SIX (6) BAR DIAMETERS.
9. PROVIDE SPACER BARS, CHAIRS, SPREADERS, BLOCKS, ETC. AS REQUIRED TO POSITIVELY HOLD THE STEEL IN PLACE BEFORE CONCRETE IS POURED.
10. CONCRETE SHALL BE CONVEYED FROM THE MIXER TO FINAL DEPOSIT BY METHODS THAT WILL PREVENT SEPARATION OR LOSS OF MATERIALS.
11. CONCRETE SHALL BE THOROUGHLY CONSOLIDATED BY SUITABLE MEANS DURING PLACEMENT AND SHALL BE THOROUGHLY WORKED AROUND REINFORCEMENT AND EMBEDDED FIXTURES AND CORNERS OF FORMS.

12. CONCRETE SHALL BE MAINTAINED ABOVE 50 DEGREES F (10 DEGREES C) AND IN A MOIST CONDITION FOR AT LEAST SEVEN (7) DAYS AFTER PLACEMENT. ADEQUATE EQUIPMENT SHALL BE PROVIDED FOR HEATING CONCRETE MATERIALS AND PROTECTING CONCRETE DURING FREEZING OR NEAR FREEZING WEATHER.
13. WHERE EXTERIOR WALL FACE REQUIRES SHORING AND/OR FORMING, THE FORMS SHALL BE SUBSTANTIAL AND SUFFICIENTLY TIGHT TO PREVENT LEAKAGE. FORMS SHALL NOT BE REMOVED UNTIL THE CONCRETE IS SEVEN (7) DAYS OLD.
14. BACKFILLING SHALL BE DONE BY DEPOSITING AND TAMPING INTO PLACE CLEAN SAND OR POURING LEAN CONCRETE, TO 95% COMPACTION. WATER JETTING SHALL NOT BE ALLOWED.
15. CONDUITS AND PIPES OF ALUMINUM SHALL NOT BE ALLOWED.
16. CONSTRUCTION JOINTS NOT INDICATED ON THE DRAWINGS SHALL NOT BE ALLOWED. WHERE A CONSTRUCTION JOINT IS TO BE MADE, THE SURFACE OF THE CONCRETE SHALL BE THOROUGHLY CLEANED AND ALL LAITANCE AND STANDING WATER REMOVED.
17. CONTRACTOR SHALL BE RESPONSIBLE FOR THE PROTECTION OF ALL ADJACENT AREAS AGAINST DAMAGE AND SHALL REPAIR OR PATCH ALL DAMAGED AREAS TO MATCH EXISTING IMPROVEMENTS.
18. CONTRACTOR SHALL KEEP THE CONSTRUCTION AREA CLEAN AT ALL TIMES AND AT COMPLETION OF WORK, REMOVE ALL SURPLUS MATERIALS, EQUIPMENT AND DEBRIS AND LEAVE THE PREMISES IN A CLEAN CONDITION ACCEPTABLE TO THE OWNER OR OWNER'S REPRESENTATIVE.


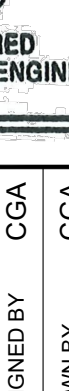
1. THE STORM WATER POLLUTION PREVENTION PLAN ("SWPPP") IS COMPRISED OF THIS EROSION CONTROL PLAN, THE STANDARD DETAILS, THE PLAN NARRATIVE, ATTACHMENTS INCLUDED IN SPECIFICATIONS OF THE SWPPP, PLUS THE PERMIT AND ALL SUBSEQUENT REPORTS AND RELATED DOCUMENTS.
2. ALL CONTRACTORS AND SUBCONTRACTORS INVOLVED WITH STORM WATER POLLUTION PREVENTION SHALL OBTAIN A COPY OF THE STORM WATER POLLUTION PREVENTION PLAN AND THE STATE OF RHODE ISLAND POLLUTANT DISCHARGE ELIMINATION SYSTEM GENERAL PERMIT (RPDES PERMIT) AND BECOME FAMILIAR WITH THEIR CONTENTS.
3. THE CONTRACTOR SHALL IMPLEMENT BEST MANAGEMENT PRACTICES AS REQUIRED BY THE SWPPP. ADDITIONAL BEST MANAGEMENT PRACTICES SHALL BE IMPLEMENTED AS DICTATED BY CONDITIONS AT NO ADDITIONAL COST TO THE OWNER THROUGHOUT ALL PHASES OF CONSTRUCTION.
4. BEST MANAGEMENT PRACTICES (BMP'S) AND CONTROLS SHALL CONFORM TO FEDERAL STATE, OR LOCAL REQUIREMENTS OR MANUAL OF PRACTICE, AS APPLICABLE. THE CONTRACTOR SHALL IMPLEMENT ADDITIONAL CONTROLS AS DIRECTED BY THE PERMITTING AGENCY OR OWNER.
5. EROSION CONTROL PLAN MUST CLEARLY DELINEATE ALL STATE WATERS. PERMITS FOR ANY CONSTRUCTION ACTIVITY IMPACTING STATE WATERS OR REGULATED WETLANDS MUST BE MAINTAINED ON SITE AT ALL TIMES.
6. THE CONTRACTOR SHALL MINIMIZE CLEARING TO THE MAXIMUM EXTENT PRACTICAL OR AS REQUIRED BY THE GENERAL PERMIT.
7. CONTRACTOR SHALL DENOTE ON PLAN THE TEMPORARY PARKING AND STORAGE AREA WHICH SHALL ALSO BE USED AS THE EQUIPMENT MAINTENANCE AND CLEANING AREA, EMPLOYEE PARKING AREA, AND AREA FOR LOCATING PORTABLE FACILITIES, OFFICE TRAILERS, AND TOILET FACILITIES.
8. ALL WASH WATER (CONCRETE TRUCKS, VEHICLE CLEANING, EQUIPMENT CLEANING, ETC.) SHALL BE DETAINED AND PROPERLY TREATED OR DISPOSED.
9. SUFFICIENT OIL AND GREASE ABSORBING MATERIALS AND FLotation BOOMS SHALL BE MAINTAINED ON SITE OR READILY AVAILABLE TO CONTAIN AND CLEAN-UP FUEL OR CHEMICAL SPILLS AND LEAKS.
10. THE CONTRACTOR SHALL BE RESPONSIBLE FOR DUST CONTROL ON SITE. THE USE OF MOTOR OILS AND OTHER PETROLEUM BASED OR TOXIC LIQUIDS FOR DUST SUPPRESSION OPERATIONS IS PROHIBITED.
11. RUBBISH, TRASH, GARBAGE, LITTER, OR OTHER SUCH MATERIALS SHALL BE DEPOSITED INTO SEALED CONTAINERS. MATERIALS SHALL BE PREVENTED FROM LEAVING THE PREMISES THROUGH THE ACTION OF WIND OR STORM WATER DISCHARGE INTO DRAINAGE DITCHES OR WATERS OF THE STATE.
12. ALL STORM WATER POLLUTION PREVENTION MEASURES PRESENTED ON THE PLAN, SHALL BE INITIATED AS SOON AS PRACTICABLE.
13. STABILIZATION PRACTICES SHOULD BE INITIATED AS SOON AS PRACTICAL, BUT IN NO CASE MORE THAN 7 DAYS WHERE CONSTRUCTION HAS TEMPORARILY CEASED.
14. DISTURBED PORTIONS OF THE SITE WHERE CONSTRUCTION ACTIVITY WILL CEASE FOR MORE THAN 14 DAYS SHALL BE PERMANENTLY SEEDED. THESE AREAS SHALL BE SEEDED NO LATER THAN 7 DAYS AFTER THE LAST CONSTRUCTION ACTIVITY OCCURRED IN THESE AREAS.
15. IF THE ACTION OF VEHICLES TRAVELING OVER THE GRAVEL CONSTRUCTION ENTRANCES IS NOT SUFFICIENT TO REMOVE THE MAJORITY OF DIRT OR MUD, THEN THE TIRES MUST BE WASHED BEFORE THE VEHICLES ENTER A PUBLIC ROAD. IF WASHING IS USED, PROVISIONS MUST BE MADE TO INTERCEPT THE WASH WATER AND TRAP THE SEDIMENT BEFORE IT IS CARRIED OFF THE SITE.
16. ALL MATERIALS SPILLED, DROPPED, WASHED, OR TRACKED FROM VEHICLES ONTO ROADWAYS OR INTO STORM DRAINS MUST BE REMOVED AS SOON AS POSSIBLE.
17. THE CONTRACTOR SHALL BE RESPONSIBLE FOR REMOVING SEDIMENT IN THE UNDERGROUND DETENTION FACILITY AND ANY SEDIMENT THAT MAY HAVE COLLECTED IN THE STORM SEWER DRAINAGE SYSTEMS. REMOVAL OF SEDIMENT SHALL BE PERFORMED BY MECHANICAL METHODS (VACUUM), HAND REMOVAL, WATER FLUSHING, OR A COMBINATION OF THESE METHODS. SEDIMENT MUST BE COLLECTED FROM THE SYSTEM WITHOUT DISCHARGING ONTO THE SITE THROUGH THE OUTFALL.
18. ON-SITE & OFF SITE SOIL STOCKPILE AND BORROW AREAS SHALL BE PROTECTED FROM EROSION AND SEDIMENTATION THROUGH IMPLEMENTATION OF BEST MANAGEMENT PRACTICES. STOCKPILE AND BORROW AREA LOCATIONS SHALL BE NOTED ON THE EROSION CONTROL PLAN AND PERMITTED IN ACCORDANCE WITH GENERAL PERMIT REQUIREMENTS.
19. SLOPES SHALL BE LEFT IN A ROUGHENED CONDITION DURING THE GRADING PHASE TO REDUCE RUNOFF VELOCITIES AND EROSION.
20. DUE TO GRADE CHANGES DURING THE DEVELOPMENT OF THE PROJECT, THE CONTRACTOR SHALL BE RESPONSIBLE FOR ADJUSTING THE EROSION CONTROL MEASURES (SILT FENCES, ETC.) TO PREVENT EROSION.
21. ALL CONSTRUCTION SHALL BE STABILIZED AT THE END OF EACH WORKING DAY, THIS INCLUDES BACK FILLING OF TRENCHES FOR UTILITY CONSTRUCTION AND PLACEMENT OF GRAVEL OR BITUMINOUS PAVING FOR ROAD CONSTRUCTION.
22. ALL PROPOSED STORM INLET OR GRATE STRUCTURES SHALL BE PROTECTED WITH APPROVED INLET PROTECTION MEASURES IMMEDIATELY FOLLOWING INSTALLATION.
23. ALL SLOPES 3:1 OR GREATER SHALL BE STABILIZED WITH JUTE MESH OR OTHER APPROVED SOIL STABILIZATION FABRIC IMMEDIATELY FOLLOWING DISTURBANCE OF THE SLOPED AREA.

ALL MEASURES STATED ON THE EROSION AND SEDIMENT CONTROL PLAN, AND IN THE STORM WATER POLLUTION PREVENTION PLAN, SHALL BE MAINTAINED IN FULLY FUNCTIONAL CONDITION UNTIL NO LONGER REQUIRED FOR A COMPLETED PHASE OF WORK OR FINAL STABILIZATION OF THE SITE. ALL EROSION AND SEDIMENTATION CONTROL MEASURES SHALL BE CHECKED BY A QUALIFIED PERSON AT LEAST ONCE EVERY SEVEN CALENDAR DAYS AND WITHIN 24 HOURS OF THE END OF A 0.5" OR MORE RAINFALL EVENT, AND CLEANED AND REPAIRED IN ACCORDANCE WITH THE FOLLOWING:

1. INLET PROTECTION DEVICES AND BARRIERS SHALL BE REPAIRED OR REPLACED IF THEY SHOW SIGNS OF UNDERMINING, OR DETERIORATION.
2. ALL SEEDED AREAS SHALL BE CHECKED REGULARLY TO SEE THAT A GOOD STAND IS MAINTAINED. AREAS SHOULD BE FERTILIZED, WATERED AND RESEED AS NEEDED.
3. SILT FENCES SHALL BE REPAIRED TO THEIR ORIGINAL CONDITIONS IF DAMAGED. SEDIMENT SHALL BE REMOVED FROM THE SILT FENCES WHEN IT REACHES ONE-HALF THE HEIGHT OF THE SILT FENCE.
4. THE CONSTRUCTION ENTRANCES SHALL BE MAINTAINED IN A CONDITION WHICH WILL PREVENT TRACKING OR FLOW OF MUD ONTO PUBLIC RIGHTS-OF-WAY. THIS MAY REQUIRE PERIODIC TOP DRESSING OF THE CONSTRUCTION ENTRANCES AS CONDITIONS DEMAND.
5. THE TEMPORARY PARKING AND STORAGE AREA SHALL BE KEPT IN GOOD CONDITION (SUITABLE FOR PARKING AND STORAGE). THIS MAY REQUIRE PERIODIC TOP DRESSING OF THE TEMPORARY PARKING AS CONDITIONS DEMAND.
6. ALL MAINTENANCE OPERATIONS SHALL BE DONE IN A TIMELY MANNER BUT IN NO CASE LATER THAN 2 CALENDAR DAYS FOLLOWING THE INSPECTION.

1. WATER LINES SHALL BE DUCTILE IRON PIPE AND SHALL CONFORM TO AWWA STANDARD C-151 LATEST REVISION, CLASS 52 MANUFACTURED BY US PIPE, GRIFFIN PIPE CO., ATLANTIC STATES PIPE OR APPROVED EQUAL.
2. ALL FITTINGS SHALL CONFORM TO AWWA STANDARD C-153 LATEST REVISION, MADE OF DUCTILE IRON, COMPACT, MECHANICAL JOINT, DOUBLE CEMENT LINED, AND BITUMEN COATED MANUFACTURED BY AMERICAN CAST IRON PIPE, SIGMA, OR APPROVED EQUAL.
3. RETAINER GLANDS SHALL BE MEG-A-LUG TYPE AS MANUFACTURED BY EBBA IRON SERIES 2100, OR APPROVED EQUAL.
4. ALL GATE VALVES SHALL MEET AWWA STANDARD C509 LATEST REVISION, BE MECHANICAL JOINT, HAVE O-RING STEM SEALS AND HAVE AN EPOXY COATED BODY. ALL GATES MUST OPEN RIGHT. ALL GATES FROM 4" THROUGH 16" WILL BE DESIGNED VERTICAL INSTALLATION.
5. BUTTERFLY VALVES ARE NOT ALLOWED WITHIN THE CITY'S WATER DISTRIBUTION SYSTEM.
6. SERVICE SADDLES SHALL BE DUCTILE IRON WITH 12 MILL EPOXY COATING WITH 2 STAINLESS STEEL STRAPS.
7. TAPPING SLEEVES SHALL BE MADE OF DUCTILE IRON CONSTRUCTED TO ASTM A536 STANDARD MECHANICAL JOINT RATED 250 PSI. ALL SLEEVES MUST HAVE A TEST PORT FOR AIR TESTING. TAPPING SLEEVES SHALL BE MANUFACTURED BY AMERICAN FLOW CONTROL SERIES 2800, MUELLER H-615 OR APPROVED EQUAL.
8. TAPPING VALVES SHALL CONFORM TO AWWA/ANSI C515, NSF61 APPROVED FOR POTABLE WATER. ALL VALVES WILL BE OPEN RIGHT, EPOXY COATED, WITH RESILIENT WEDGE. TAPPING VALVES MUST BE SUPPLIED BY THE SAME MANUFACTURER AS THE TAPPING SLEEVE TO BE USED.
9. FIRE HYDRANTS SHALL CONFORM TO AWWA C502, FM 1510, AND UL 246 LISTED. THE HYDRANT MAINE VALVE WILL BE 5-1/4", OPEN LEFT.

1. RIPDES PERMIT
2. APPROVAL FROM CENTRAL COVENTRY FIRE DISTRICT
3. TOWN OF COVENTRY MAJOR LAND DEVELOPMENT FINAL PLAN APPROVAL
4. PARKING AND LOADING VARIANCE FROM THE TOWN OF COVENTRY
5. APPROVAL OF DRAINAGE PLAN AND MAINTENANCE AGREEMENT BY TOWN ENGINEER
6. APPROVAL OF EROSION CONTROL PLAN BY TOWN ENGINEER
7. APPROVAL BY KENT WATER

COVENTRY SELF STORAGE		PREPARED FOR		NOOSENECK HILL COVENTRY, LLC		1920 NOOSENECK HILL RD		COVENTRY, RI 02816		COVENTRY AP 10 LOT 31		RHODE ISLAND		SHEET NUMBER		C-1.1							
GENERAL NOTES														KHA PROJECT 112704000		SCALE AS SHOWN		DESIGNED BY CGA		DRAWN BY CGA		CHECKED BY BB	
														DATE 7/1/2024									
																							
																© 2024 KIMLEY-HORN AND ASSOCIATES, INC.		271 WAVERLEY OAKS RD., SUITE 302, WALTHAM, MA 02452		PHONE: 781-329-0676		WWW.KIMLEY-HORN.COM	
														No.		Revisions		Date		By			
														1		REVISED PER RIDEEM COMMENTS		09/09/2024		FJM			
														2		PRELIMINARY PLAN APPROVAL		06/27/2025		MJD			

## GENERAL NOTES

- The bearings for this survey are based upon the North American Datum of 1983, Rhode Island 2011 State Plane Coordinate System.
- This property has an area of 178,031 square feet or 4.086 acres of land (survey).
- This property is designated by Newport County, as Tax Map Parcel 57-4.
- There was no observable evidence of cemeteries found at the time of this survey.
- In response to Table A Items 16 and 17 there was no observable evidence of earth moving work, building construction or additions and no known proposed changes in right of way lines, recent street or sidewalk construction or repairs.
- The property has direct access via Nooseneck Hill Road, which is a public right of way.
- Interior roadways appear to be private, variable in width and unnamed, unless otherwise shown.
- The features depicted hereon are the result of a field survey. The field work was concluded on February 1, 2022.
- This survey has been produced with the benefit of a title commitment provided by First American Title Insurance Company, Commitment number: 3020-1105994, with an effective date of September 6, 2022.
- No evidence of any offsite easements or servitudes which benefit the surveyed property were disclosed in the record documents provided to the surveyor.
- as designated by the client, there are no party wall/walls on the subject property.

## SCHEDULE B - TITLE EXCEPTION NOTES

Being the same tract of land described in a Title Report prepared by First American Title Insurance Company, Commitment No. 3020-1105994, dated September 6, 2022.

8. Boundary Agreement by and between Daniel A Vaccaro, Peter P. Borghesani, Marcia Borghesani as Grantor and Mapleroot Realty as Grantee, dated April 4, 2022 and recorded in Book 2251, Page 527

## SIGNIFICANT OBSERVATIONS

No encroachments were observed while conducting the field survey.

## ZONING NOTES

The subject parcel lies entirely within a General Business District (GB-1) district with the following regulations based upon the zoning report provided by: Global Zoning; Global Zoning Job Number: GZ 16763; Dated: February 25, 2022.

**Zoned:** General Business District (GB-1)

**Permitted Use Classification:** Self-Storage Facility, variance for use approved August 22, 1994.

**Observed Use(s):** Self-Storage Facility  
Zoning Regulations are subject to change and interpretation, for further information contact: Town of Coventry, Contact's Name: John Studley, Associate Planner, Phone: 401.822.6230

### Site Restrictions:

- Minimum building setbacks:**  
Front: 10 feet  
Side: 10 feet  
Rear: 40 feet
- Measured building tie distances:**  
North: 29.4 feet  
East: 107.1 feet  
South: 22.2 feet  
West: 239.1 feet
- Minimum lot size: 43,560 S.F. (min. provided: 186,832 S.F.)
- Minimum lot frontage: 200 feet (min. provided: 329.77± feet)
- Maximum building height: 35 feet (max. provided: 10 feet)
- Maximum lot coverage: 60% (max. provided: 43.4% coverage)

## MAP REFERENCES

- A. "PLAN OF LAND IN COVENTRY, R.I. SURVEYED FOR RURAL REALTY" SCALE: 1"=100'; BY: RAY.C. MATTESSON, DECEMBER 1956.
- B. "STATE OF RHODE ISLAND HIGHWAY PLAT NUMBER 563.

### Parking Tabulation:

Total regular spaces provided: 0  
Total handicap spaces provided: 0  
Total combined spaces provided: 0

## FLOOD ZONE NOTE

By graphic plotting only, this property is in Zone X of the Flood Insurance Rate Map, Community Panel No. 44003C0111H, which bears an effective date of October 2, 2015 IS NOT in a Special Flood Hazard Area. By telephone call to the National Flood Insurance Program (800-638-6620) we have learned this community DOES currently participate in the program. No field surveying was performed to determine this zone and an elevation certificate may be needed to verify this determination or apply for a variance from the Federal Emergency Management Agency.

Survey Prepared By:

**Martin Surveying Associates, LLC.**  
201 Christian Lane, Suite D  
Berlin, CT 06037  
Phone: 860.832.9328  
www.martinsurvey.com

Surveyor's Drawing No.: 22-001  
Surveyor's Site Ref: MKA Coventry  
Checked by: D.G.M. Drawn by: G.S.D.

SCALE: 1" = 50'

## LEGEND OF SYMBOLS & ABBREVIATIONS

### LEGEND:

○ IRON PIN (FOUND)

● Rebar/Drill Hole (To Be Set)

□ MONUMENT (FOUND)

⊙ MANHOLE

⊙ DRAINAGE MANHOLE

⊙ SANITARY MANHOLE

⊙ ELEC. MANHOLE

⊙ TELE. MANHOLE

"C" CATCH BASIN

□ "C-L" CATCH BASIN

⊙ DECIDUOUS TREES

★ EVERGREEN TREES

⊙ SHRUB/BUSH

⊙ FLAG POLE

⊙ TRAFFIC CONTROL BOX

POB POINT OF BEGINNING

△ SIGN

○ POST

☆ LIGHT POLE

⋈ GUY ANCHOR

⊙ UTILITY POLE

⊙ WATER GATE

⊙ WATER METER

⊙ GAS VALVE

⊙ GAS METER

⊙ VALVE (UNKNOWN TYPE)

⊙ TRANSFORMER

⊙ ELEC. METER

⊙ MAIL BOX

⊙ HAND HOLE

⊙ BUTTON BOX

⊙ A.C. UNIT

⊙ TRAFFIC LIGHT POLE

--- BOUNDARY LINE

--- GUARD RAIL

--- UNDERGROUND PIPING (San., Strm.)

--- U/G GAS LINE

--- U/G ELEC. LINE

--- U/G WATER LINE

--- OVERHEAD UTILITIES

--- U/G TELE. LINE

--- CHAIN LINK FENCE


--- TREE LINE

--- OVERHEAD WIRES

(D) = DEED

(S) = SURVEY

## VICINITY MAP

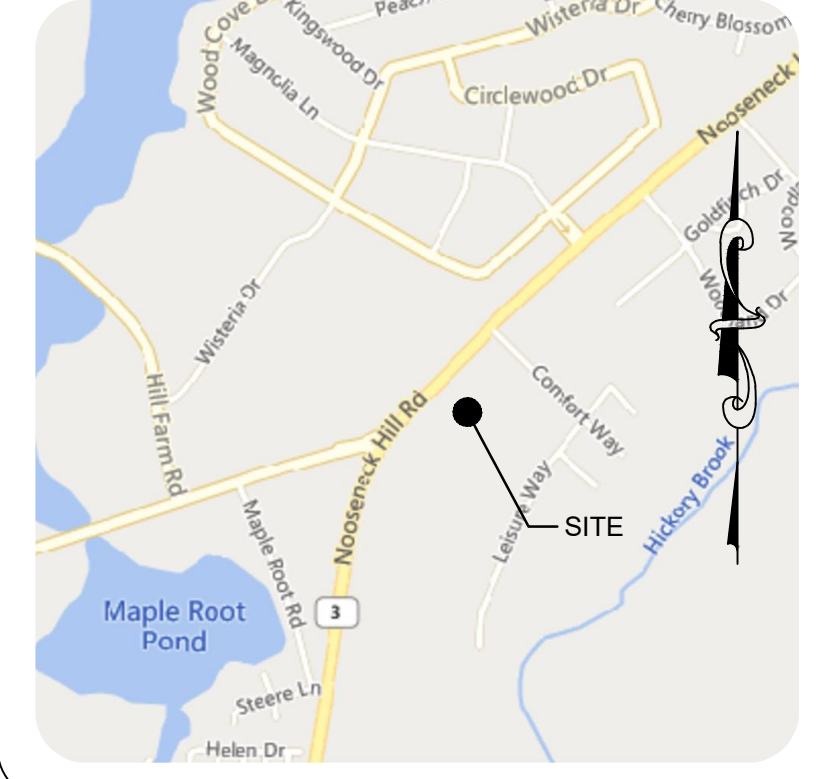

SITE LOCATION MAP (NOT TO SCALE)

## SURVEYOR DESCRIPTION

### SURVEYOR DESCRIPTION:

BEGINNING AT A POINT IN THE SOUTHERLY STREET LINE OF NOOSENECK HILL ROAD AT THE DIVISION LINE OF LAND NOW OR FORMERLY OF SHORESIDE REALTY LLC.

THENCE RUNNING ALONG SAID LAND OF SHORESIDE REALTY LLC 604.66 FEET TO A POINT AT THE DIVISION LINE OF LAND NOW OR FORMERLY OF LOUIS PALMISCIANO;

THENCE TURNING AN INTERIOR ANGLE OF 95°20'08" AND RUNNING A DISTANCE OF 79.27 FEET TO A POINT;

THENCE TURNING AN INTERIOR ANGLE OF 195°16'00" AND RUNNING A DISTANCE OF 187.69 FEET TO LAND NOW OR FORMERLY OF MAPLEROOT REALTY, LLC, THE LAST TWO COURSE BEING BOUNDED SOUTHEASTERLY BY SAID LAND OF LOUIS PALMISCIANO;

THENCE TURNING AN INTERIOR ANGLE OF 75°32'53" AND RUNNING A DISTANCE OF 679.91 FEET ALONG SAID LAND OF MAPLEROOT REALTY, LLC TO A REBAR IN THE SOUTHERLY STREET LINE OF NOOSENECK HILL ROAD, SAID POINT BEING NORTHEASTERLY 12.95 FEET FROM THE POINT OF CURVATURE HAVING A STATION OF 224+50.06 ON STATE HIGHWAY PLAT NUMBER 563;

THENCE TURNING AN ANGLE OF 85°50'18" AND RUNNING ALONG THE SAID SOUTHERLY STREET LINE OF NOOSENECK HILL ROAD A DISTANCE OF 303.82 FEET TO THE POINT OR PLACE OF BEGINNING. SAID FIRST AND LAST COURSE FORMING AN INTERIOR ANGLE OF 90°00'41".

SAID PARCEL CONTAINS 178,031 S.F. +/-, 4.086 ACRES +/-.

THE SURVEYOR'S LEGAL DESCRIPTION AS SHOWN HEREON, IS THE SAME PROPERTY DESCRIBED AS IN THE FIRST AMERICAN TITLE INSURANCE COMPANY COMMITMENT NUMBER 3020-1105994, DATED SEPTEMBER 6, 2022.

## ALTA/NSPS LAND TITLE SURVEY

Coventry Mini Storage  
1920 Nooseneck Hill Road  
Coventry, Rhode Island 02816

### Surveyor's Certification

To: Macritchie Storage Ventures LLC; First American Title Insurance Company; Nooseneck Hill Coventry, LLC; Harter Secrest & Emery LLP; and MKAssociates, Inc.

This is to certify that this map or plat and the survey on which it is based were made in accordance with the 2021 Minimum Standard Detail Requirements for ALTA/NSPS Land Title Surveys, jointly established and adopted by ALTA and NSPS and includes Items 1-5, 6(a), 6(b), 7(a), 7(b), 7(c) 8, 9, 10, 11B, 13, 14, 16, 17, 19 of Table A thereof.


The field work was completed on February 11, 2022.

Date of Plat or Map: February 15, 2022.

REV. #1 - Add Table Item 5. September 29, 2022.

Surveyor's Signature

Registered Surveyor: Dean Martin  
Registration Number: 1983  
In the State of: Rhode Island

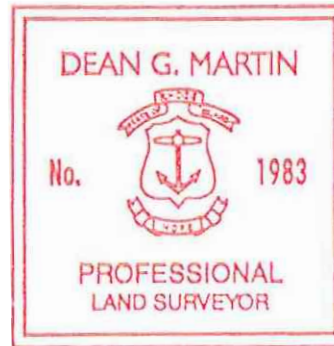

PROJECT NAME: Coventry Mini Storage MKA PROJECT No.: 6061-22-8275R  
ADDRESS: 1920 Nooseneck Hill Road CITY: Coventry STATE: Rhode Island





For Inquiries Concerning This Survey Contact MKA  
National Coordinators of Land Survey Services  
6593 Commerce Court - Warrenton, Virginia 20187  
Phone: (540) 428-3550  
Email: comments@mkassociates.com  
www.mkassociates.com

SHEET 1 OF 1

## UTILITY INFORMATION

No utility records or utility service provider contact information has been provided to the surveyor for the production of this survey.

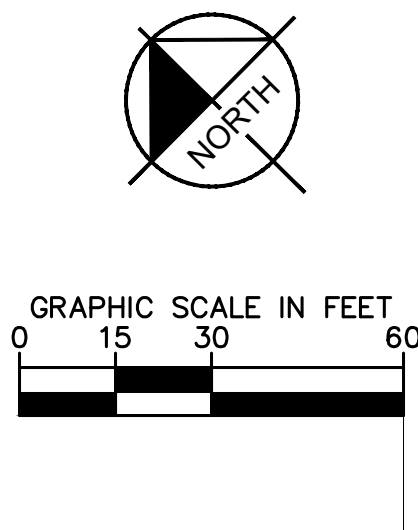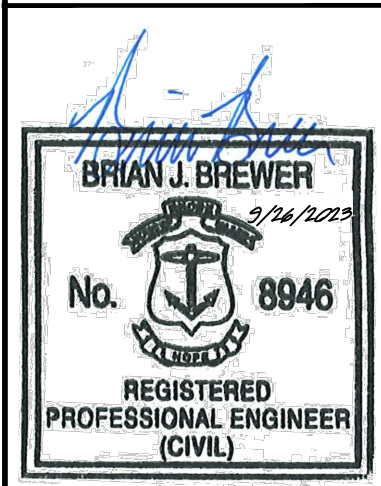[illegible]


KHA PROJECT 112704000	DATE 7/1/2024	SCALE AS SHOWN	DESIGNED BY CGA	DRAWN BY CGA	CHECKED BY BB
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## OVERALL EXISTING CONDITION AND DEMOLITION PLAN

**COVENTRY SELF STORAGE**  
 PREPARED FOR  
 NOOSENECK HILL COVENTRY, LLC  
 1920 NOOSENECK HILL RD  
 COVENTRY, RI 02816  
 COVENTRY AP 10 LOT 31 RHODE ISLAND

SHEET NUMBER  
**C-3.0**


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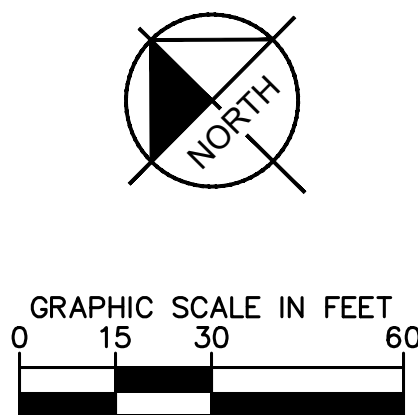
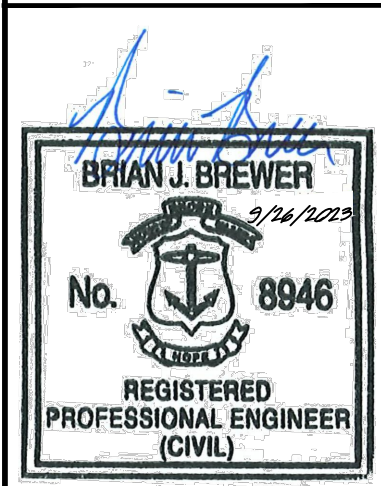
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PROPERTY LINE AGREEMENT  
AS DESCRIBED IN BOOK 2251 PAGE 527  
PARCEL CONVEYED TO MAPLEROOT REALTY, LLC AS  
DESCRIBED IN BOOK 2251 PAGE 525.  
  
BEING THE SAME TRACT OF LAND DESCRIBED IN A  
TITLE REPROT PREPARED BY FIRST AMERICAN TITLE  
INSURANCE COMPANY, COMMITMENT NO. 3020-110599,  
DATED SEPTEMBER 6, 2022  
  
BOUNDARY AGREEMENT BY AND BETWEEN DANIEL A

- LEGEND**
- PROPERTY LINE
  - LOD --- PROP. LIMITS OF DISTURBANCE 1.47 AC
  - - - - - EXISTING STRUCTURE TO BE REMOVED
  - [Pattern] EXISTING PAVEMENT TO BE REMOVED
  - [Symbol] TREE TO BE REMOVED

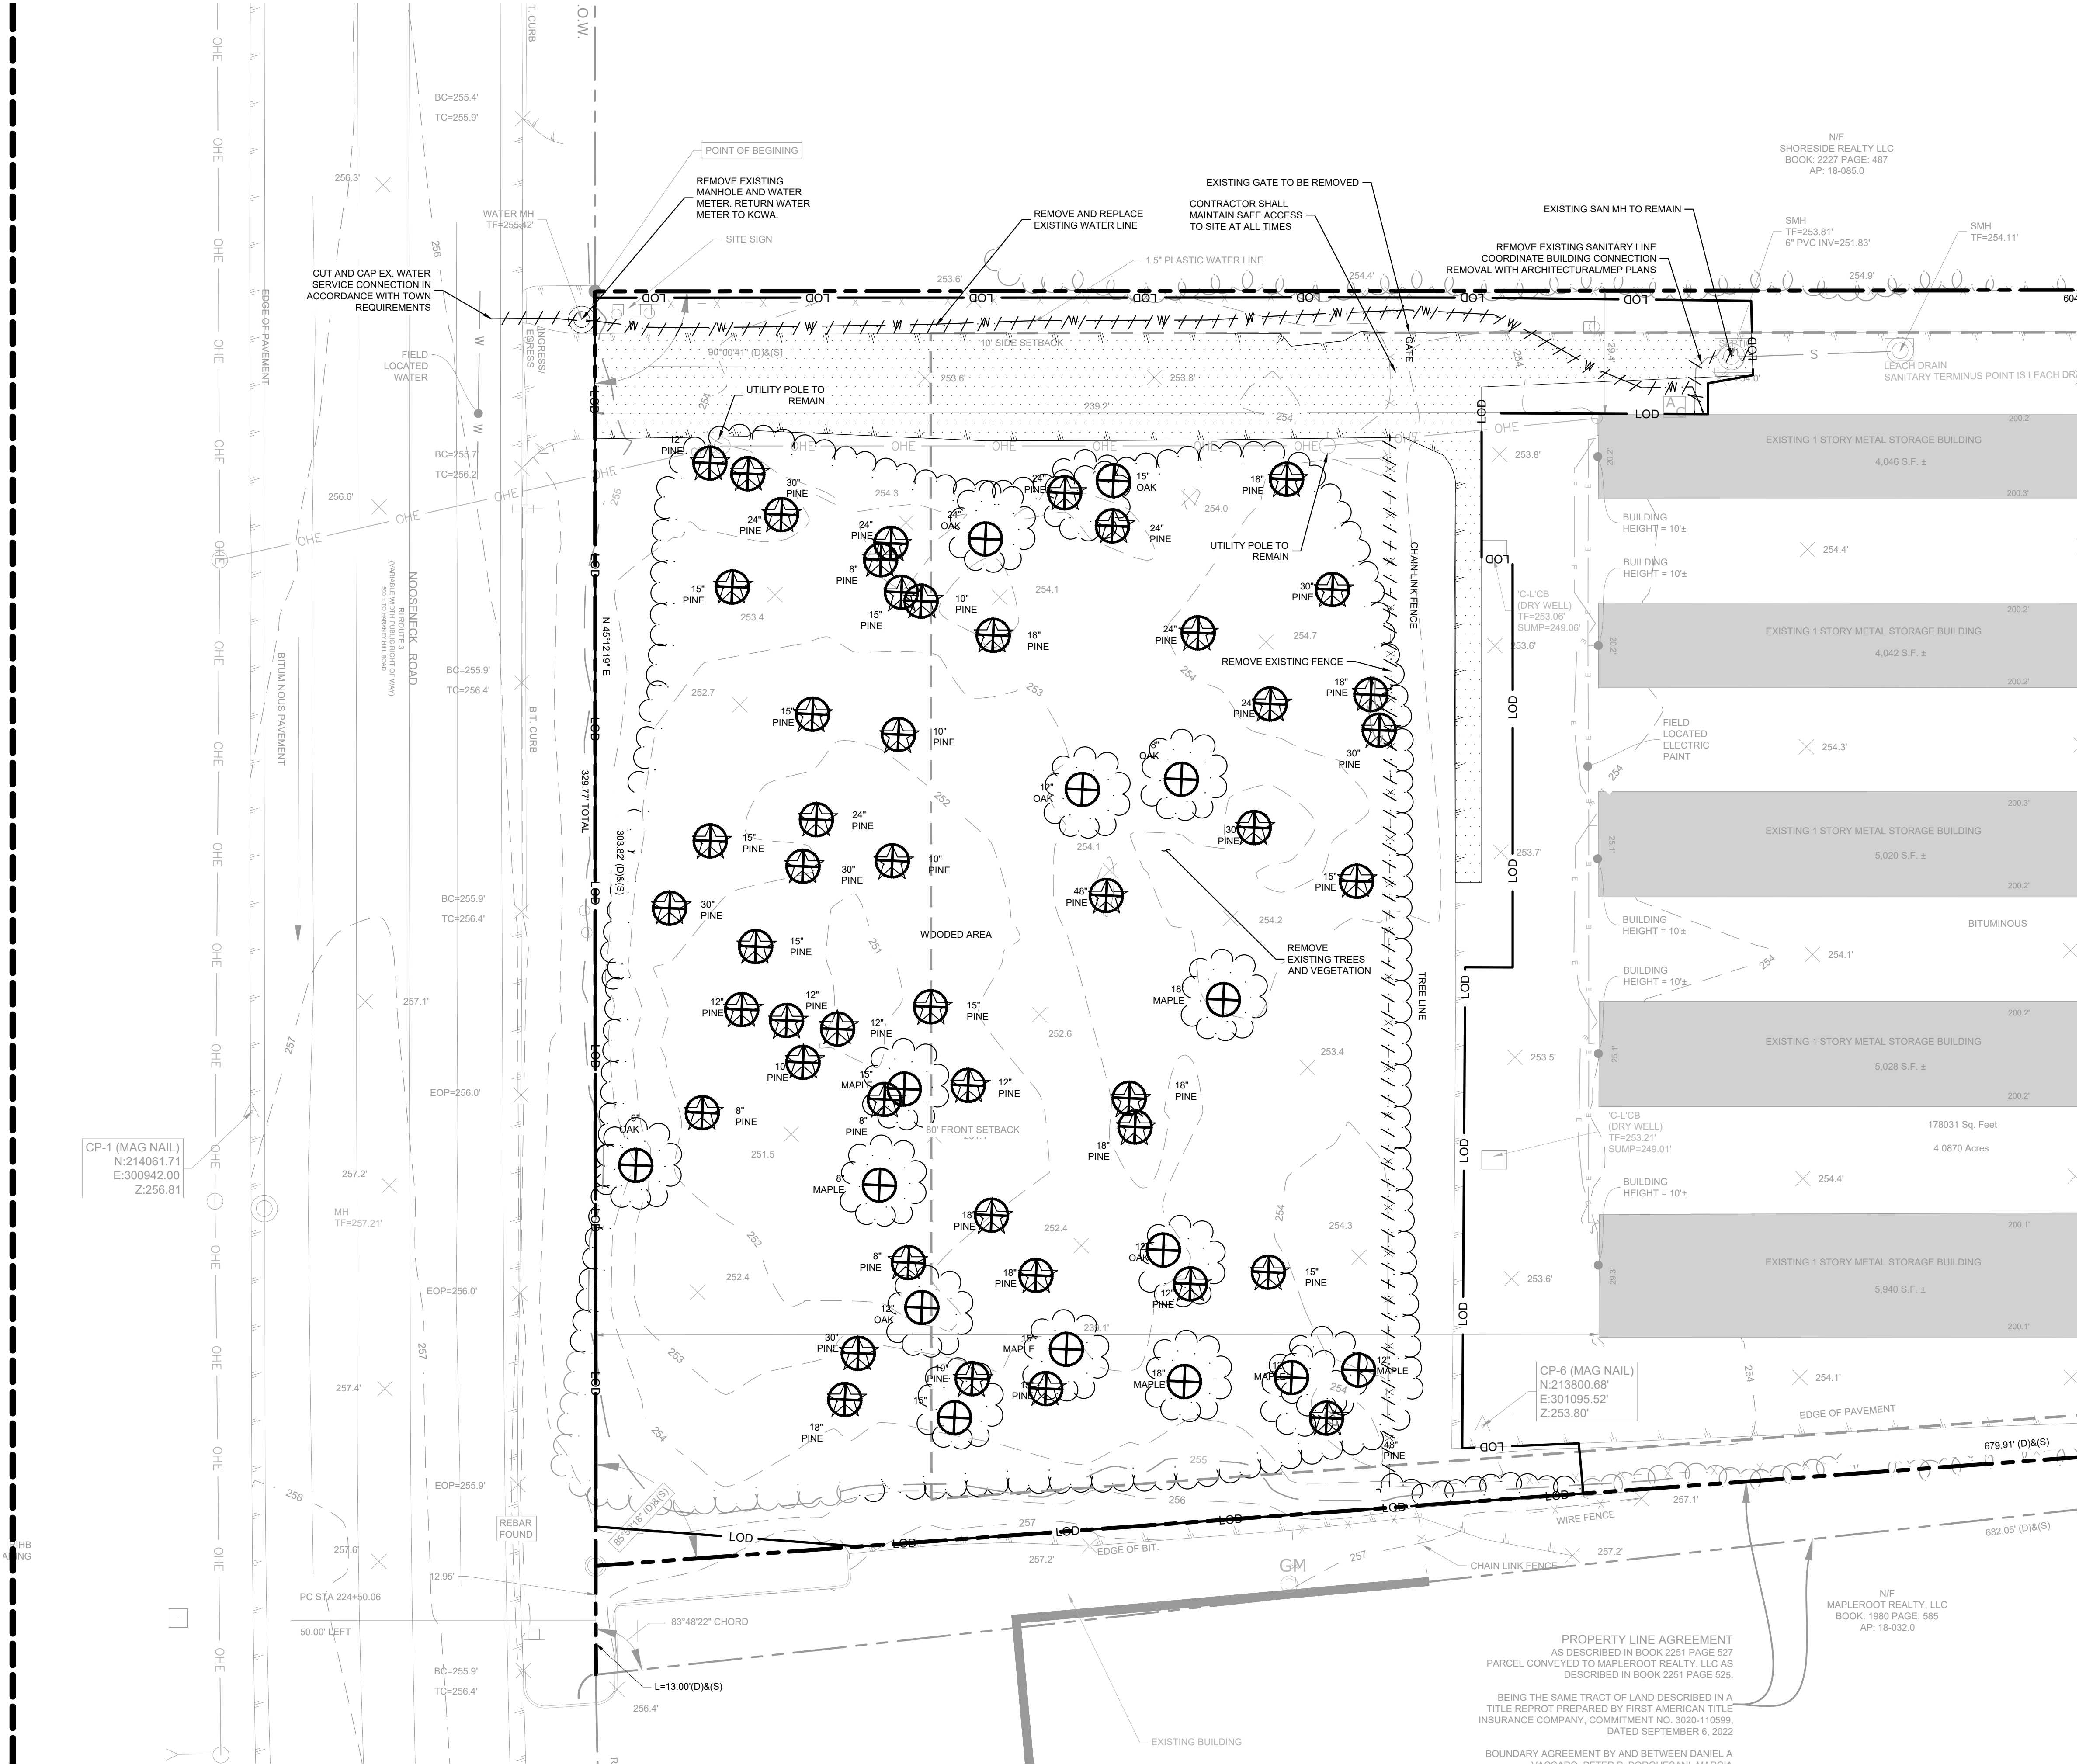

COVENTRY SELF STORAGE		COVENTRY	
PREPARED FOR NOOSENECK HILL COVENTRY, LLC 1920 NOOSENECK HILL RD COVENTRY, RI 02816		AP 10 LOT 31 RHODE ISLAND	
SHEET NUMBER <b>C-3.1</b>		DATE 09/09/2024	
KHA PROJECT 112704000		DATE 7/1/2024	
SCALE AS SHOWN		DESIGNED BY CGA	
DRAWN BY CGA		CHECKED BY BB	
BRIAN J. BREWER No. 8946 REGISTERED PROFESSIONAL ENGINEER (CIVIL)		KIMLEY HORN	
© 2024 KIMLEY-HORN AND ASSOCIATES, INC. 271 WAVERLEY OAKS RD, SUITE 302, WALTHAM, MA 02452 PHONE: 781-328-0676 WWW.KIMLEY-HORN.COM		PRELIMINARY PLAN APPROVAL 06/27/2025	
REVISED PER RIDEM COMMENTS		REVISIONS	
2		1	
MID		BY	
FJM		DATE	

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KHA PROJECT 112704000	DATE 7/1/2024	SCALE AS SHOWN	DESIGNED BY CGA	DRAWN BY CGA	CHECKED BY BB
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

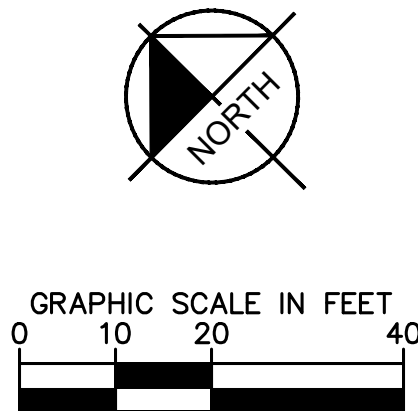







# OVERALL SITE AND UTILITY PLAN

<p>SHEET NUMBER</p> <p><b>C-4.0</b></p>	<p>COVENTRY SELF STORAGE</p> <p>PREPARED FOR</p> <p>NOOSENECK HILL COVENTRY, LLC</p> <p>1920 NOOSENECK HILL RD</p> <p>COVENTRY, RI 02816</p> <p>COVENTRY AP 10 LOT 31 RHODE ISLAND</p>
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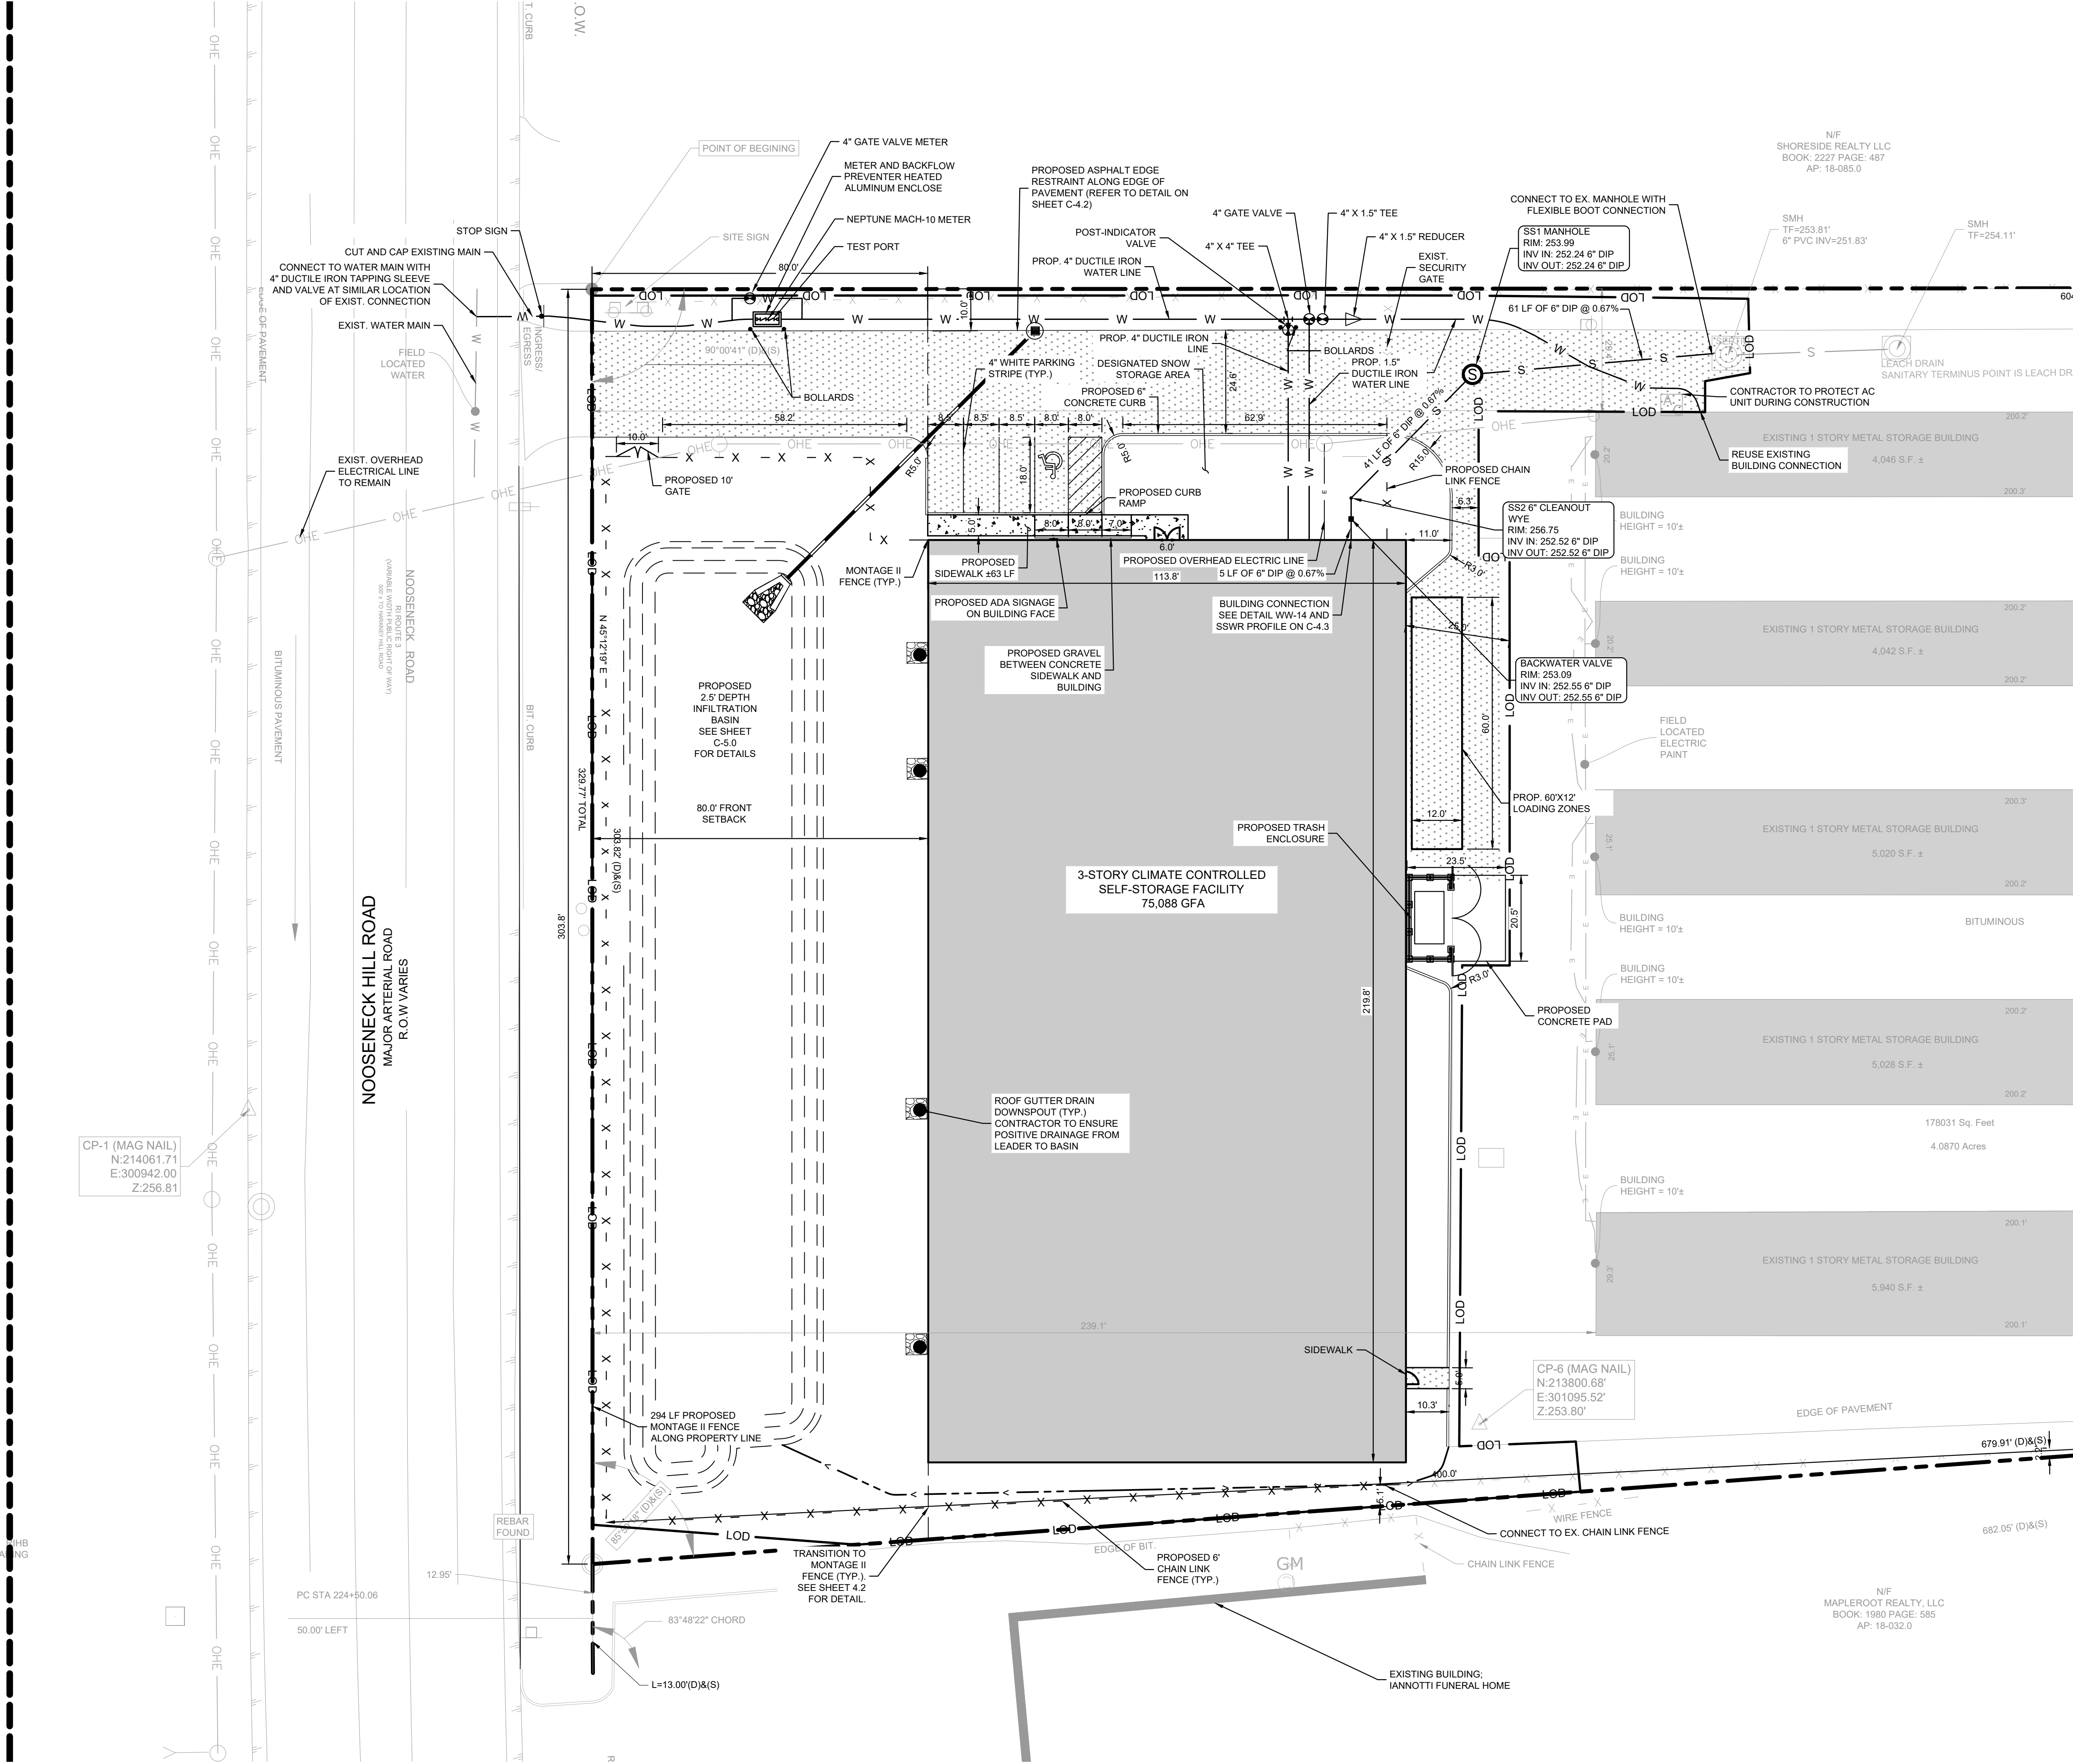
<b>SITE SUMMARY:</b>	
OWNER:	NOOSENECK HILL COVENTRY, LLC
PLAT NUMBER:	51
MAP+LOT #:	0010-031-000
SITE ADDRESS:	1920 NOOSENECK HILL ROAD, COVENTRY, RI, 02816
PARCEL AREA:	44.09 ACRES
ZONING:	GB1 (GENERAL BUSINESS - 1 ACRE); SPECIAL PLANNING OVERLAY DISTRICT
FIRE DISTRICT:	CENTRAL COVENTRY FIRE DISTRICT
DISTURBED AREA:	1.46 AC
<b>NOTES</b>	
1.	THE CURRENT USE OF THE SITE IS DRIVE-UP SELF STORAGE.
2.	PER THE SURVEY TITLED "ALT+RSPS LAND TITLE SURVEY" BY MKA DATED FEBRUARY 15, 2022 AND REVISED SEPTEMBER 29, 2022, NO CEMETERIES HAVE BEEN LOCATED ON THIS PARCEL.
3.	VERIFIED AS OF SEPTEMBER 18TH, 2023, THE PROJECT IS LOCATED IN A RIDEN NATURAL HERITAGE AREA PER RIDEN ENVIRONMENTAL RESOURCE MAP GIS.
4.	VERIFIED AS OF SEPTEMBER 18TH, 2023, THE PROJECT IS LOCATED IN AN AREA WHERE GROUNDWATER IS DESIGNATED AS GAA PER RIDEN ENVIRONMENTAL RESOURCE MAP GIS.
5.	VERIFIED AS OF SEPTEMBER 18TH, 2023, THE PROJECT IS NOT LOCATED IN COMMUNITY OR NON-COMMUNITY WELL HEAD PROTECTION AREAS PER RIDEN RESOURCE MAP GIS.
6.	VERIFIED AS OF SEPTEMBER 18TH, 2023 THE EXISTING STRUCTURES ARE NOT LISTED ON THE NATIONAL HISTORIC REGISTER AND DO NOT HAVE HISTORICAL VALUE.

ZONING DATA TABLE		
	REQUIRED	PROPOSED
GROSS FLOOR AREA	N/A	EXISTING: 28,542 SF PROPOSED: 75,988 SF TOTAL: 103,630 SF
LOT COVERAGE	60% MAXIMUM	60%
BUILDING HEIGHT	35'-0"	35'-0"
SETBACKS	FRONT: 80' (ARTERIAL ROAD) SIDE: 10' REAR: 40'	FRONT: 80' SIDE(SOUTH): 10' SIDE(NORTH): 10' REAR: >40'
PARKING REQUIREMENTS	1 SPACE FOR EACH 300 SF OF GFA (MINIMUM 3 SPACES)  346 PARKING SPACES REQUIRED FOR SITE	4 PARKING SPACES INCLUDING 1 ADA STALL <b>PARKING WAIVER REQUESTED</b>
LOADING ZONE	ONE OFF-STREET LOADING SPACE FOR EVERY USE HAVING A GROSS FLOOR AREA UP TO 5,000 SQUARE FEET. ONE ADDITIONAL SPACE FOR EACH ADDITIONAL 10,000 SQUARE FEET.  8 LOADING SPACES REQUIRED FOR SITE	1 LOADING SPACE PROVIDED FOR THE 75,988 GSF BUILDING <b>LOADING SPACE VARIANCE REQUESTED</b>

# LEGEND

	PROPERTY LINE
	PROP. LIMITS OF DISTURBANCE 1.47 AC
	PROP. BUILDING
	PROP. ASPHALT
	PROP. SIDEWALK
	EXIST. WATER
	PROP. WATER
	EXIST. SEWER
	PROP. SEWER
	PROP. STORM
	PROP. STORM STRUCTURE

Plotted By:Roche, Elizabeth Sheet Set:Kha Layout:1 July 09, 2025 10:39:02pm K:\BOS\_Civil\BOS Projects\112704000 Mini Storage (Coventry, RI)\CAD\PlanSheets\SITE PLAN.dwg  
This document, together with the concepts and designs presented herein, is an instrument of service, as an instrument of service, is intended only for the specific purpose and client for which it was prepared. Reuse of and improper reliance on the document without written authorization and adaptation by Kimley-Horn and Associates, Inc. shall be without liability to Kimley-Horn and Associates, Inc.



**QUANTITY SUMMARY:**  
TOTAL CONCRETE SIDEWALK: ~60 LF  
TOTAL ASPHALT DRIVEWAY: ~400 LF  
TOTAL 6" CONCRETE CURB: ~50 LF

**NOTES**  
1. QUANTITIES ARE APPROXIMATE AND ARE SUBJECT TO CHANGE WITH FINAL DESIGN.  
2. QUANTITIES ARE PROVIDED FOR REFERENCE ONLY. CONTRACTOR SHALL COMPLETE THEIR OWN QUANTITY TAKE OFF WHEN DETERMINING THE BID PRICE FOR THE PROJECT.

- LEGEND**
- PROPERTY LINE
  - PROP. LIMITS OF DISTURBANCE 1.47 AC
  - PROP. BUILDING
  - PROP. ASPHALT
  - PROP. SIDEWALK
  - EXIST. WATER
  - PROP. WATER
  - EXIST. SEWER
  - PROP. SEWER
  - PROP. STORM
  - PROP. STORM STRUCTURE

COVENTRY SELF STORAGE

PREPARED FOR

NOOSENECK HILL COVENTRY, LLC

1920 NOOSENECK HILL RD

COVENTRY, RI 02816

COVENTRY

AP 10 LOT 31

RHODE ISLAND

SHEET NUMBER

C-4.1

Kimley»Horn

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271 WAVERLEY OAKS RD, SUITE 302, WALTHAM, MA 02452

PHONE: 781-328-0676

WWW.KIMLEY-HORN.COM

BRIAN J. BREWER

REGISTERED PROFESSIONAL ENGINEER (CIVIL)

No. 8946

DATE

7/1/2024

SCALE

AS SHOWN

DESIGNED BY

CGA

DRAWN BY

CGA

CHECKED BY

BB

PROJECT

112704000

DATE

7/1/2024

SCALE

AS SHOWN

DESIGNED BY

CGA

DRAWN BY

CGA

CHECKED BY

BB

PRELIMINARY PLAN APPROVAL

06/27/2025

MJD

REVISED PER RIDEW COMMENTS

09/09/2024







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REVISIONS






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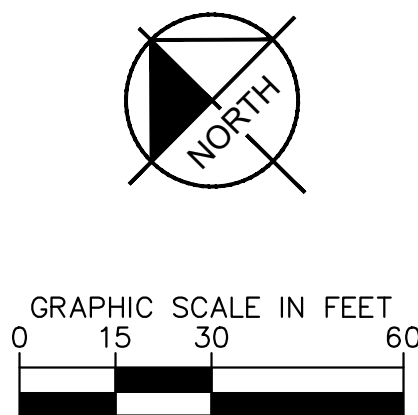
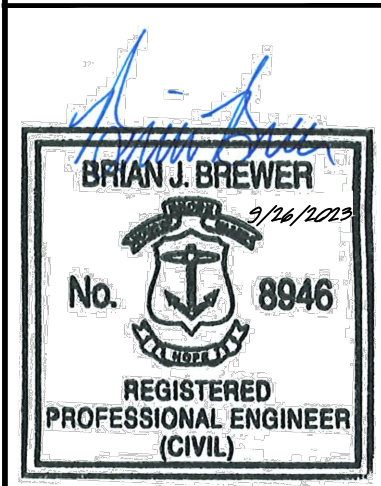
BY





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KHA PROJECT 112704000	DATE 7/1/2024	SCALE AS SHOWN	DESIGNED BY CGA	DRAWN BY CGA	CHECKED BY BB
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# OVERALL GRADING AND DRAINAGE PLAN

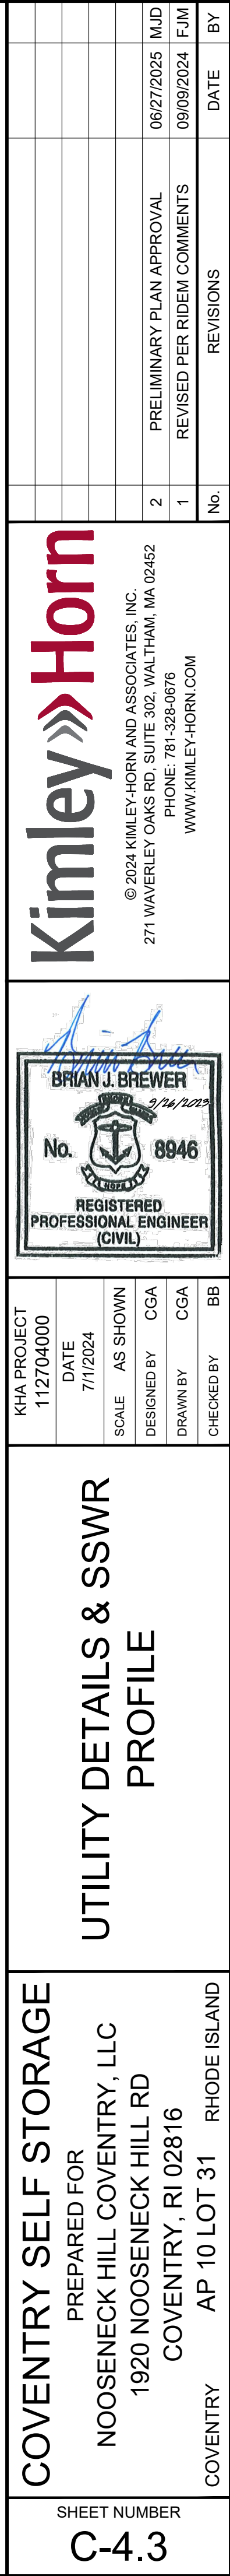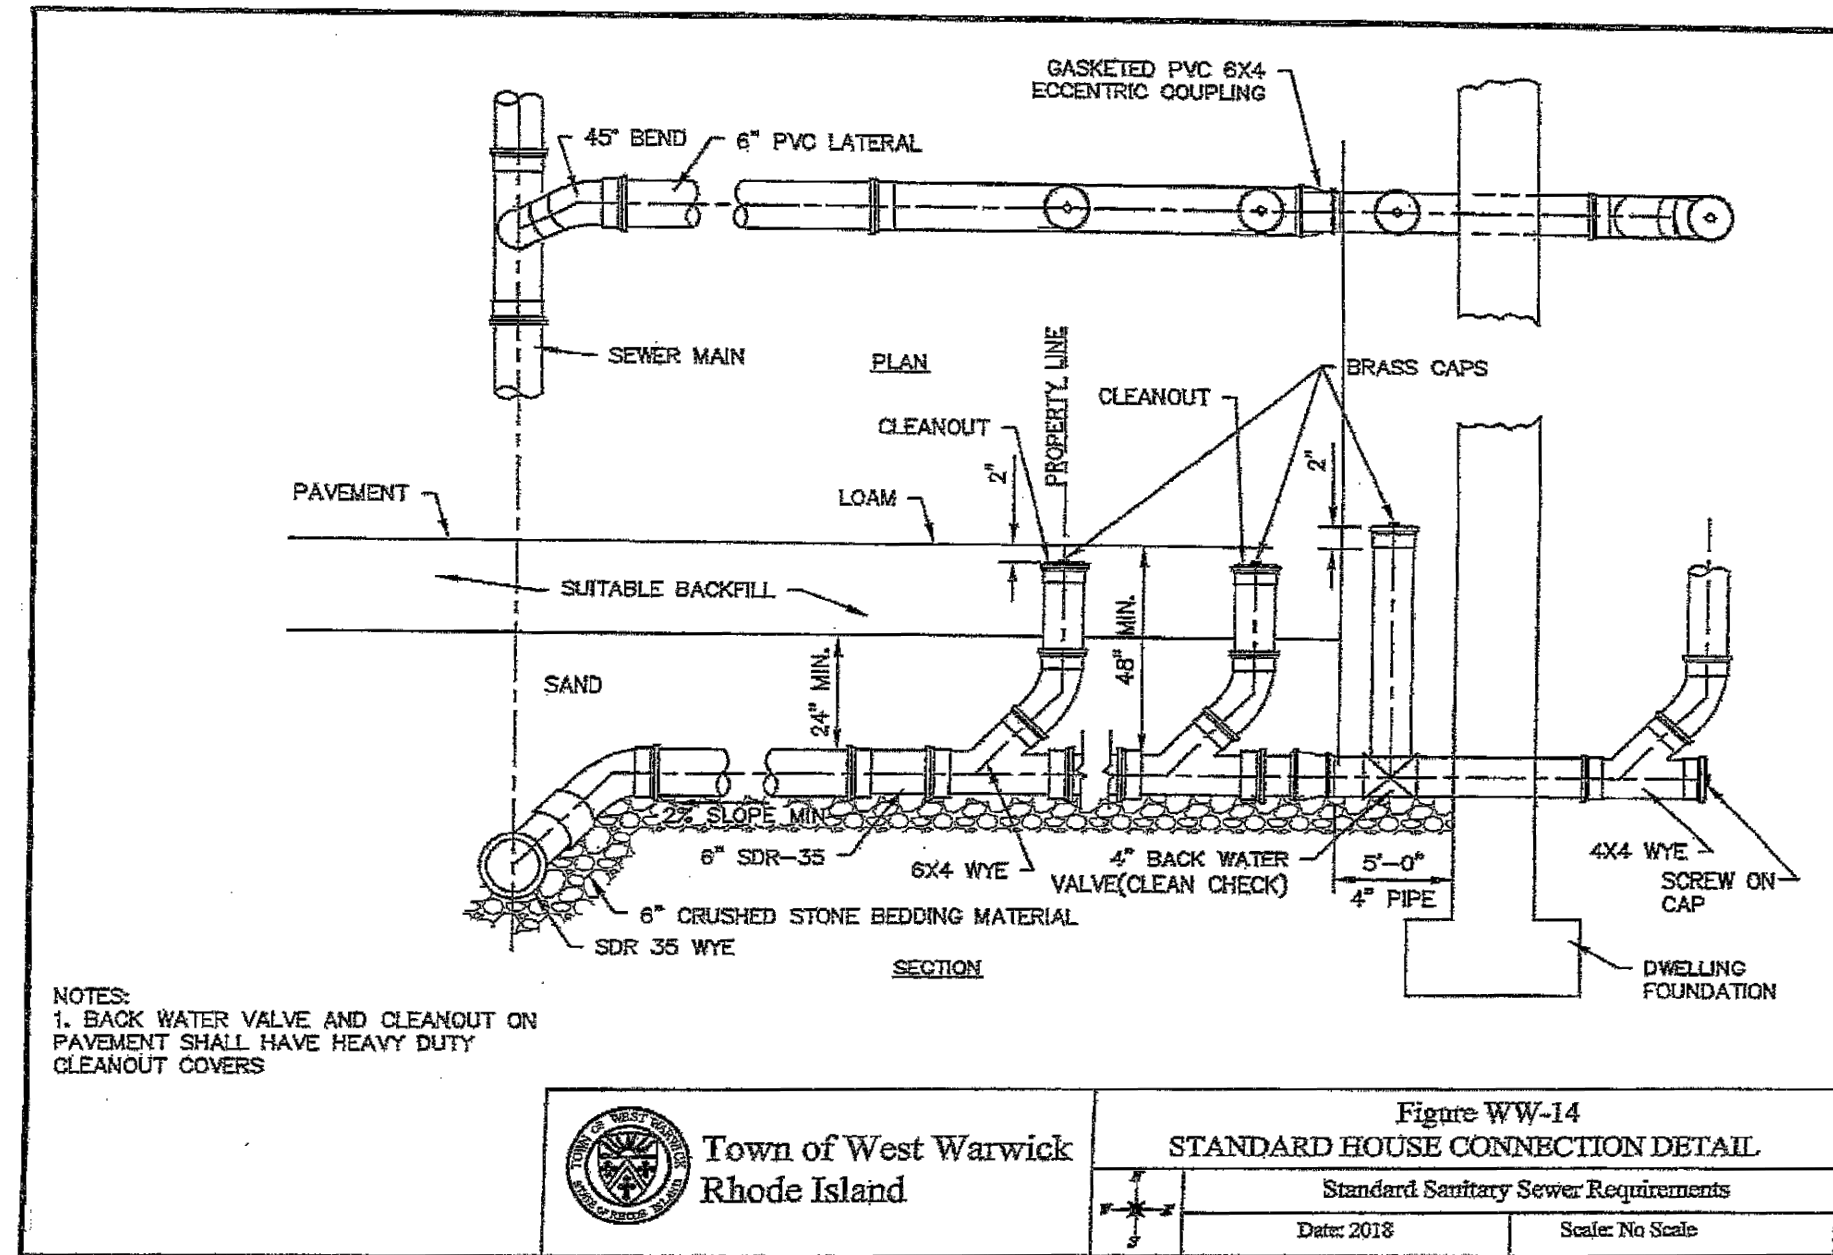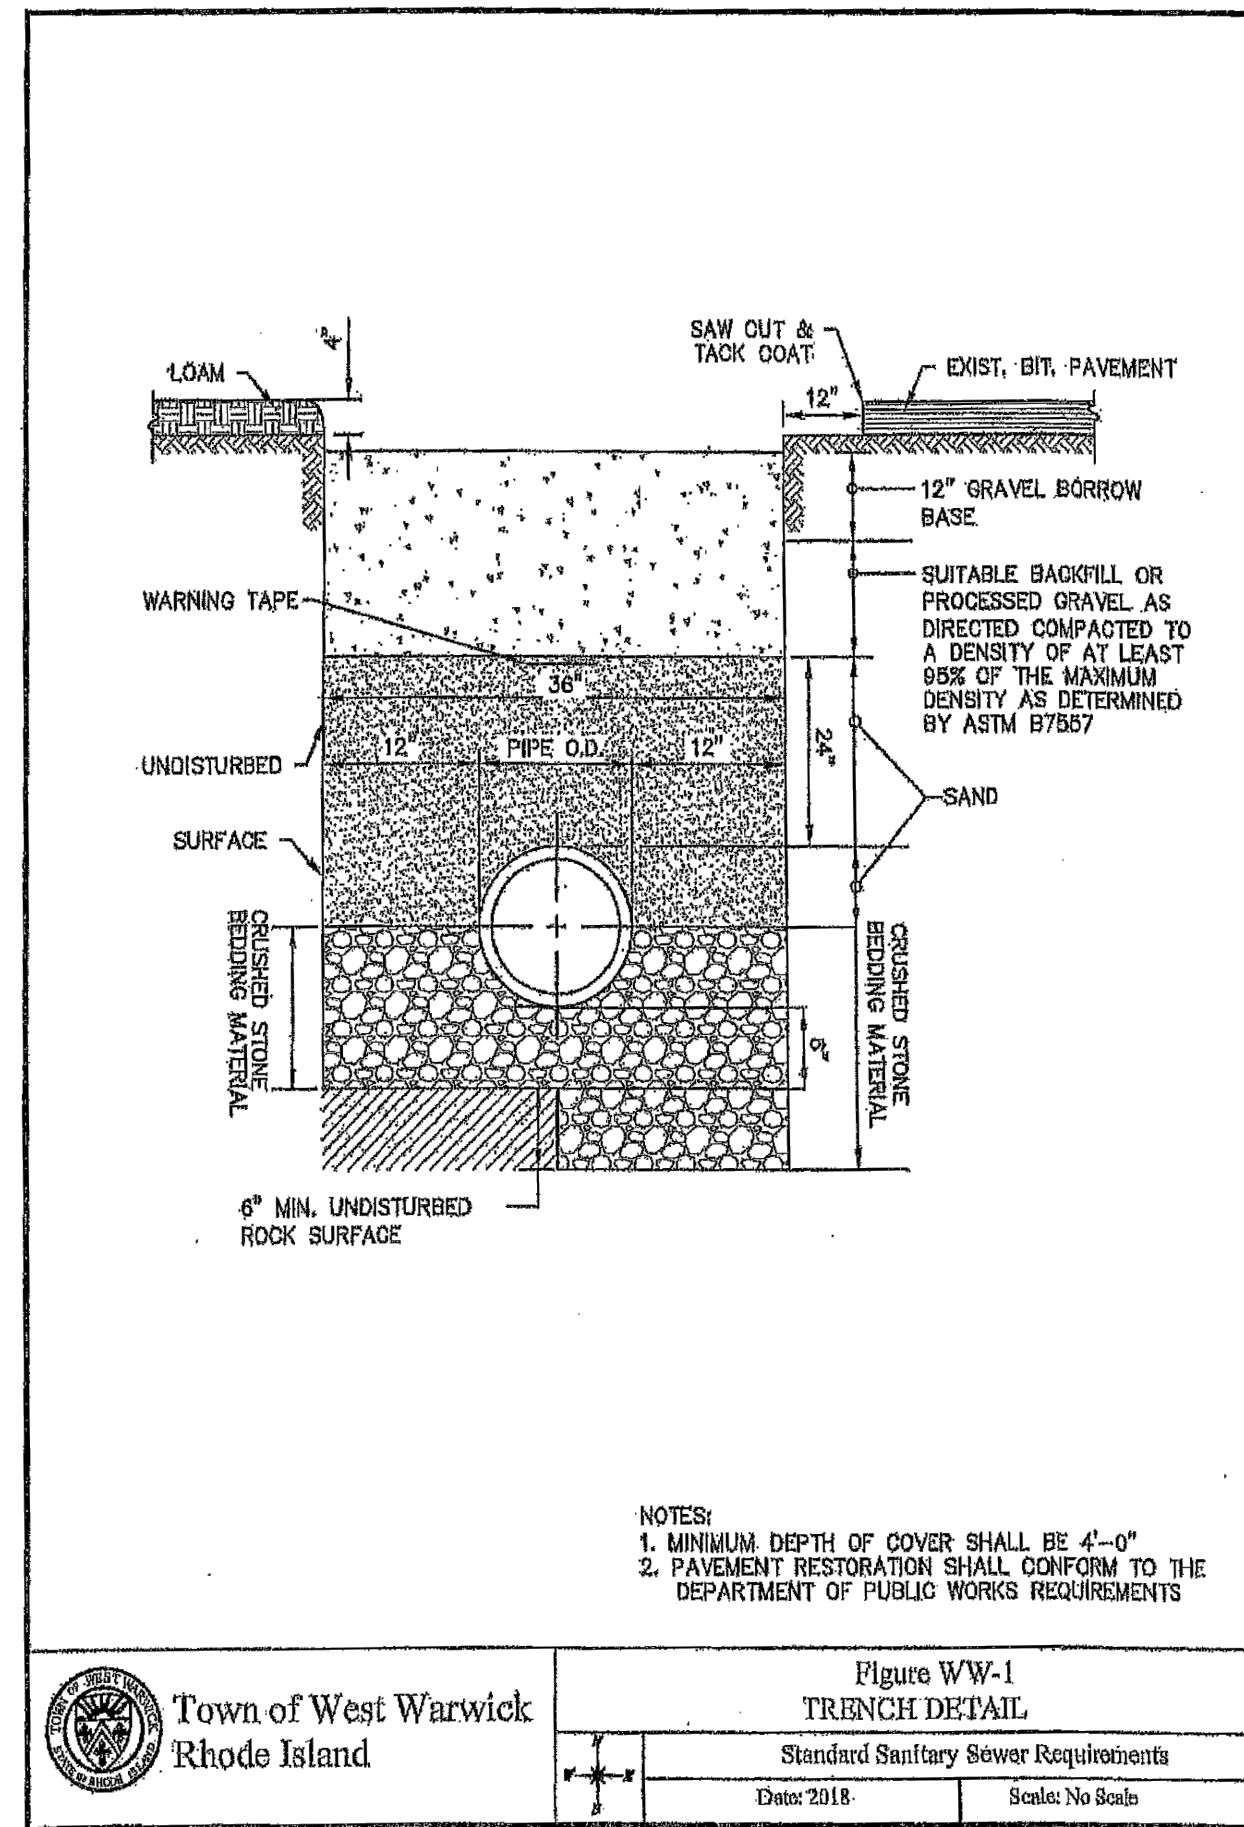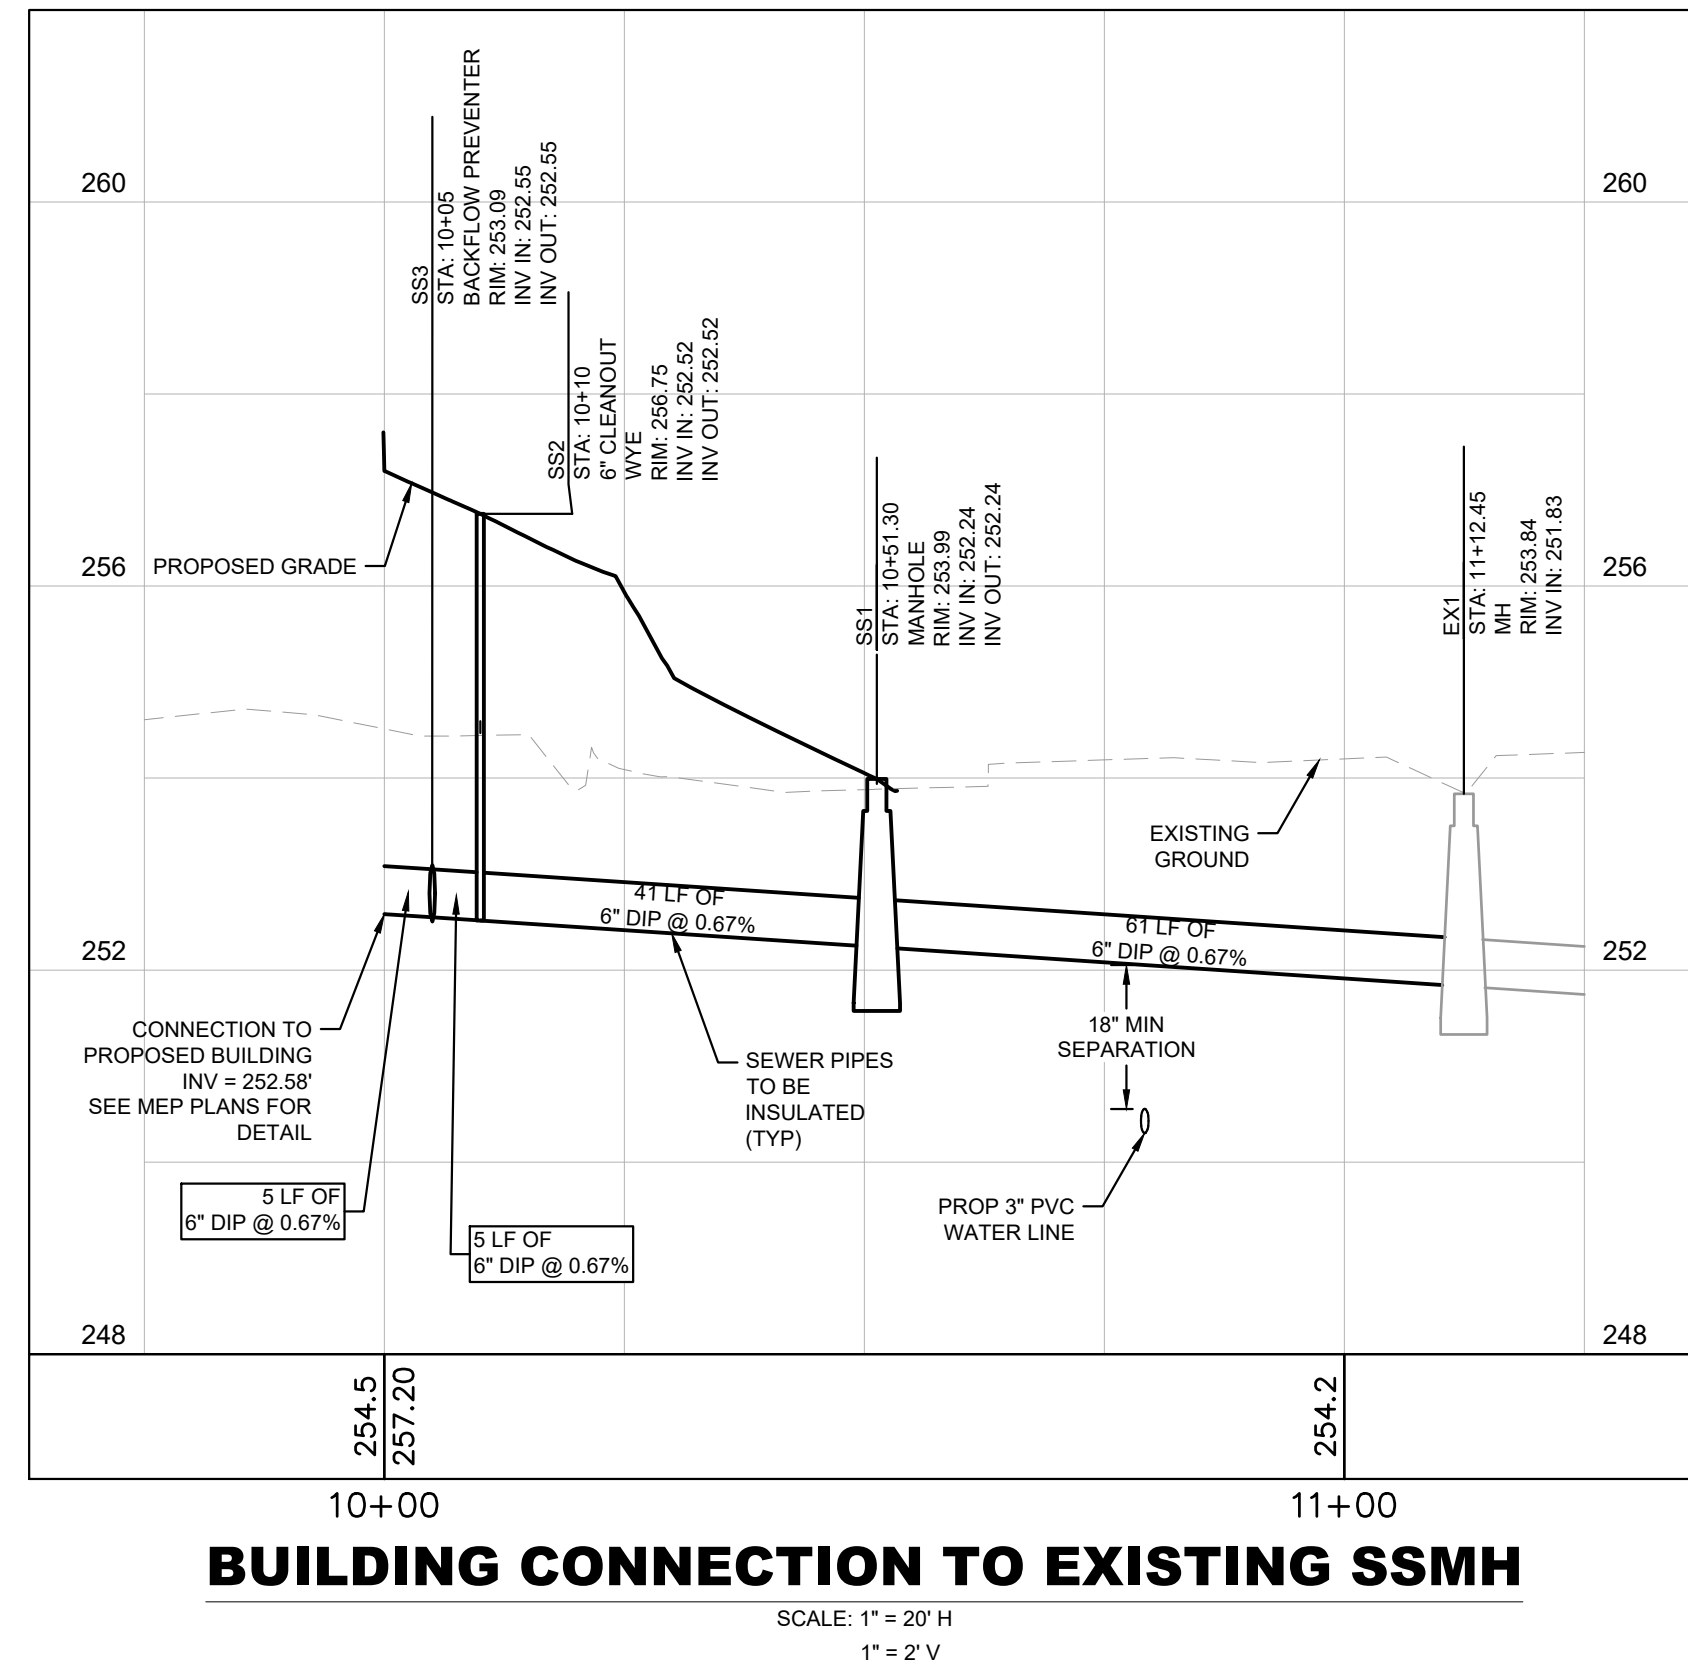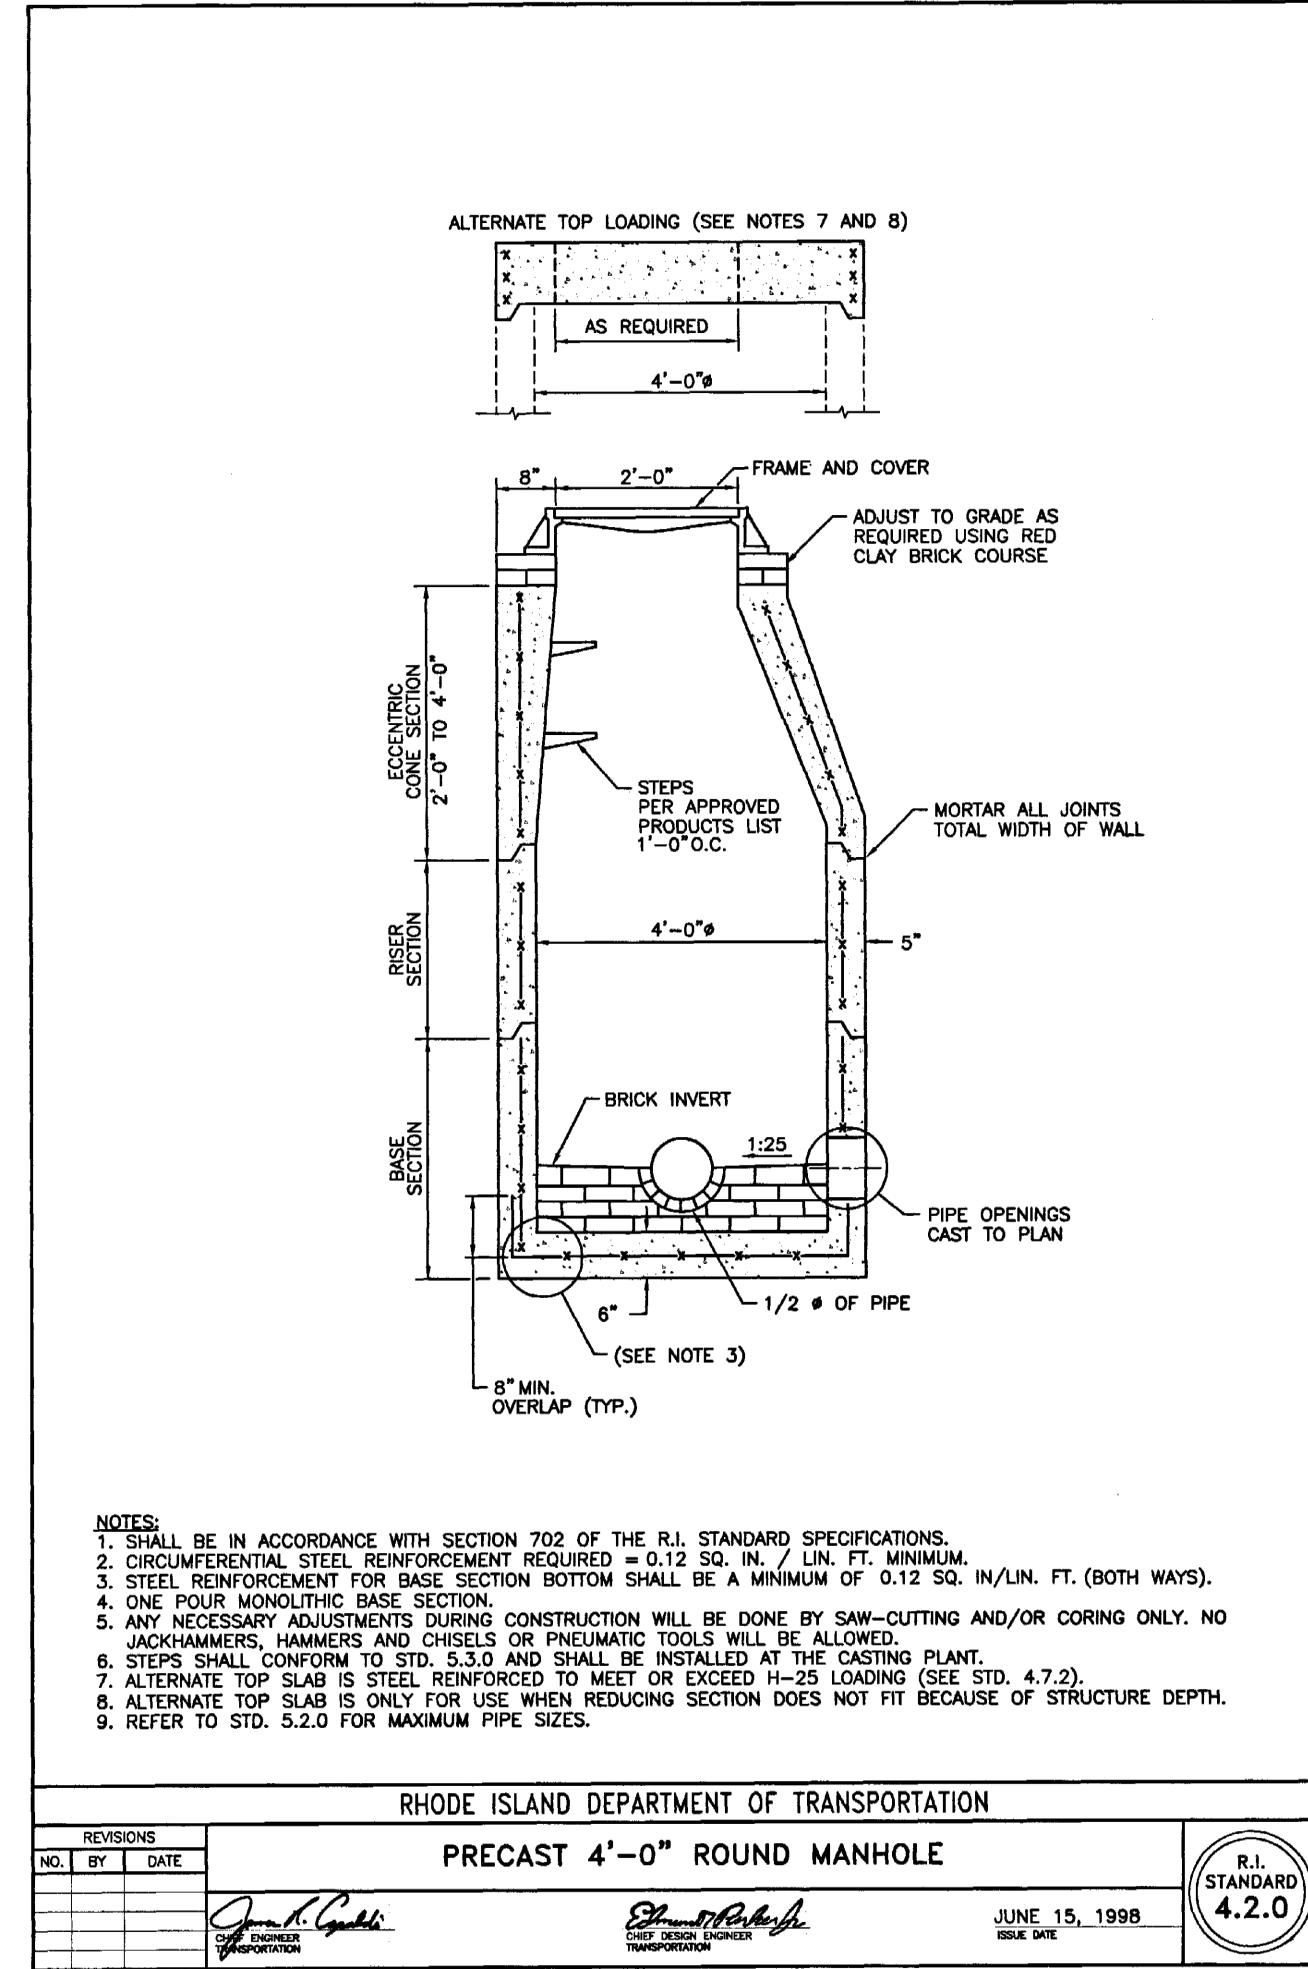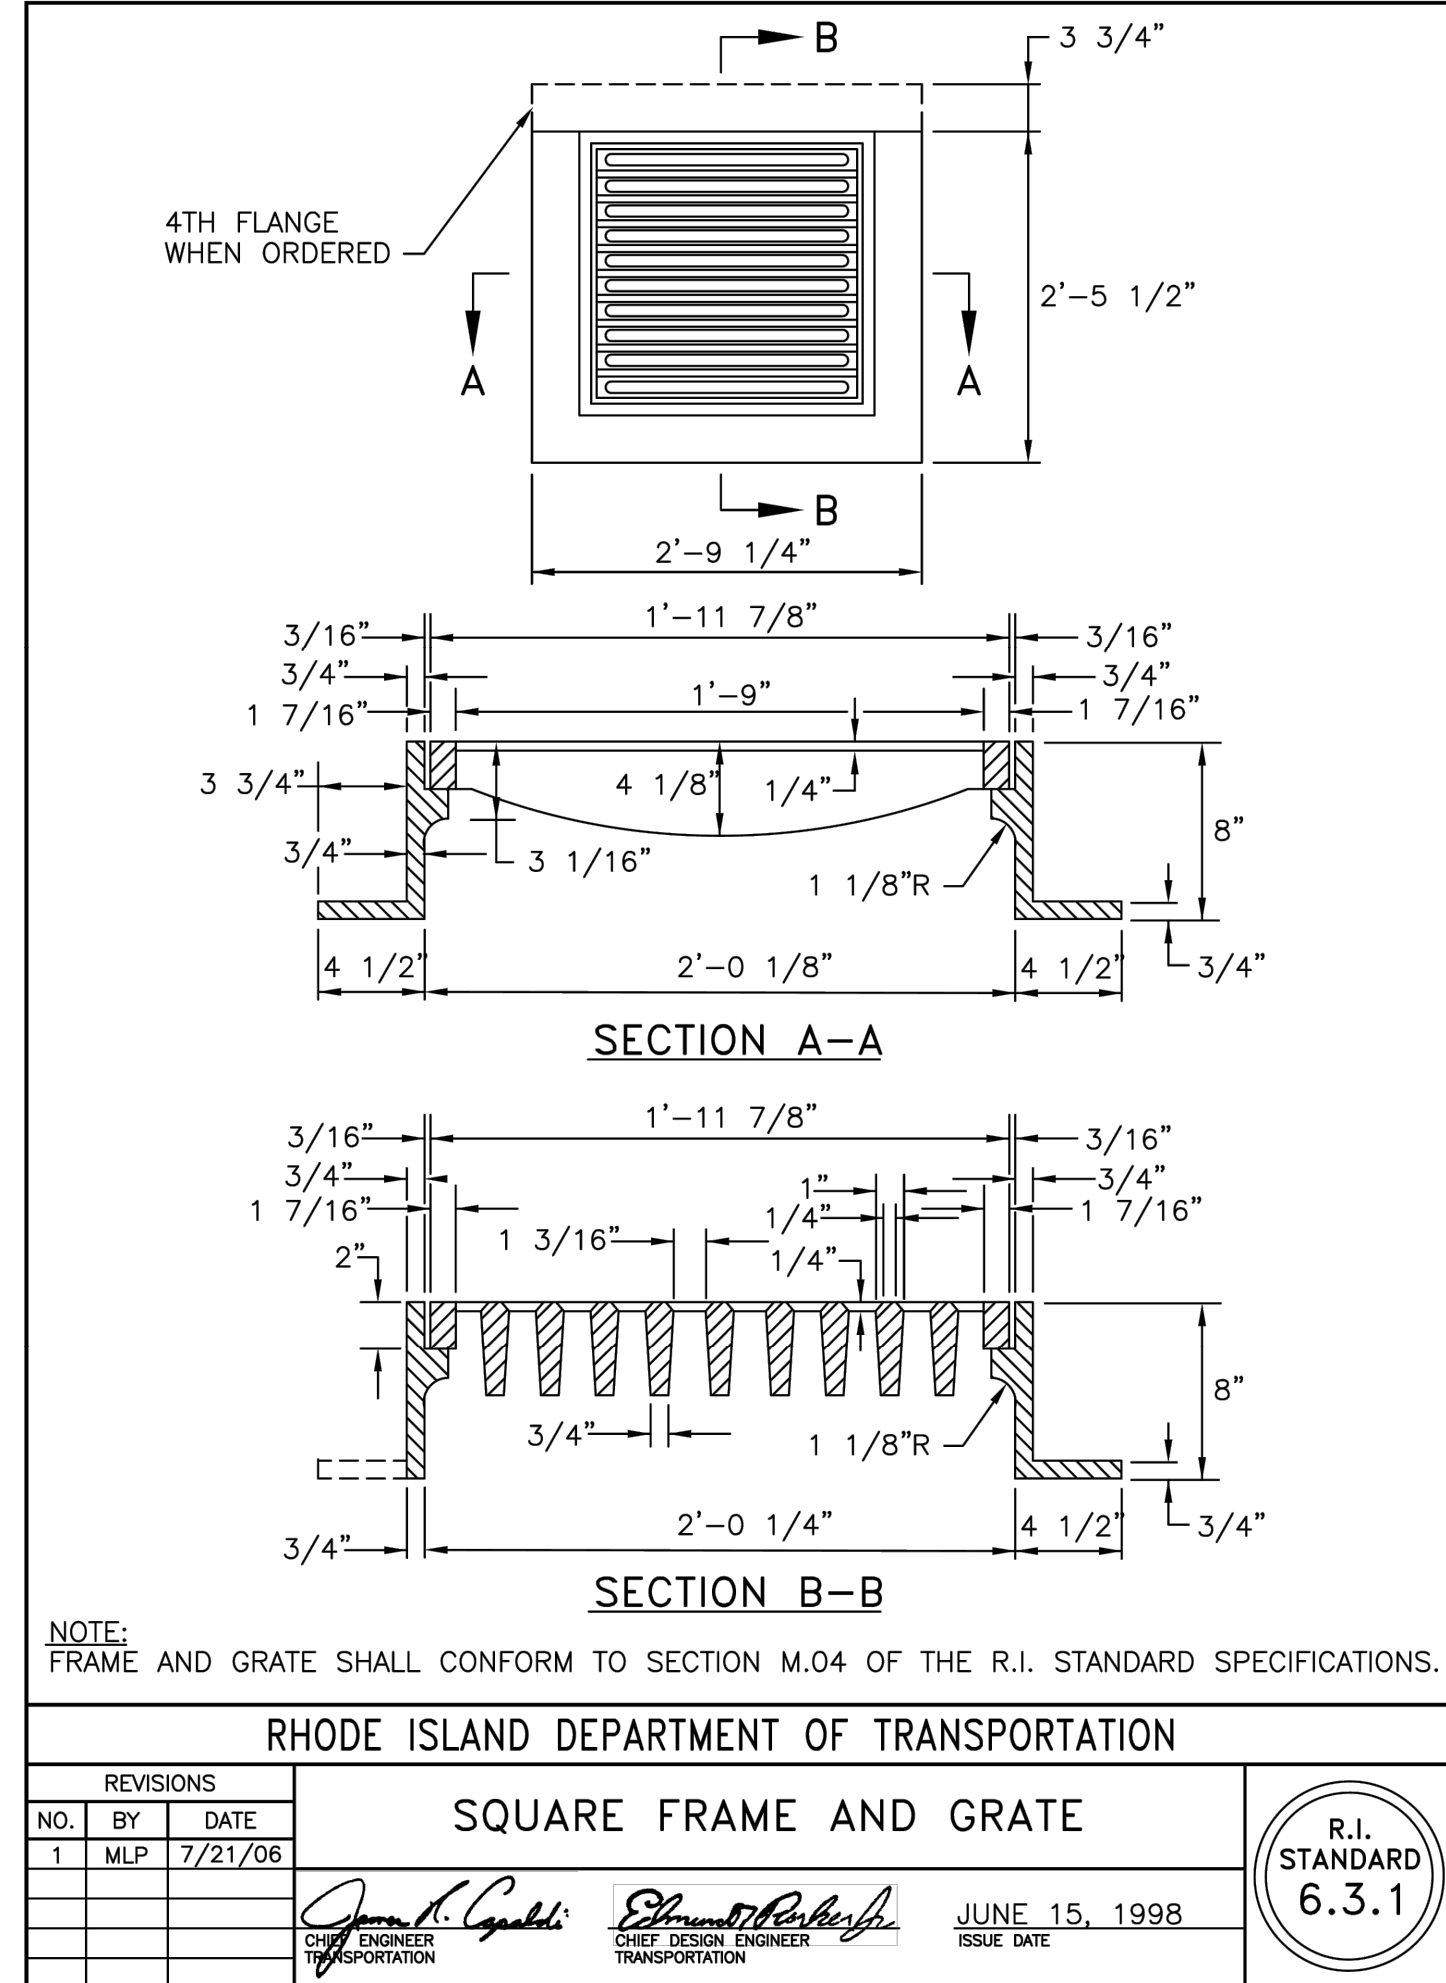COVENTRY SELF STORAGE  
PREPARED FOR  
NOOSENECK HILL COVENTRY, LLC  
1920 NOOSENECK HILL RD  
COVENTRY, RI 02816  
COVENTRY AP 10 LOT 31 RHODE ISLAND

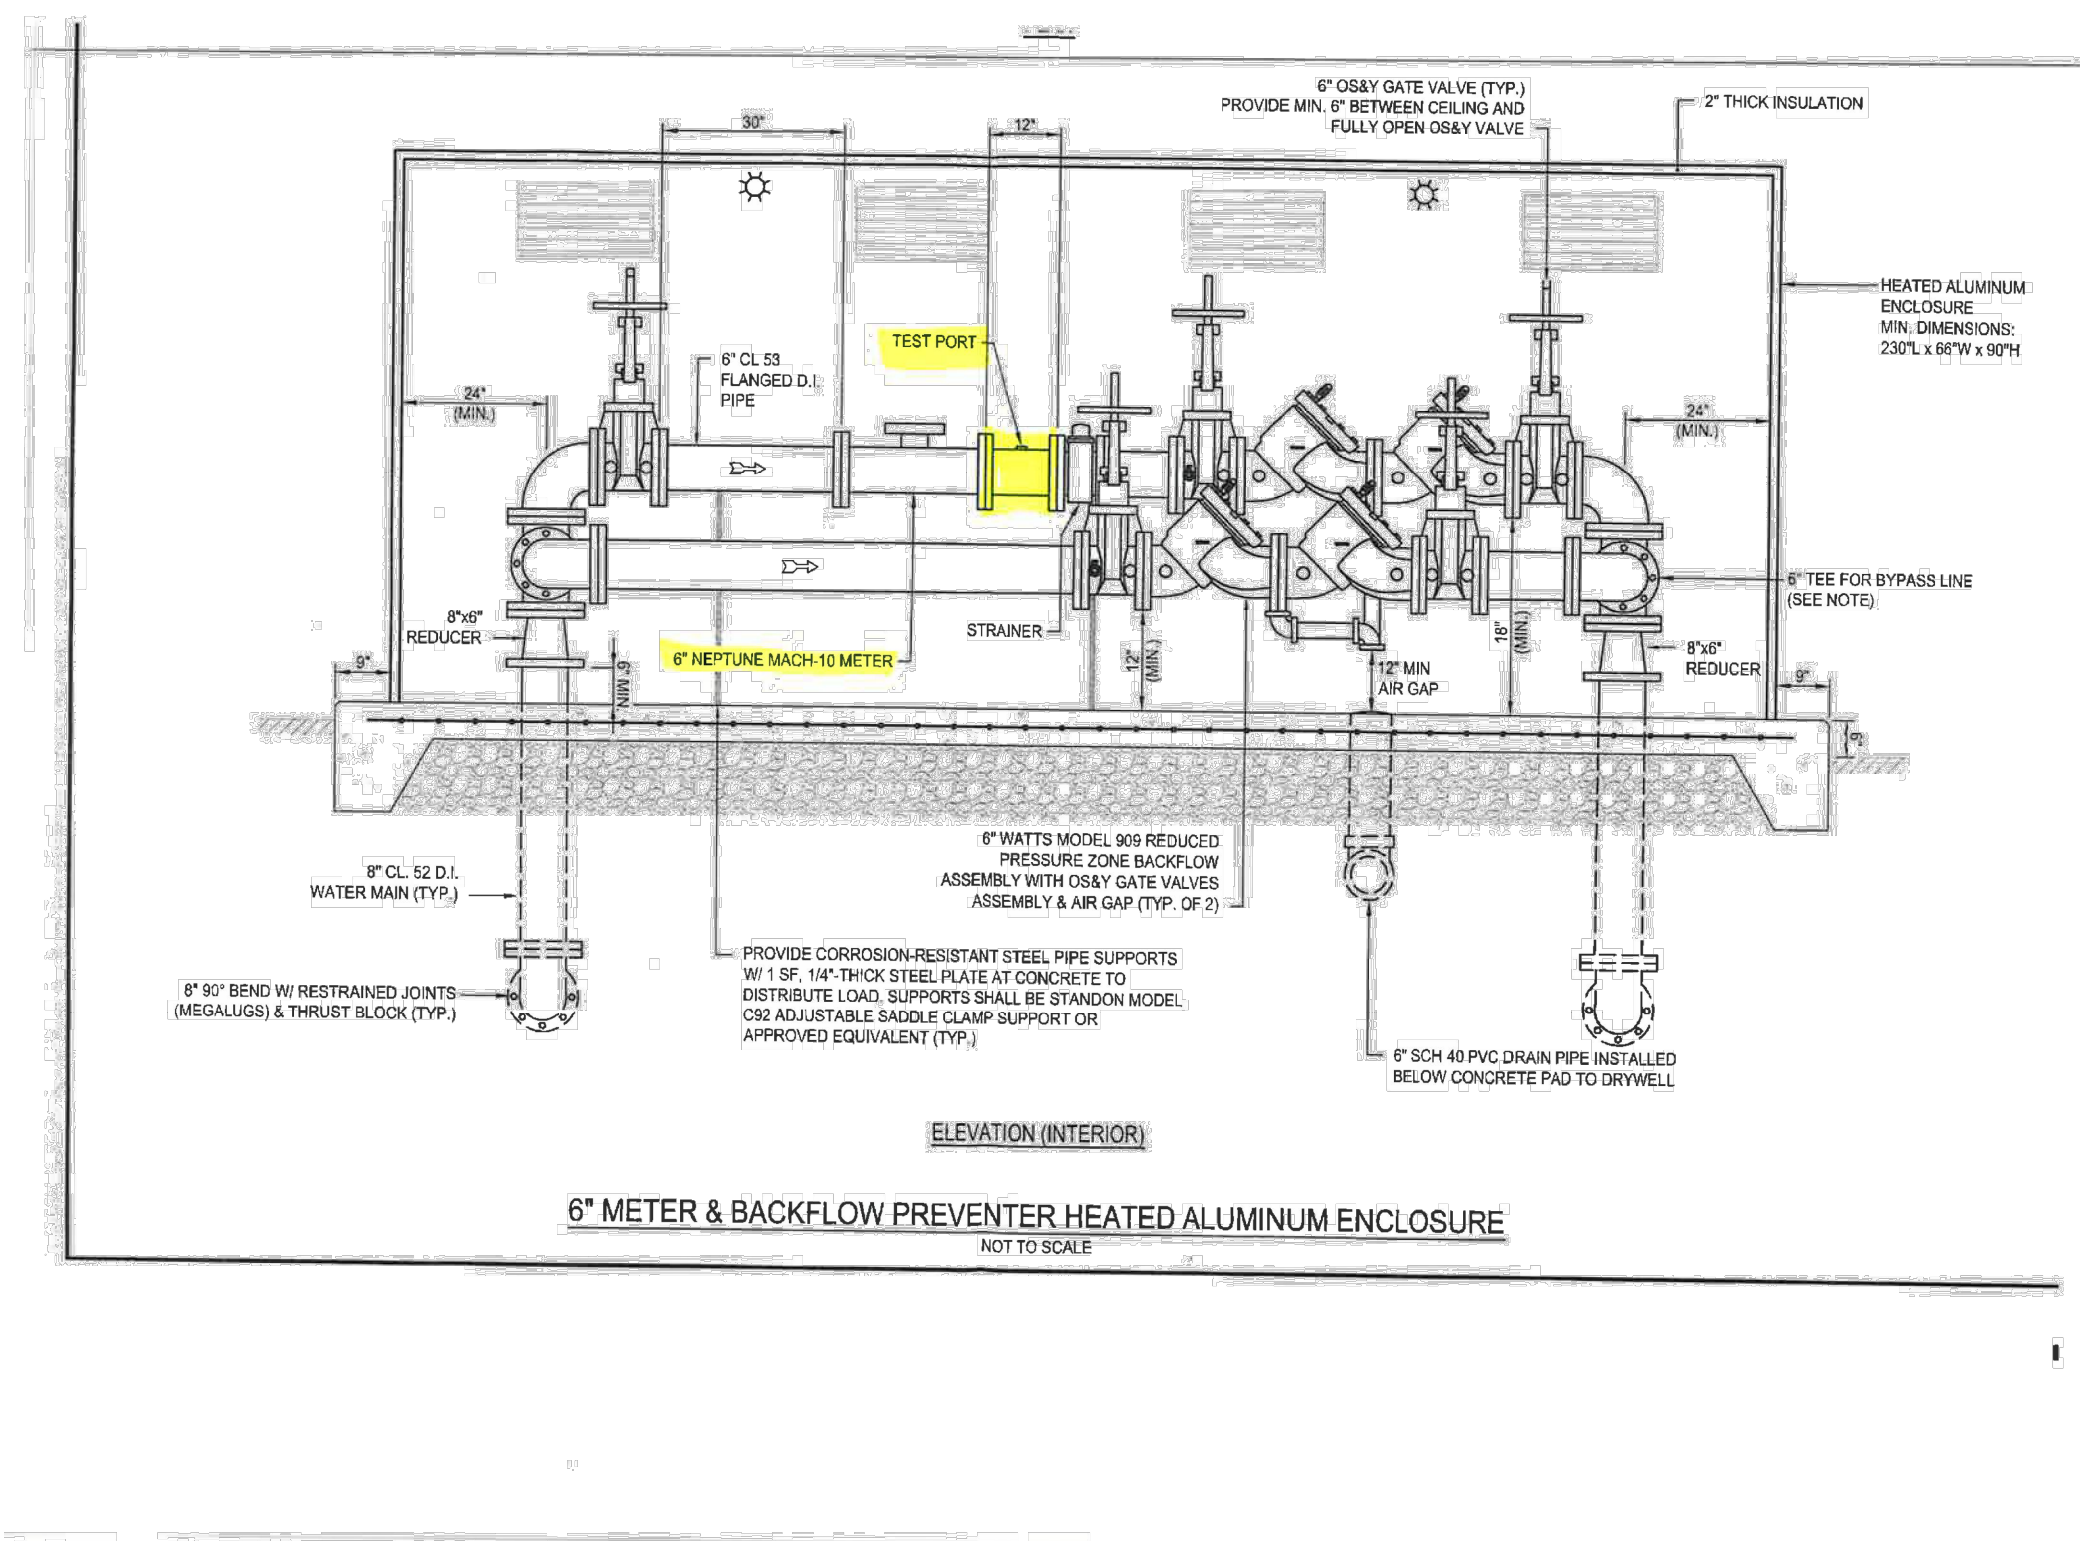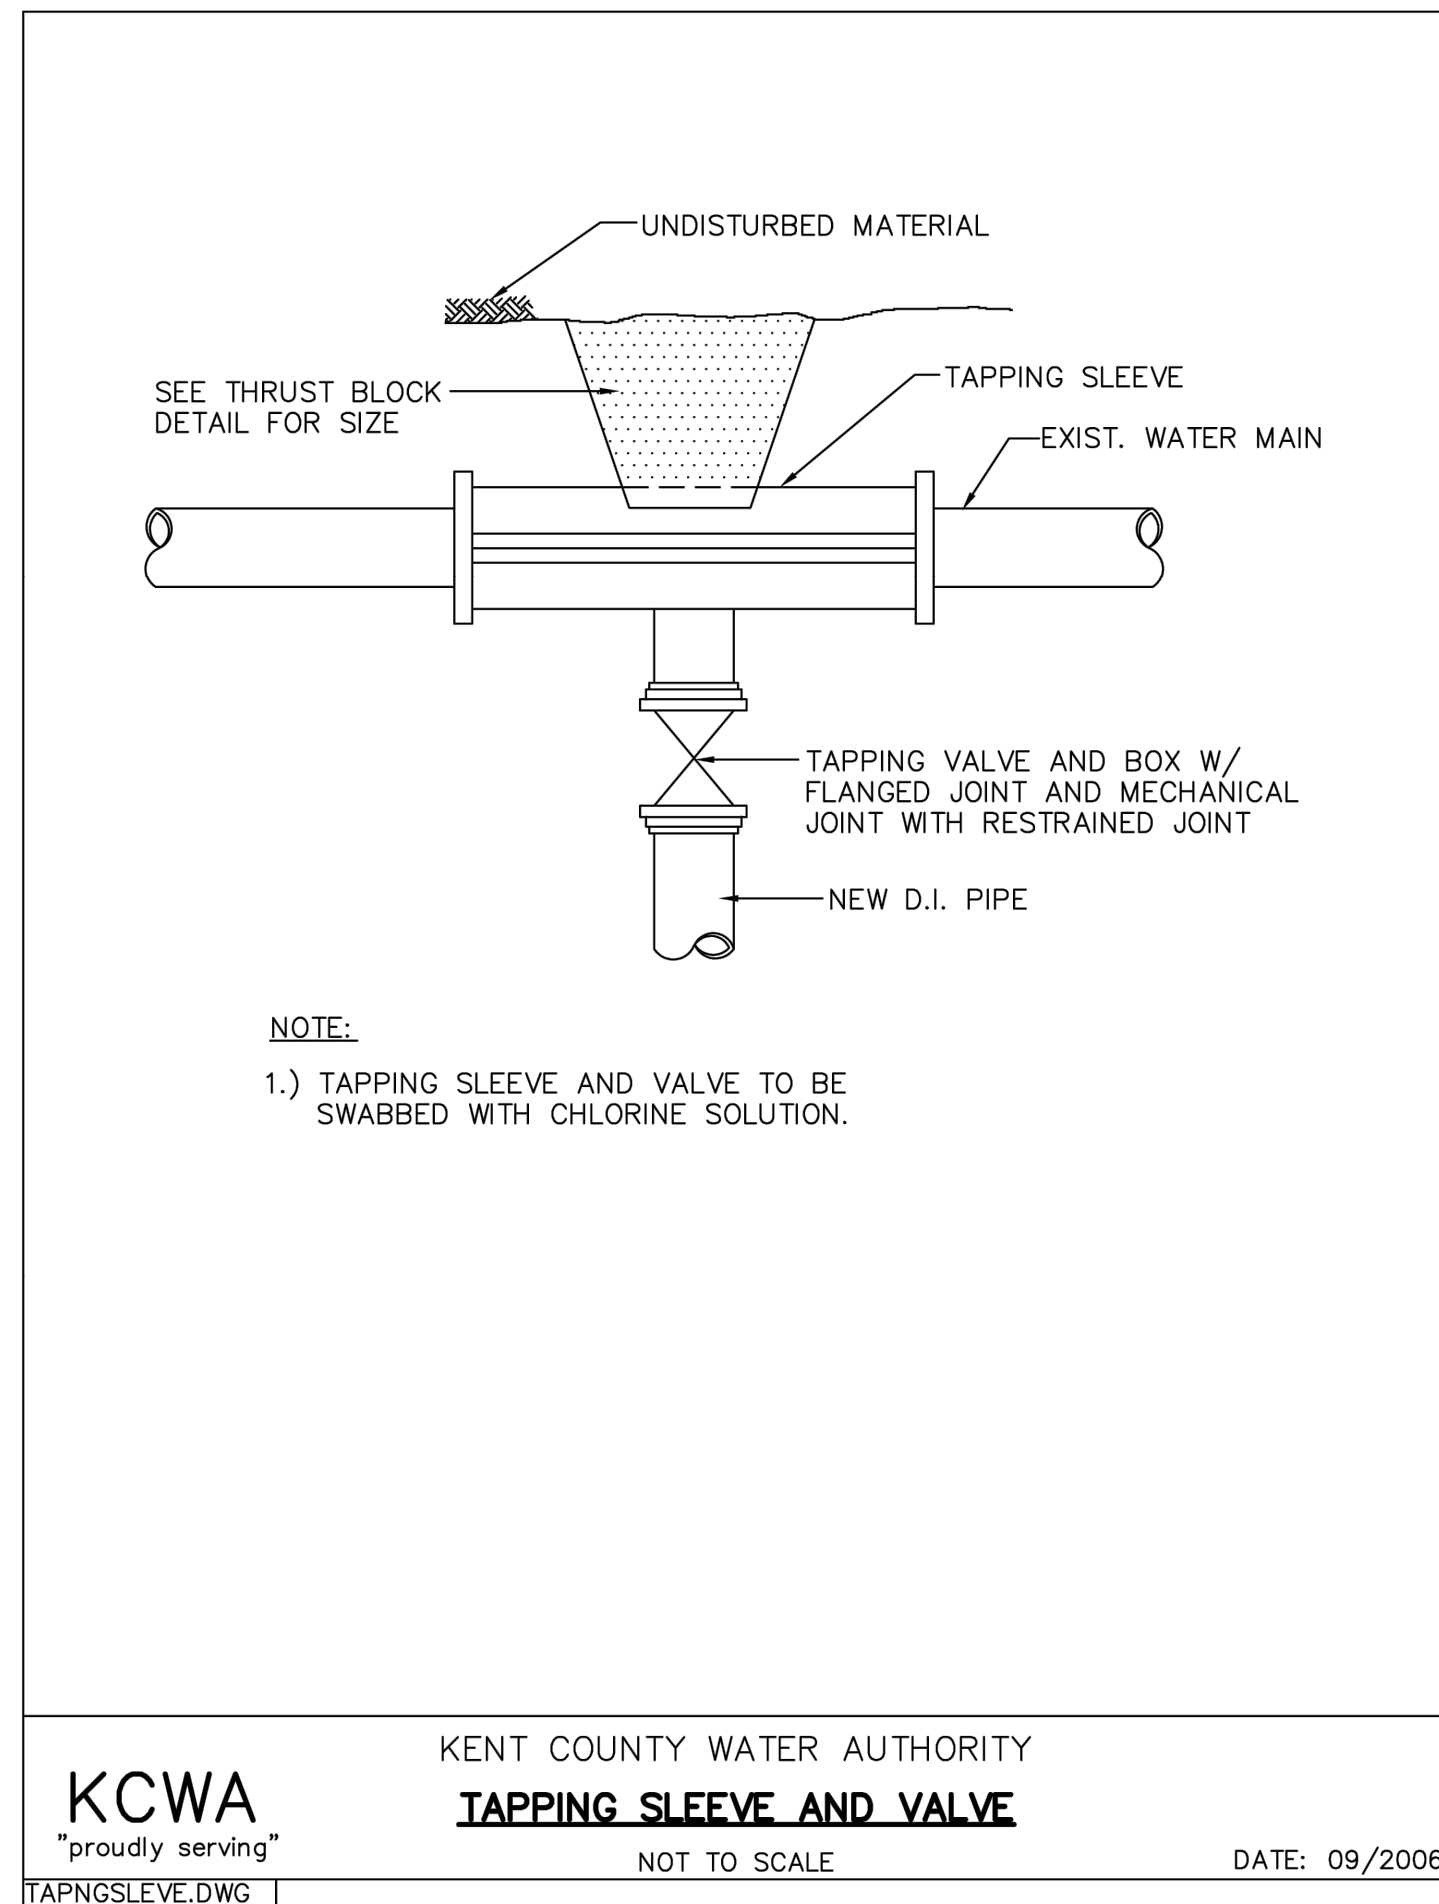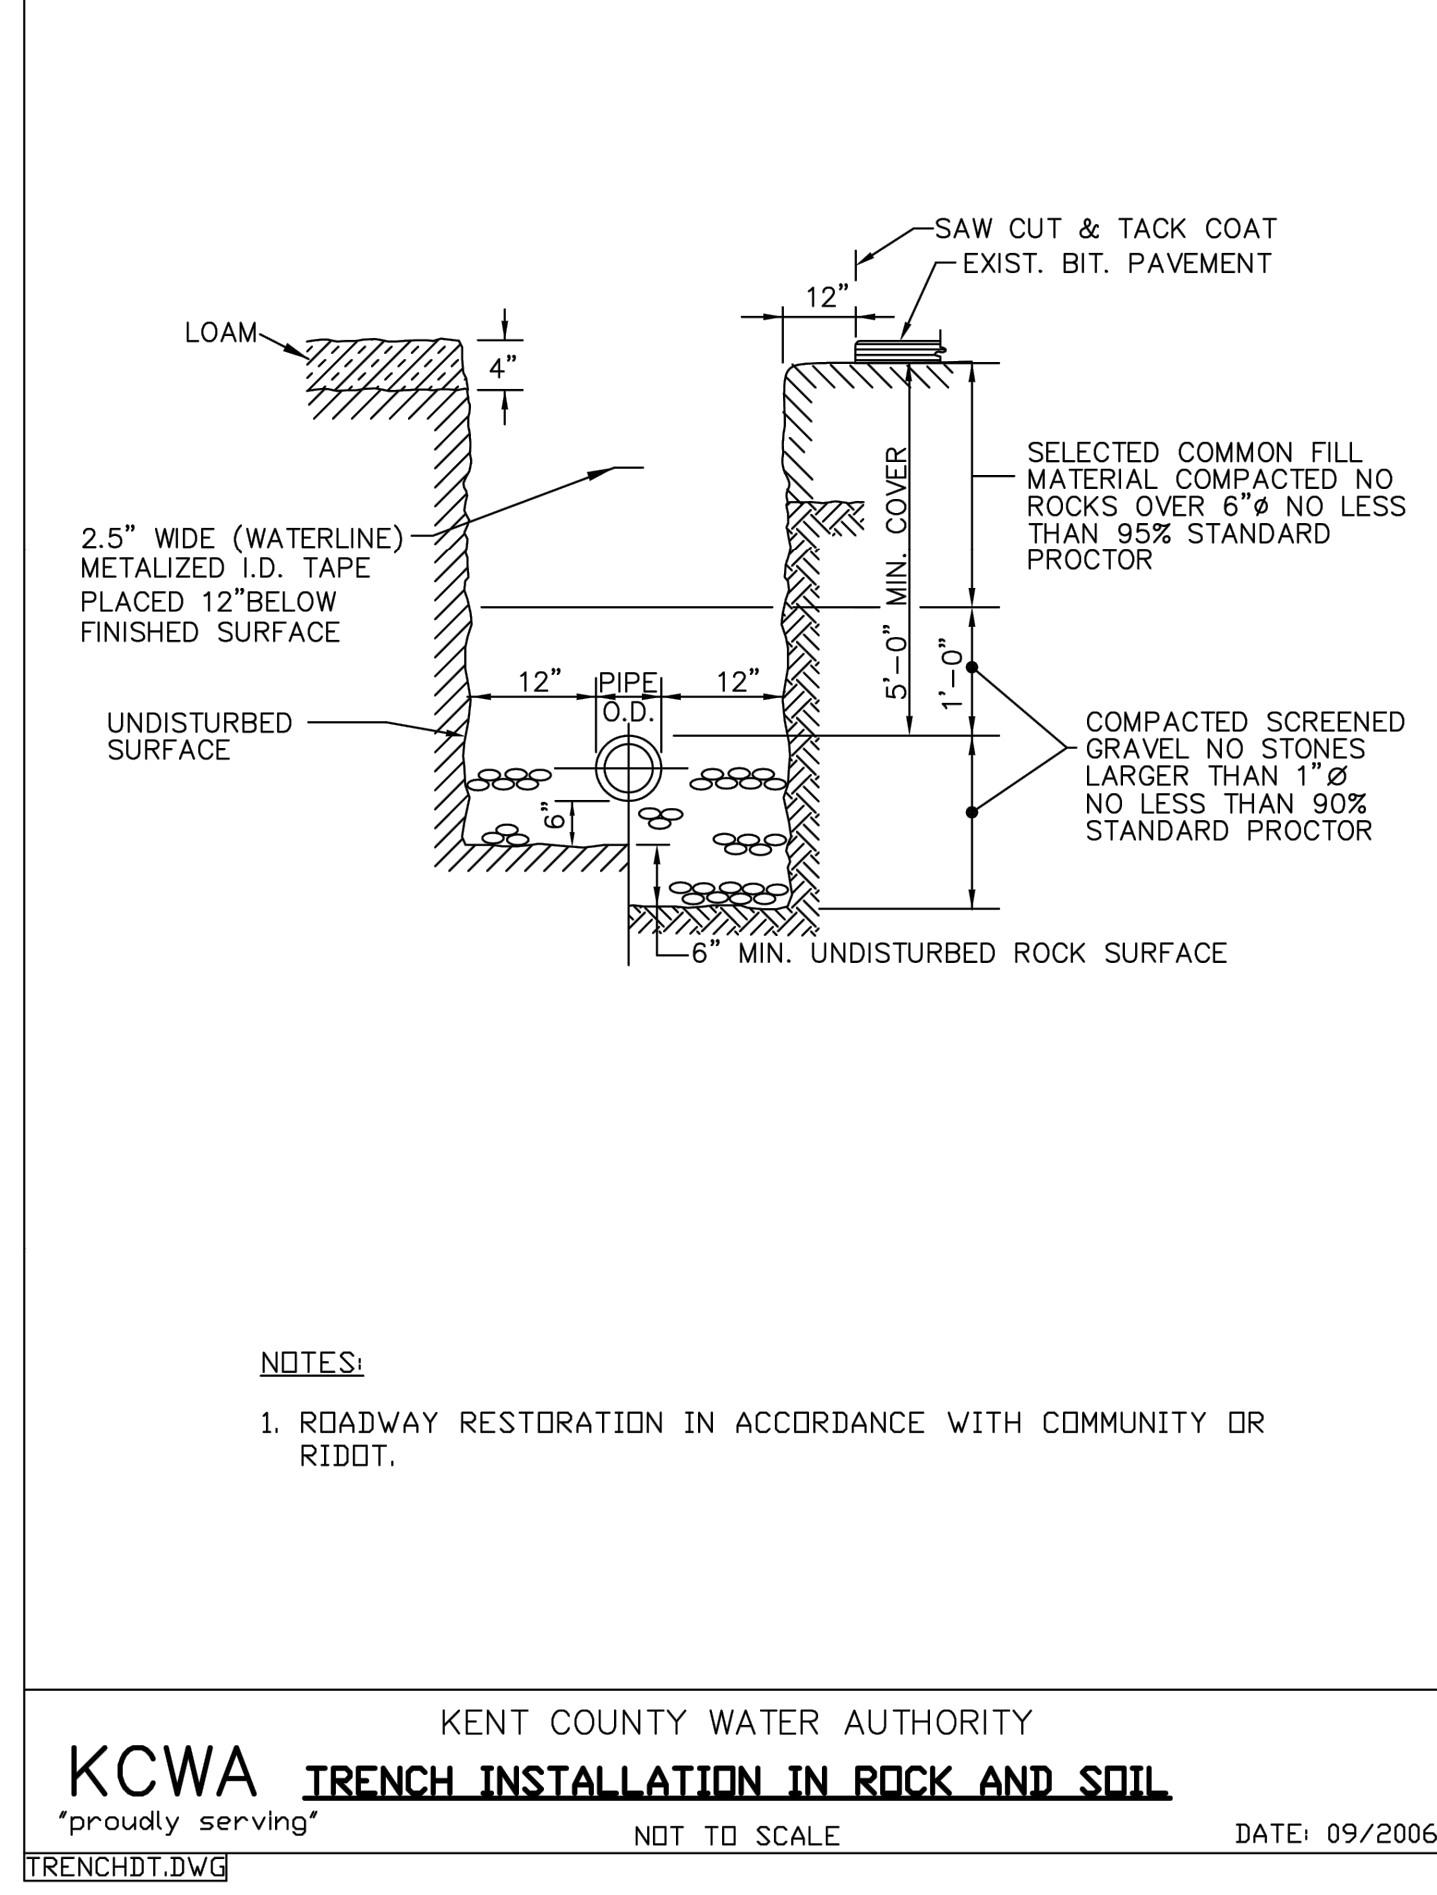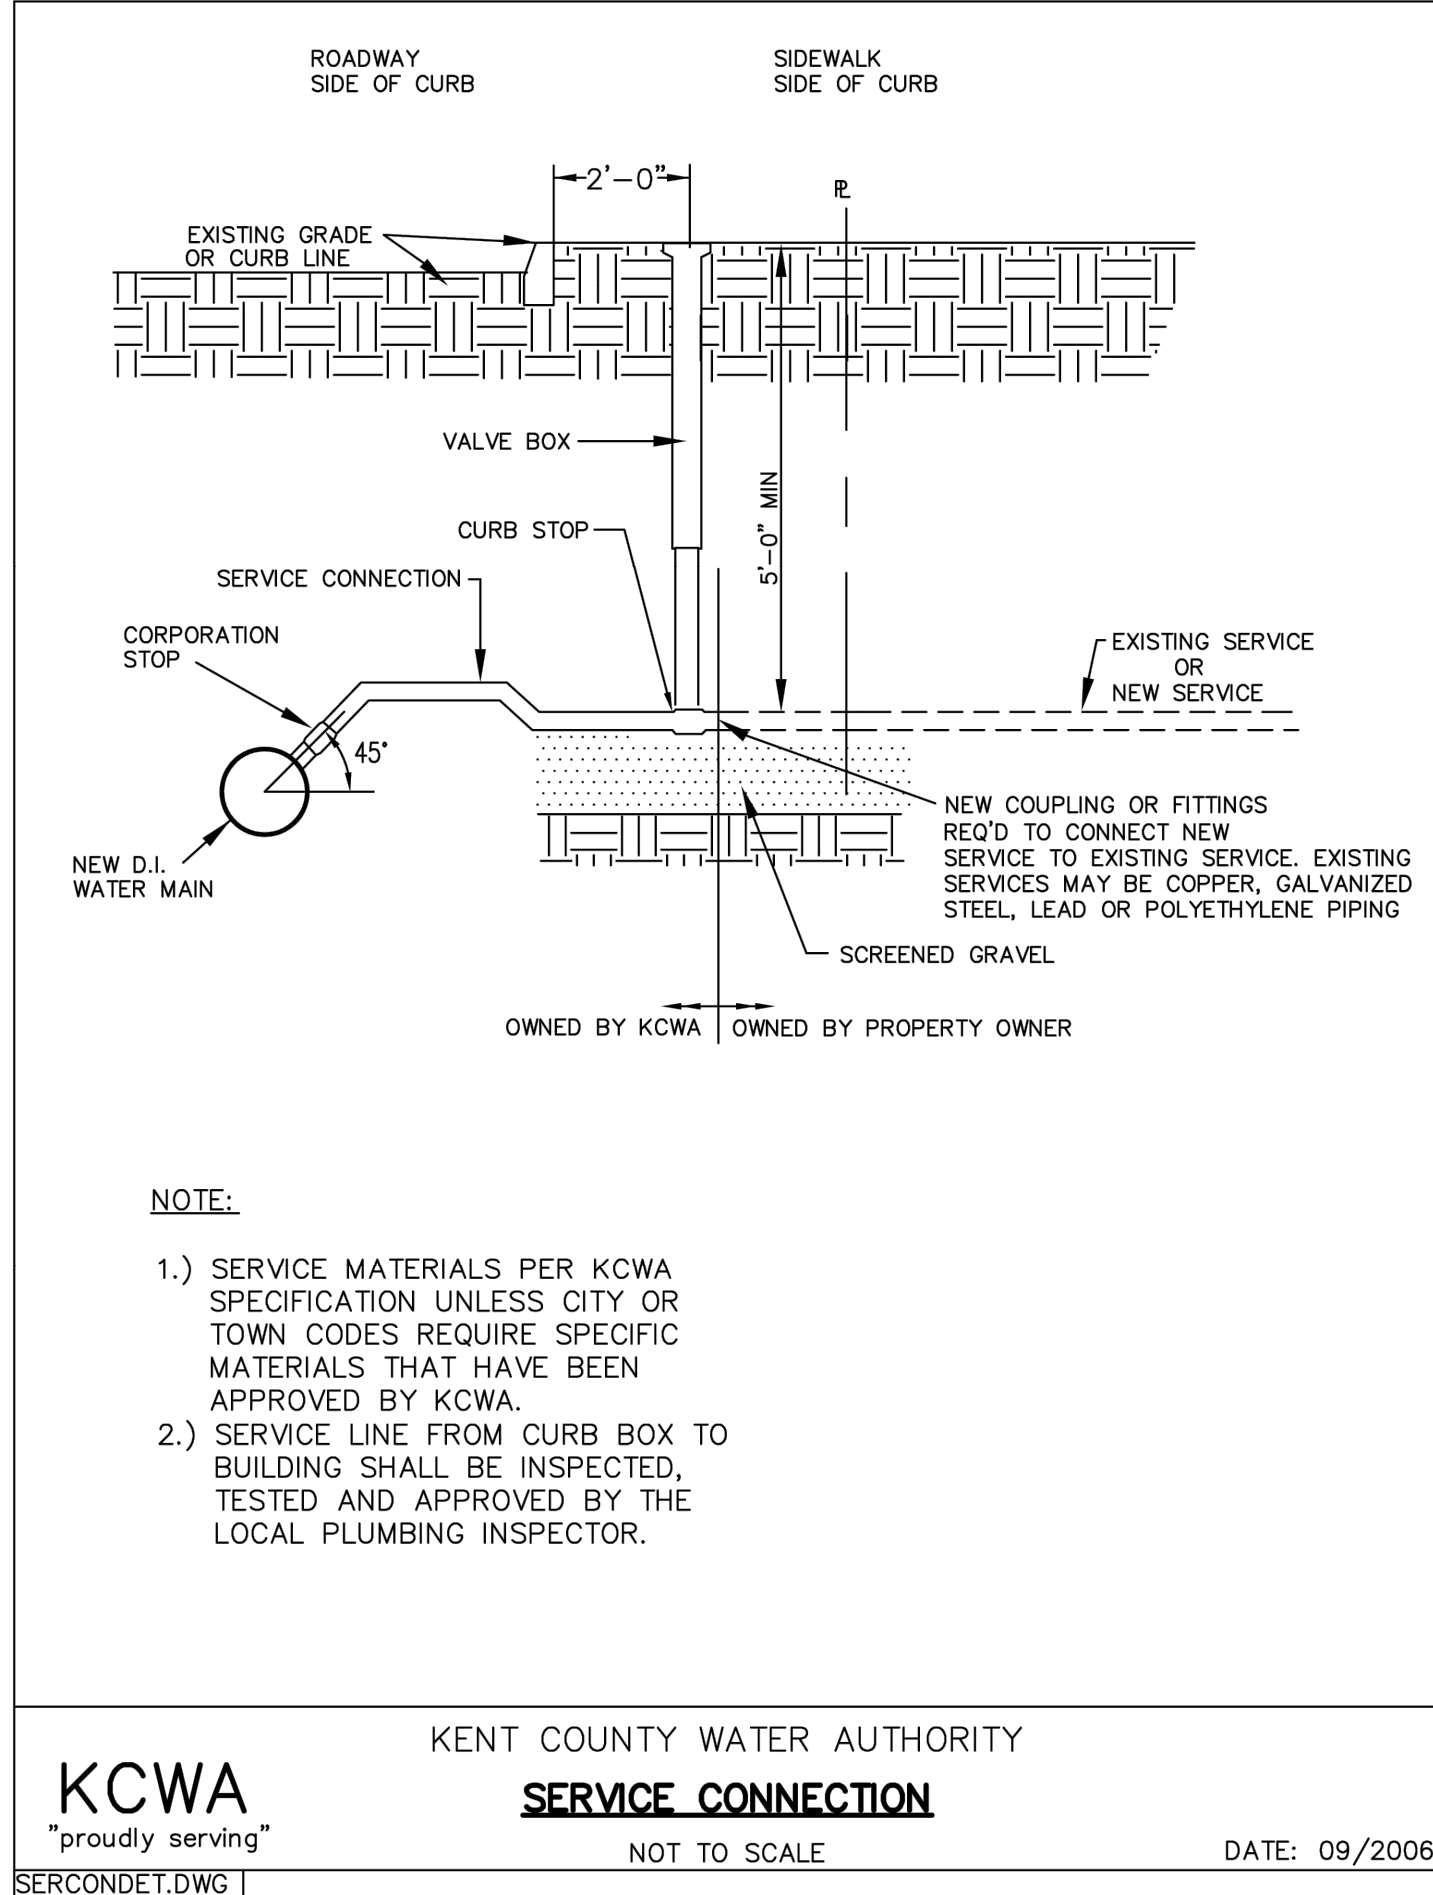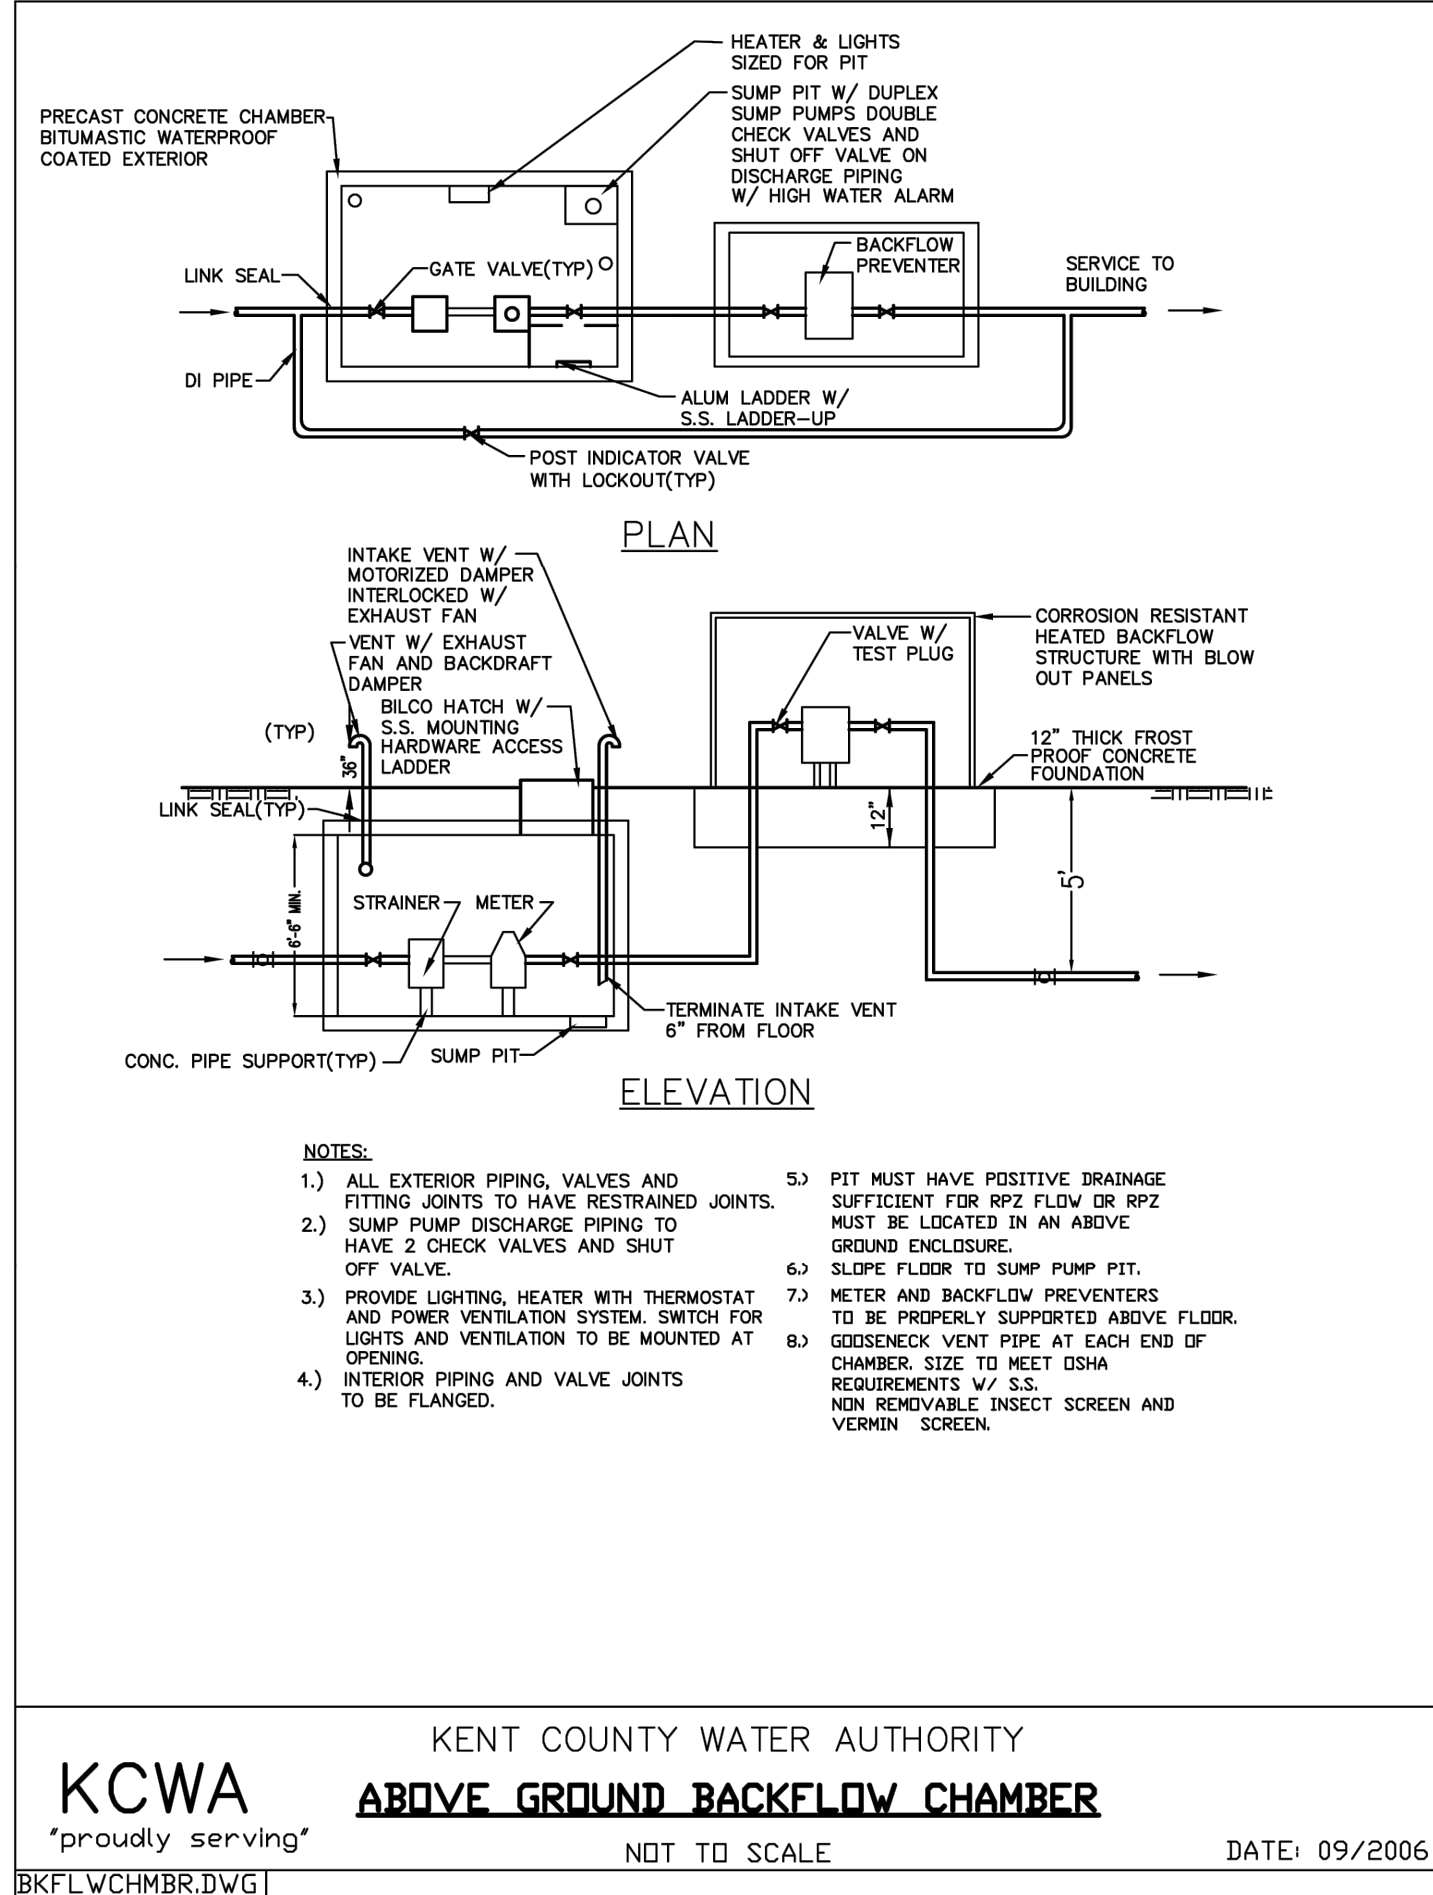SHEET NUMBER  
C-5.0

1. ALL PAVING, CONSTRUCTION, MATERIALS, AND WORKMANSHIP WITHIN STATE AND TOWN RIGHT-OF-WAY SHALL BE IN ACCORDANCE WITH LOCAL OR STATE SPECIFICATIONS AND STANDARDS (LATEST EDITION) OR RIDOT SPECIFICATIONS AND STANDARDS (LATEST EDITION) IF NOT COVERED BY STATE OR TOWN REGULATIONS.
2. ALL UNPAVED AREAS IN EXISTING RIGHTS-OF-WAY DISTURBED BY CONSTRUCTION SHALL BE REGRADED AND SODDED.
3. TRAFFIC CONTROL ON ALL TOWN AND STATE RIGHTS-OF-WAY SHALL MEET THE REQUIREMENTS OF THE MANUAL OF UNIFORM TRAFFIC CONTROL DEVICES (U.S. DOT/FHA) AND THE REQUIREMENTS OF THE STATE AND ANY LOCAL AGENCY HAVING JURISDICTION. IN THE EVENT THAT THE CONTRACT DOCUMENTS AND THE JURISDICTIONAL AGENCY REQUIREMENTS ARE NOT IN AGREEMENT, THE MOST STRINGENT SHALL GOVERN.
4. THE CONTRACTOR SHALL GRADE THE SITE TO THE ELEVATIONS INDICATED AND SHALL REGRADE WASHOUTS WHERE THEY OCCUR AFTER EVERY RAINFALL UNTIL A GRASS STAND IS WELL ESTABLISHED OR ADEQUATE STABILIZATION OCCURS.
5. ALL OPEN AREAS WITHIN THE PROJECT SITE SHALL BE SODDED UNLESS INDICATED OTHERWISE ON THE LANDSCAPE PLAN.
6. ALL AREAS INDICATED AS PAVEMENT SHALL BE CONSTRUCTED IN ACCORDANCE WITH THE TYPICAL PAVEMENT SECTIONS AS INDICATED ON THE DRAWINGS.
7. WHERE EXISTING PAVEMENT IS INDICATED TO BE REMOVED AND REPLACED, THE CONTRACTOR SHALL SAW CUT A MINIMUM 2" DEEP FOR A SMOOTH AND STRAIGHT JOINT AND REPLACE THE PAVEMENT WITH THE SAME TYPE AND DEPTH OF MATERIAL AS EXISTING OR AS INDICATED.
8. WHERE NEW PAVEMENT MEETS THE EXISTING PAVEMENT, THE CONTRACTOR SHALL SAW CUT THE EXISTING PAVEMENT A MINIMUM 2" DEEP FOR A SMOOTH AND STRAIGHT JOINT AND MATCH THE EXISTING PAVEMENT ELEVATION WITH THE PROPOSED PAVEMENT UNLESS OTHERWISE INDICATED.
9. THE CONTRACTOR SHALL INSTALL FILTER FABRIC OVER ALL DRAINAGE STRUCTURES FOR THE DURATION OF CONSTRUCTION AND UNTIL ACCEPTANCE OF THE PROJECT BY THE OWNER. ALL DRAINAGE STRUCTURES SHALL BE CLEANED OF DEBRIS AS REQUIRED DURING AND AT THE END OF CONSTRUCTION TO PROVIDE POSITIVE DRAINAGE FLOWS.
10. IF DEWATERING IS REQUIRED, THE CONTRACTOR SHALL OBTAIN ANY APPLICABLE REQUIRED PERMITS. THE CONTRACTOR IS TO COORDINATE WITH THE OWNER AND THE DESIGN ENGINEER PRIOR TO ANY EXCAVATION. EFFLUENT FROM DEWATERING OPERATIONS SHALL BE FILTERED OR PASSED THROUGH AN APPROVED SEDIMENT TRAPPING DEVICE, SEDIMENTATION TANK OR STRAW BALE/SILT FENCE PIT, OR BOTH, AND DISCHARGED IN A MANNER THAT DOES NOT ADVERSELY AFFECT ADJACENT PROPERTIES, WETLANDS, WATERWAYS OR THE STORM DRAINAGE SYSTEM. CONTRACTOR IS RESPONSIBLE FOR SIZING TANK OR PITS BASED ON PROPOSED FLOWS FROM DEWATERING OPERATIONS.
11. STRIP TOPSOIL AND ORGANIC MATTER FROM ALL AREAS OF THE SITE AS REQUIRED. IN SOME CASES TOPSOIL MAY BE STOCKPILED ON SITE FOR PLACEMENT WITHIN LANDSCAPED AREAS BUT ONLY AS DIRECTED BY THE OWNER.
12. FIELD DENSITY TESTS SHALL BE TAKEN AT INTERVALS IN ACCORDANCE WITH THE LOCAL JURISDICTIONAL AGENCY OR TO MASS HIGHWAY STANDARDS. IN THE EVENT THAT THE CONTRACT DOCUMENTS AND THE JURISDICTIONAL AGENCY REQUIREMENTS ARE NOT IN AGREEMENT, THE MOST STRINGENT SHALL GOVERN.
13. ALL SLOPES AND AREAS DISTURBED BY CONSTRUCTION SHALL BE GRADED AS PER PLANS. THE AREAS SHALL THEN BE SODDED OR SEEDED AS SPECIFIED IN THE PLANS, FERTILIZED, MULCHED, WATERED AND MAINTAINED UNTIL HARDY GRASS GROWTH IS ESTABLISHED IN ALL AREAS. ANY AREAS DISTURBED FOR ANY REASON PRIOR TO FINAL ACCEPTANCE OF THE JOB SHALL BE CORRECTED BY THE CONTRACTOR AT NO ADDITIONAL COST TO THE OWNER. ALL EARTHEN AREAS WILL BE SODDED OR SEEDED AND MULCHED AS SHOWN ON THE LANDSCAPING PLAN.
14. ALL CUT OR FILL SLOPES SHALL BE 4 (HORIZONTAL) : 1 (VERTICAL) OR FLATTER UNLESS OTHERWISE SHOWN.
15. THE CONTRACTOR SHALL BE RESPONSIBLE FOR THE CONTROL OF DUST AND DIRT RISING AND SCATTERING IN THE AIR DURING CONSTRUCTION AND SHALL PROVIDE WATER SPRINKLING OR OTHER SUITABLE METHODS OF CONTROL. THE CONTRACTOR SHALL COMPLY WITH ALL GOVERNING REGULATIONS PERTAINING TO ENVIRONMENTAL PROTECTION.
16. SOD, WHERE CALLED FOR, MUST BE INSTALLED AND MAINTAINED ON EXPOSED SLOPES WITHIN 48 HOURS OF COMPLETING FINAL GRADING, AND AT ANY OTHER TIME AS NECESSARY, TO PREVENT EROSION, SEDIMENTATION OR TURBID DISCHARGES.
17. THE CONTRACTOR SHALL ENSURE THAT ISLAND PLANTING AREAS AND OTHER PLANTING AREAS ARE NOT COMPACTED AND DO NOT CONTAIN ROAD BASE MATERIALS. THE CONTRACTOR SHALL ALSO EXCAVATE AND REMOVE ALL UNDESIRABLE MATERIAL FROM ALL AREAS ON THE SITE TO BE PLANTED AND PROPERLY DISPOSED OF IN A LEGAL MANNER.
18. THE CONTRACTOR SHALL ENSURE THAT ALL DRAINAGE PIPES ARE CLEANED FOLLOWING CONSTRUCTION.


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FILL: 6870 CY  
IMPORT: 6870 CY









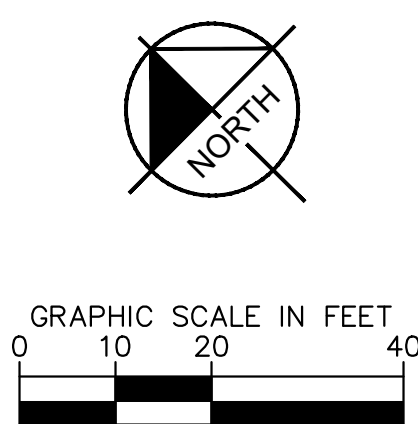




NOTES

1. EARTHWORK QUANTITIES ARE APPROXIMATE AND ARE SUBJECT TO CHANGE WITH FINAL DESIGN.
2. EARTHWORK QUANTITIES ARE PROVIDED FOR REFERENCE ONLY. CONTRACTOR SHALL COMPLETE THEIR OWN QUANTITY TAKE OFF WHEN DETERMINING THE BID PRICE FOR THE PROJECT.

	SPOT ELEVATION
	EXIST. CONTOUR
	PROP. CONTOUR
	PROP. STORM LINE
	PROP. LIMITS OF DISTURBANCE 1.47 AC
	DRAINAGE SWALE CENTERLINE
	GRADEBREAK
	MATCH EXISTING
	HIGH POINT
	LOW POINT
	FINISHED FLOOR ELEVATION
	TOP OF CURB
	ROOF LEADER

1. SPOT ELEVATION TO FLOW LINE UNLESS OTHERWISE NOTED.
2. TOP OF CURB IS 6" ABOVE FLOW LINE UNLESS OTHERWISE NOTED.




- # LEGEND
- 
- |   |                                     |
|---|-------------------------------------|
|  | SPOT ELEVATION                      |
|  | EXIST. CONTOUR                      |
|  | PROP. CONTOUR                       |
|  | PROP. STORM LINE                    |
|  | PROP. LIMITS OF DISTURBANCE 1.47 AC |
|  | DRAINAGE SWALE CENTERLINE           |
|  | GRADEBREAK                          |
|  | MATCH EXISTING                      |
|  | HIGH POINT                          |
|  | LOW POINT                           |
|  | FINISHED FLOOR ELEVATION            |
|  | TOP OF CURB                         |
|  | ROOF LEADER                         |

- ## NOTES
1. SPOT ELEVATION TO FLOW LINE UNLESS OTHERWISE NOTED.
  2. TOP OF CURB IS 6" ABOVE FLOW LINE UNLESS OTHERWISE NOTED.

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**Kimley»Horn**  
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271 WAVERLEY OAKS RD, SUITE 302, WALTHAM, MA 02452  
PHONE: 781-328-0676  
[WWW.KIMLEY-HORN.COM](http://WWW.KIMLEY-HORN.COM)

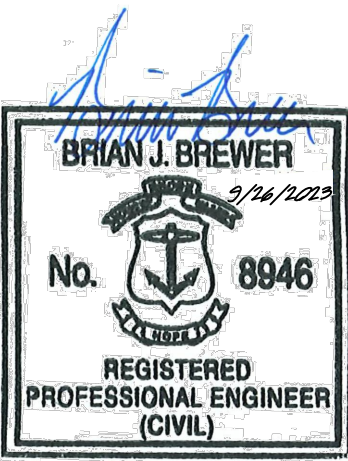

KHA PROJECT	DATE
112704000	7/1/2024
GCSCALE	AS SHOWN
DESIGNED BY	CGA
DRAWN BY	CGA
CHECKED BY	BB

# GRADING AND DRAINAGE PLAN

COVENTRY SELF STORAGE

PREPARED FOR

NOOSENECK HILL COVENTRY, LLC




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COVENTRY, RI 02816


COVENTRY AP 10 LOT 31 RHODE ISLAND

SHEET NUMBER  
C-5.1


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This document, together with the concepts and designs presented herein, as an instrument of service, is intended only for the specific purpose and client for which it was prepared. Reuse of and improper reliance on the document without written authorization and adaptation by Kimley-Horn and Associates, Inc. shall be without liability to Kimley-Horn and Associates, Inc.

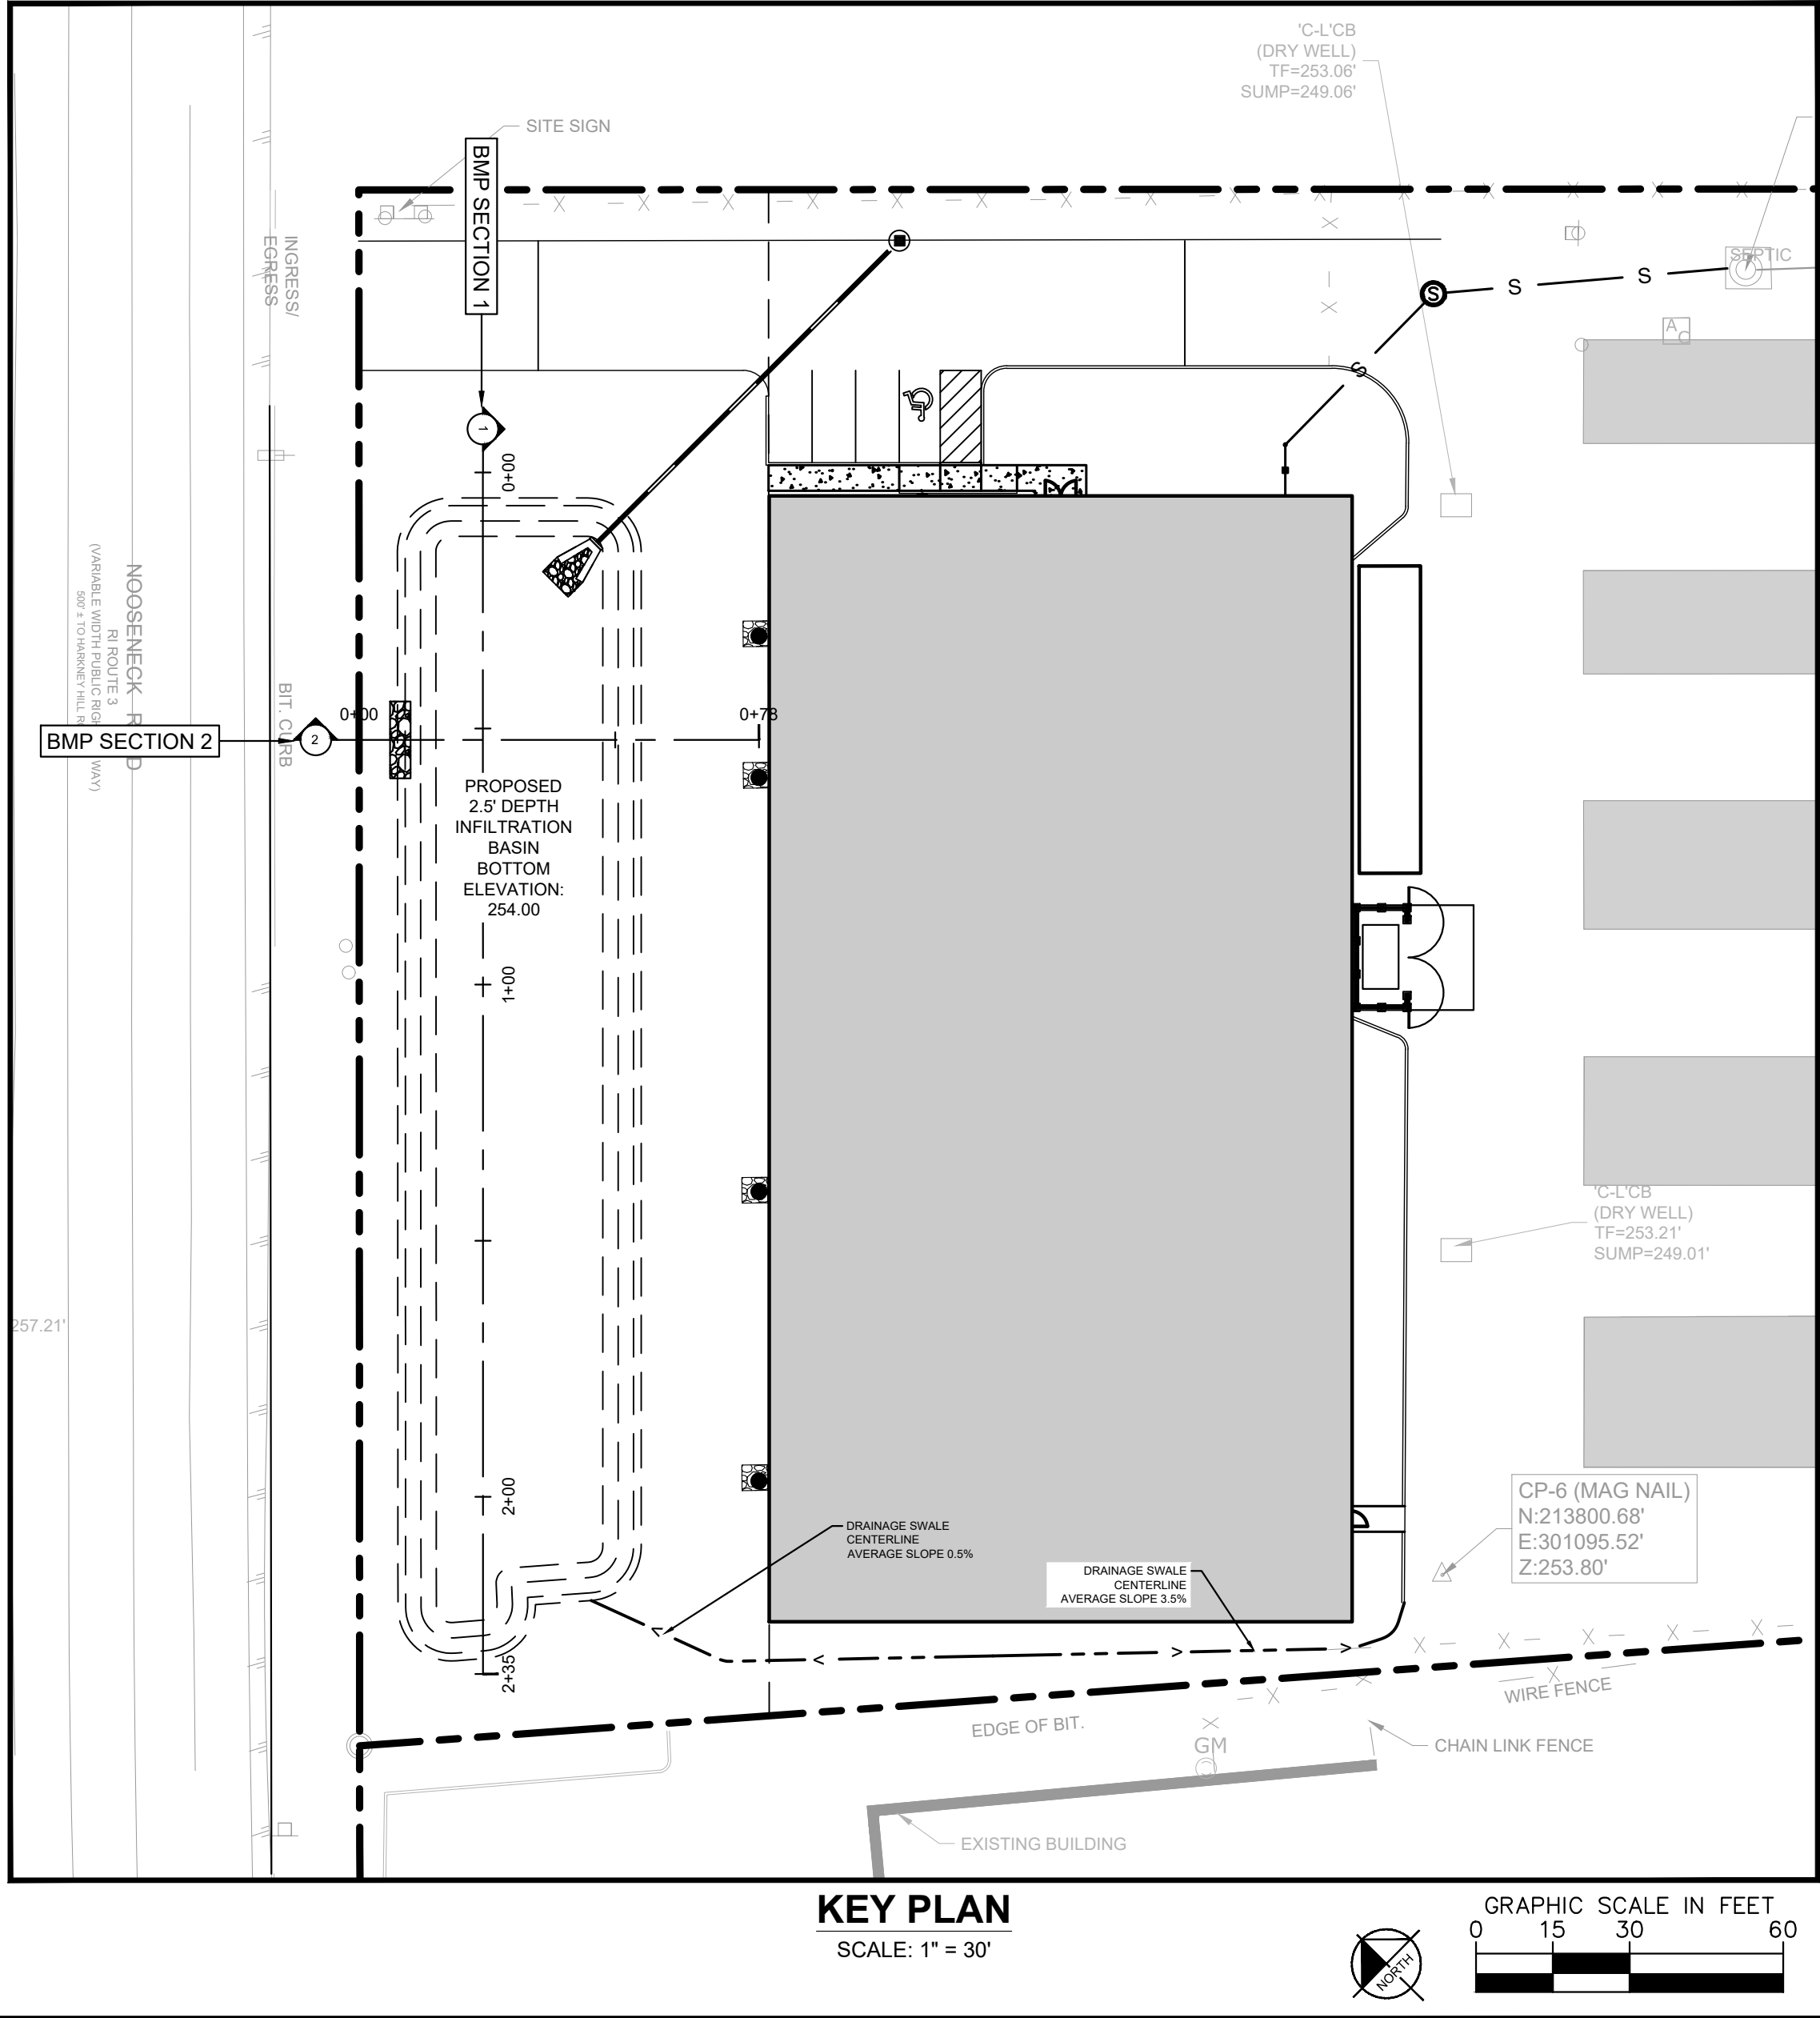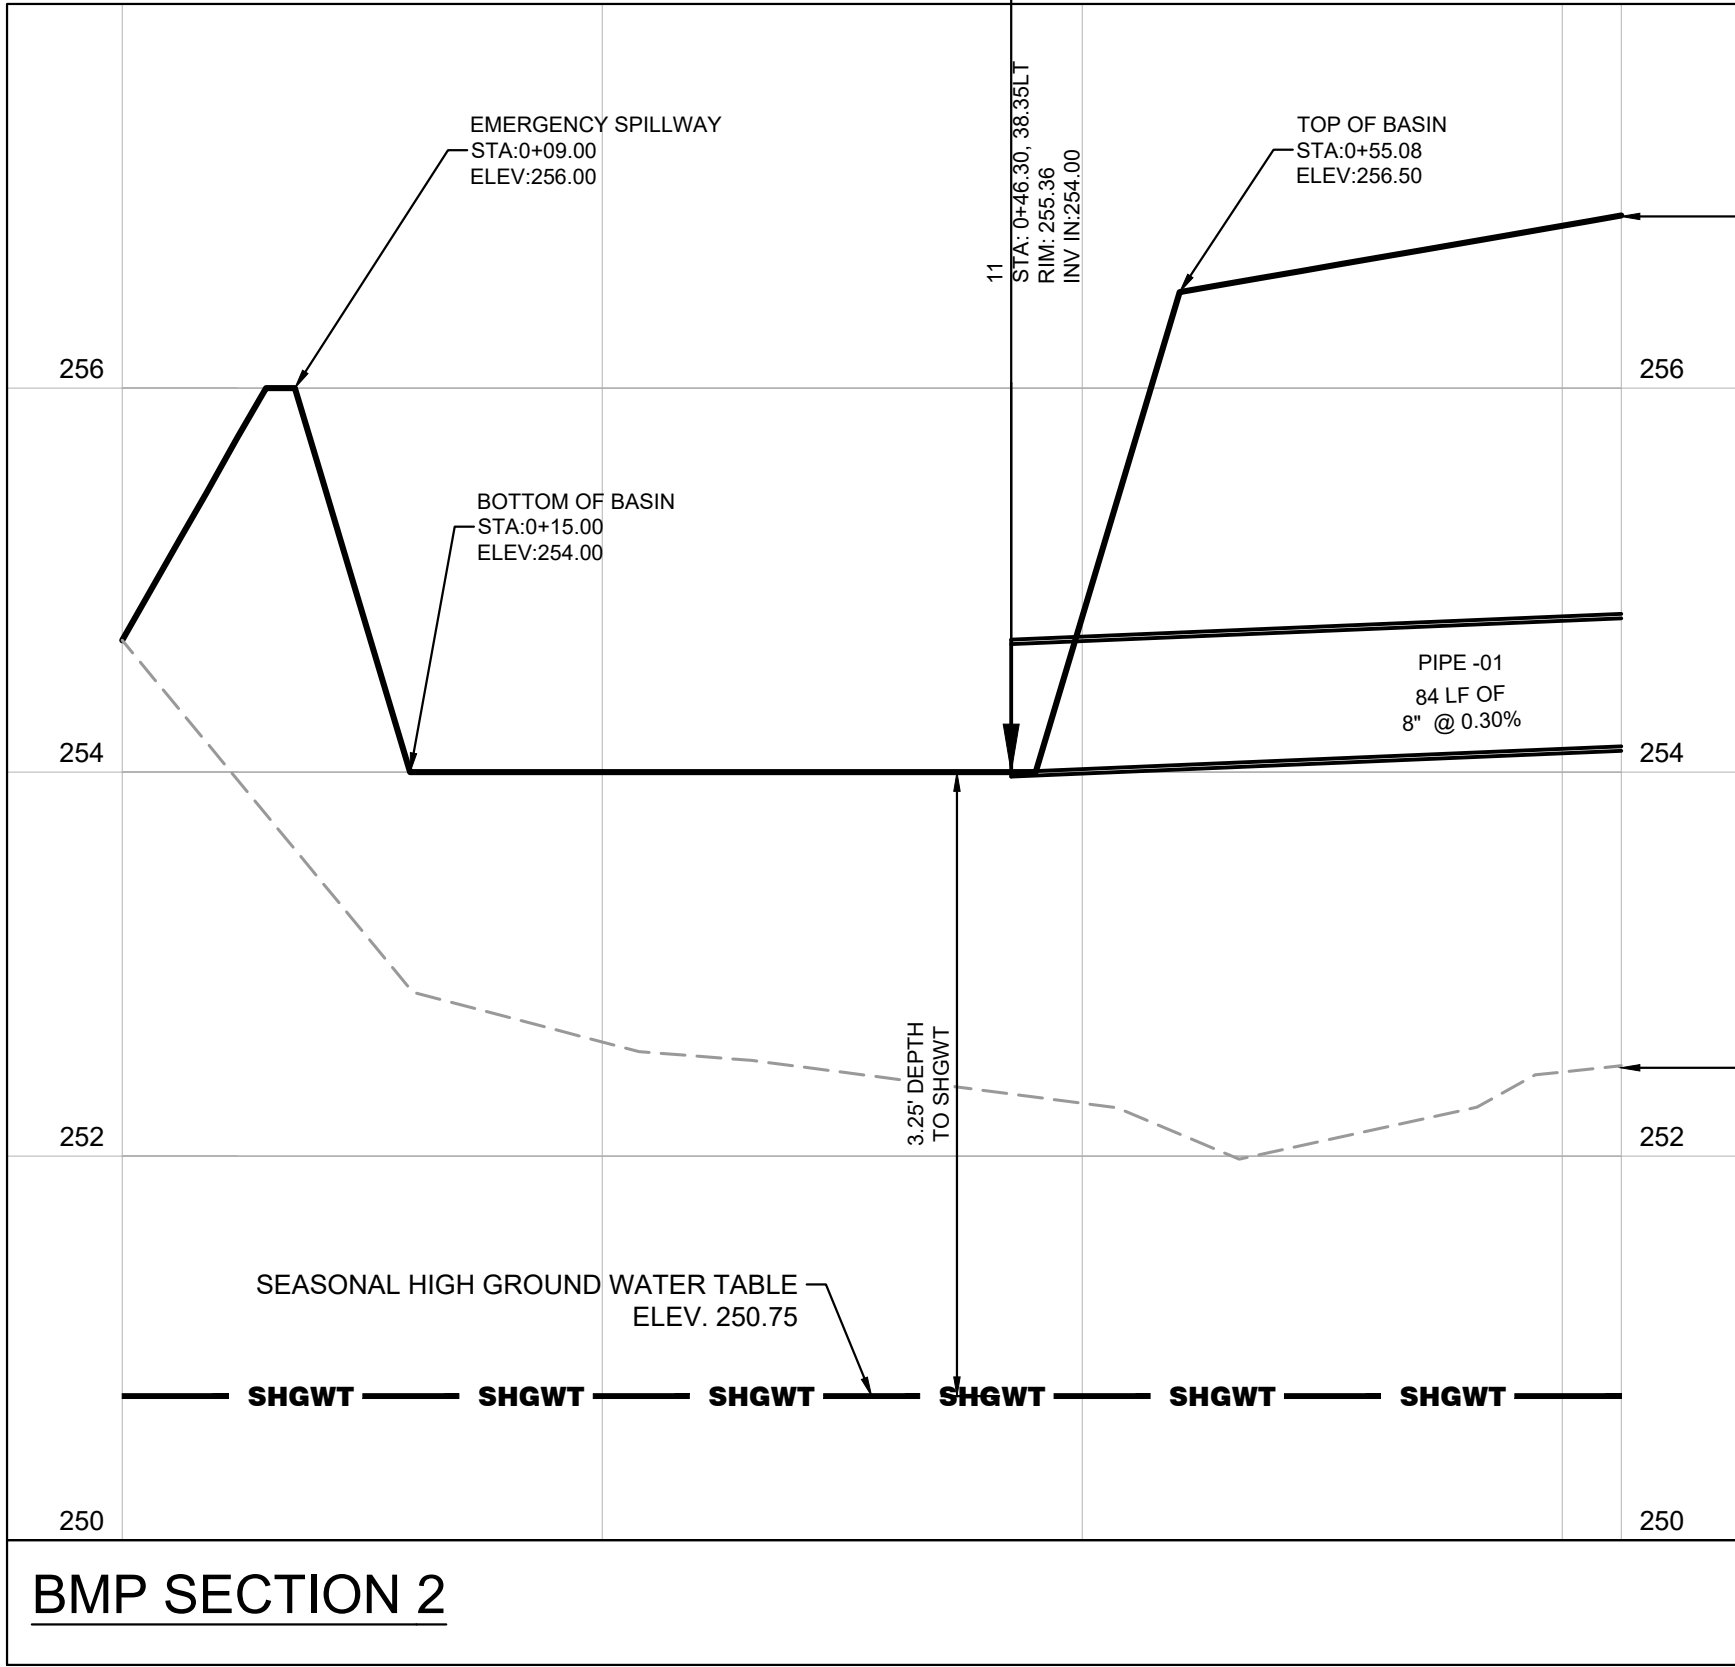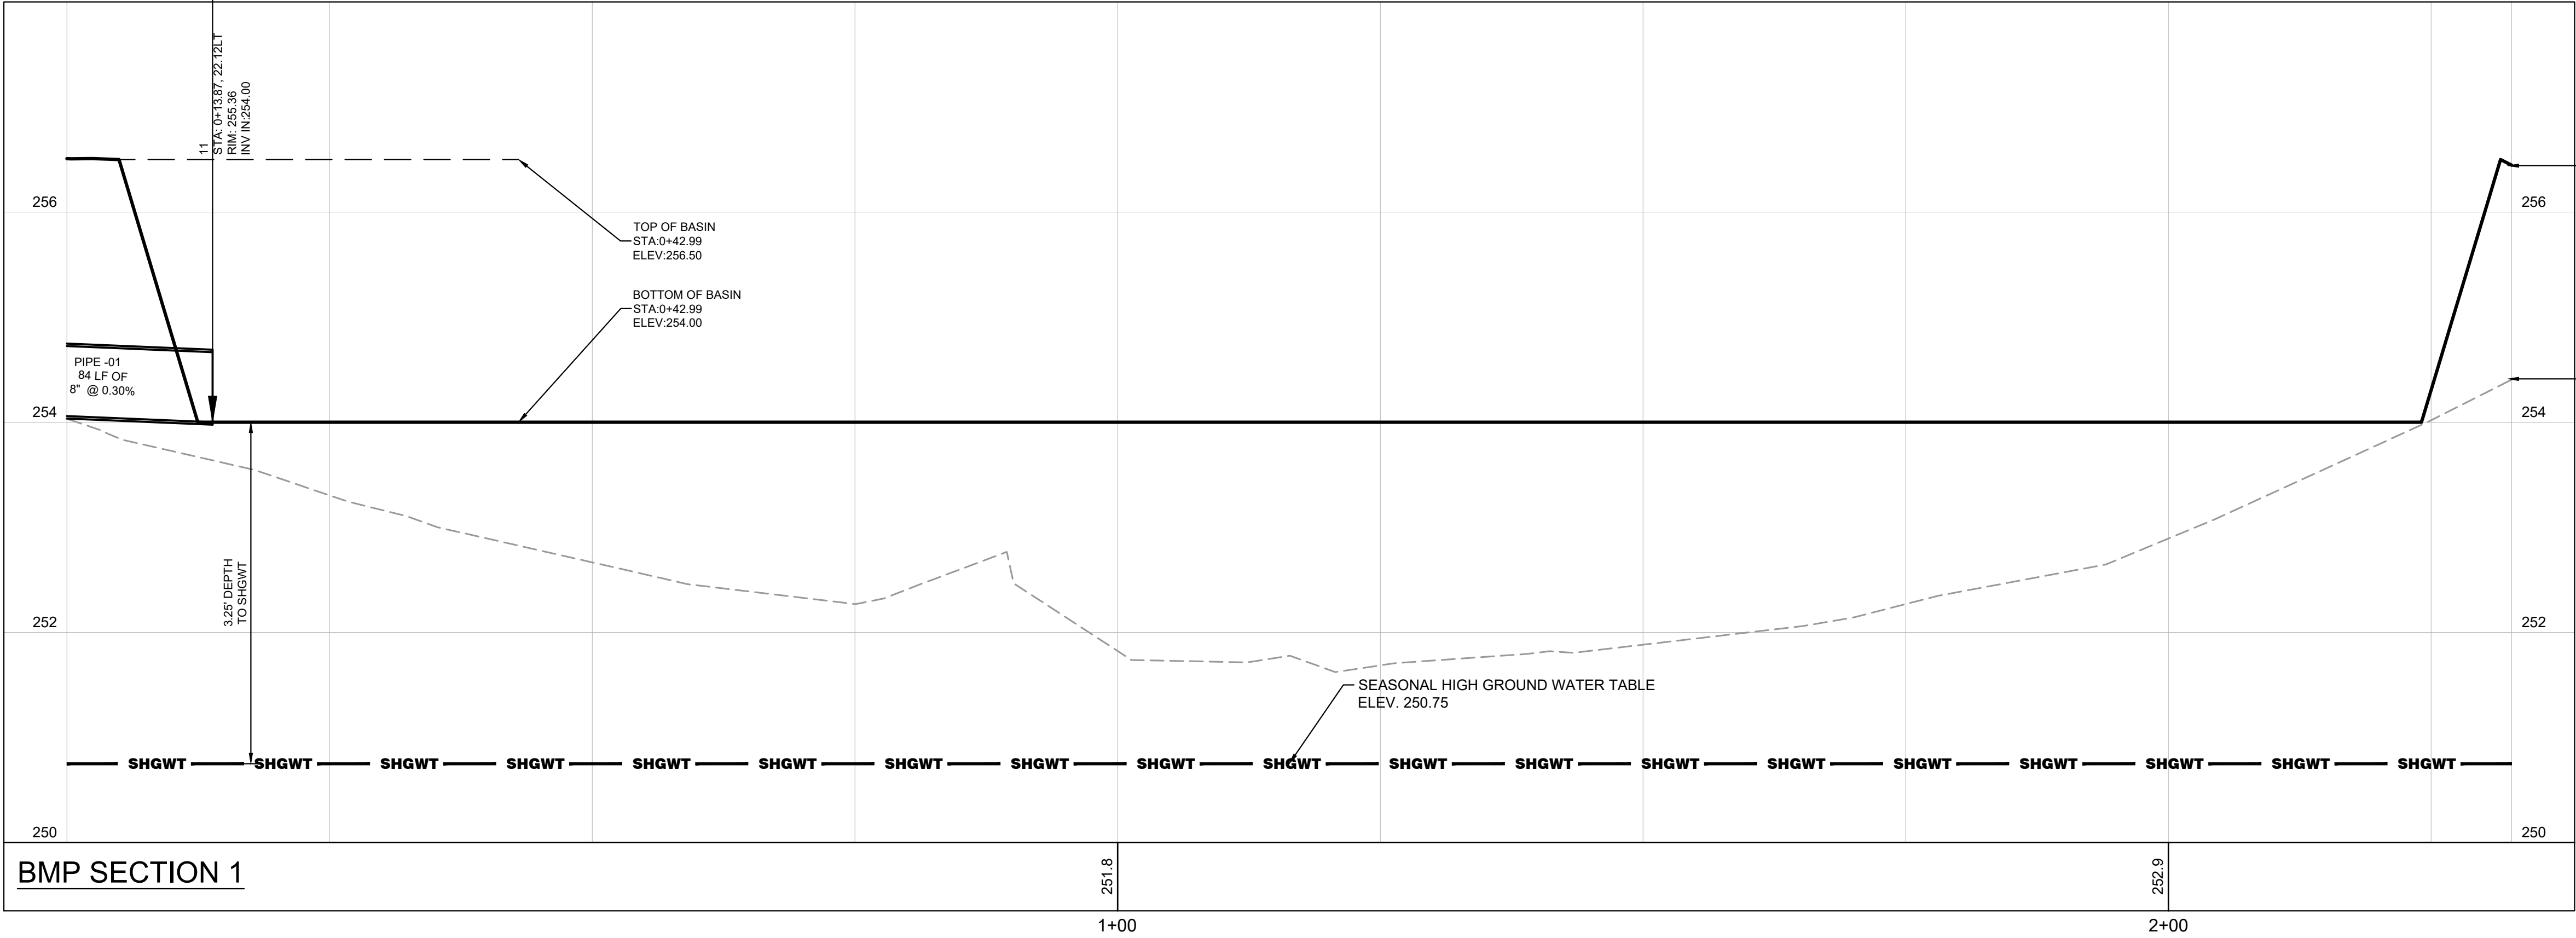

KHA PROJECT 112704000	DATE 7/1/2024	SCALE AS SHOWN	DESIGNED BY CGA	DRAWN BY CGA	CHECKED BY BB		COVENTRY SELF STORAGE PREPARED FOR NOOSENECK HILL COVENTRY, LLC 1920 NOOSENECK HILL RD COVENTRY, RI 02816 COVENTRY AP 10 LOT 31 RHODE ISLAND	SHEET NUMBER <b>C-5.2</b>	KIMLEY»Horn © 2024 KIMLEY-HORN AND ASSOCIATES, INC. 271 WAVERLEY OAKS RD, SUITE 302, WALTHAM, MA 02452 PHONE: 781-328-0676 WWW.KIMLEY-HORN.COM	PRELIMINARY PLAN APPROVAL	06/27/2025	MJD
										REVISED PER RIDE COMMENTS	09/09/2024	FJM
										REVISIONS		
										No.	DATE	BY

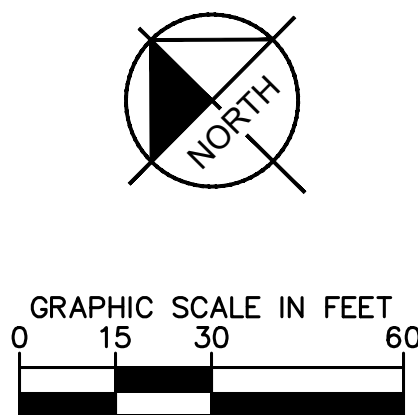[illegible]

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PHONE: 781-325-0676  
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KHA PROJECT 112704000	DATE 7/1/2024	SCALE AS SHOWN	DESIGNED BY CGA	DRAWN BY CGA	CHECKED BY BB
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# EROSION AND SEDIMENT CONTROL PLAN

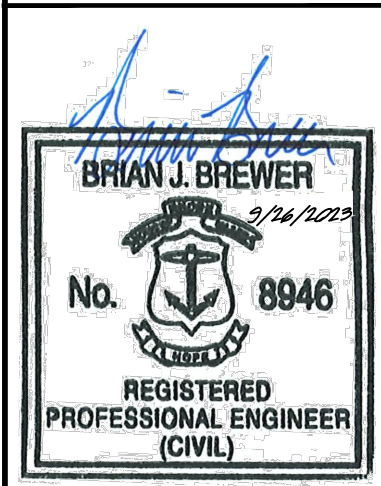**COVENTRY SELF STORAGE**  
PREPARED FOR  
NOOSENECK HILL COVENTRY, LLC  
1920 NOOSENECK HILL RD  
COVENTRY, RI 02816  
COVENTRY AP 10 LOT 31 RHODE ISLAND








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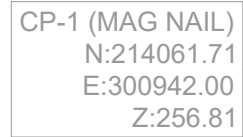
- CONSTRUCTION ENTRANCE SHALL BE LOCATED SO AS TO PROVIDE THE LEAST AMOUNT OF DISTURBANCE TO THE FLOW OF TRAFFIC IN AND OUT OF THE SITE. ADDITIONALLY, CONSTRUCTION ENTRANCE SHALL BE LOCATED TO COINCIDE WITH THE PHASING OF THE PAVEMENT REPLACEMENT.
- POST CONSTRUCTION STORM WATER POLLUTION CONTROL MEASURES INCLUDE STABILIZATION BY PERMANENT PAVING, DRAINAGE SYSTEM STRUCTURE, OR LANDSCAPING.
- TEMPORARY AND PERMANENT STABILIZATION PRACTICES AND BMP'S SHALL BE INSTALLED AT THE EARLIEST POSSIBLE TIME DURING THE CONSTRUCTION SEQUENCE. AS AN EXAMPLE, PERIMETER SILT FENCE SHALL BE INSTALLED BEFORE COMMENCEMENT OF ANY GRADING ACTIVITIES. OTHER BMP'S SHALL BE INSTALLED AS SOON AS PRACTICABLE AND SHALL BE MAINTAINED UNTIL FINAL SITE STABILIZATION IS ATTAINED. CONTRACTOR SHALL ALSO REFERENCE CIVIL AND LANDSCAPE PLANS SINCE PERMANENT STABILIZATION IS PROVIDED BY LANDSCAPING, THE BUILDING(S), AND SITE PAVING.
- BMP'S HAVE BEEN LOCATED AS INDICATED ON THIS PLAN IN ACCORDANCE WITH GENERALLY ACCEPTED ENGINEERING PRACTICES IN ORDER TO MINIMIZE SEDIMENT TRANSFER. FOR EXAMPLE: SILT FENCES LOCATED AT TOE OF SLOPE AND INLET PROTECTION FOR INLETS RECEIVING SEDIMENT FROM SITE RUN-OFF.
- THE PLACEMENT OF EROSION/SEDIMENTATION CONTROLS SHALL BE IN ACCORDANCE WITH THE APPROVED EROSION AND SEDIMENTATION CONTROL PLAN.
- ANY MAJOR VARIATION IN MATERIALS OR LOCATIONS OF CONTROLS OR FENCES FROM THOSE SHOWN ON THE APPROVED PLANS WILL REQUIRE A REVISION AND MUST BE APPROVED BY THE REVIEWING ENGINEER, ENVIRONMENTAL SPECIALIST, OR ARBORIST AS APPROPRIATE. MAJOR REVISIONS MUST BE APPROVED BY THE PLANNING AND DEVELOPMENT DEPARTMENT AND THE DRAINAGE UTILITY DEPARTMENT. MINOR CHANGES OR ADDITIONAL CONTROL MEASURES TO BE MADE AS FIELD REVISIONS TO THE EROSION AND SEDIMENTATION CONTROL PLAN MAY BE REQUIRED BY THE ENVIRONMENTAL INSPECTOR DURING THE COURSE OF CONSTRUCTION TO CORRECT CONTROL INADEQUACIES AT NO ADDITIONAL COST TO THE OWNER.
- CONTRACTOR SHALL PLACE EROSION CONTROL BLANKET (NORTH AMERICAN GREEN S150BN OR APPROVED EQUAL) ON ALL SITE AREAS WITH SLOPES GREATER THAN 4:1, AND IN THE BOTTOM AND SIDE SLOPES OF ALL SWALES.
- PRIOR TO FINAL ACCEPTANCE, HAUL ROADS AND WATERWAY CROSSINGS CONSTRUCTED FOR TEMPORARY CONTRACTOR ACCESS MUST BE REMOVED, ACCUMULATED SEDIMENT REMOVED FROM THE WATERWAY AND THE AREA RESTORED TO THE ORIGINAL GRADE AND REVEGETATED. ALL LAND CLEARING SHALL BE DISPOSED OF IN APPROVED SPOIL DISPOSAL SITES.
- PERMANENT, FINAL PLANT COVERING OR STRUCTURES SHALL BE INSTALLED PRIOR TO FINAL ACCEPTANCE.
- ALL CONTROL DEVICES THAT FUNCTION SIMILARLY TO SILT FENCE OR FIBER ROLLS MUST BE REPAIRED, REPLACED OR SUPPLEMENTED WITH EFFECTIVE CONTROLS WHEN THEY BECOME NONFUNCTIONAL OR THE SEDIMENT REACHES ONE-THIRD THE HEIGHT OF THE DEVICE. THESE REPAIRS MUST BE MADE WITHIN 24 HOURS OF THE RAINFALL EVENT OR AS SOON AS FIELD CONDITIONS ALLOW ACCESS.
- ALL SEDIMENT DELTAS AND DEPOSITS MUST BE REMOVED FROM SURFACE WATERS, DRAINAGE WAYS, CATCH BASINS AND OTHER DRAINAGE SYSTEMS. ALL AREAS WHERE SEDIMENT REMOVAL RESULTED IN EXPOSED SOIL MUST BE RESTABILIZED. THE REMOVAL AND STABILIZATION MUST TAKE PLACE IMMEDIATELY, BUT NO MORE THAN 7 DAYS AFTER THE RAINFALL EVENT UNLESS PRECLUDED BY LEGAL, REGULATORY OR PHYSICAL ACCESS CONSTRAINTS. ALL REASONABLE EFFORTS MUST BE USED TO OBTAIN ACCESS. ONCE ACCESS IS OBTAINED, REMOVAL AND STABILIZATION MUST TAKE PLACE IMMEDIATELY, BUT NO MORE THAN 7 DAYS LATER. CONTRACTOR IS RESPONSIBLE FOR CONTACTING ALL APPROPRIATE AUTHORITIES AND RECEIVING THE APPLICABLE PERMITS PRIOR TO CONDUCTING ANY WORK.
- ACCUMULATIONS OF TRACKED AND DEPOSITED SEDIMENT MUST BE REMOVED FROM OFF-SITE PAVED SURFACES WITHIN 24 HOURS OR SOONER IF REQUIRED. SEDIMENT TRACKING MUST BE MINIMIZED BY THE APPROPRIATE MANAGEMENT PRACTICE, LIKE A DEDICATED SITE EXIT WITH AN AGGREGATE SURFACE OR DESIGNATED OFFSITE PARKING AREA. CONTRACTOR IS RESPONSIBLE FOR STREET SWEEPING AND/OR SCRAPING IF YOUR PRACTICES ARE NOT ADEQUATE TO PREVENT SEDIMENT FROM BEING TRACKED FROM THE SITE.
- SURFACE WATERS, DRAINAGE DITCHES AND CONVEYANCE SYSTEMS MUST BE INSPECTED FOR SEDIMENT DEPOSITS.
- THE CONTRACTOR SHALL INSTALL AND MAINTAIN ALL EROSION CONTROL MEASURES AS INDICATED ON THIS SHEET IN ACCORDANCE WITH THE STORMWATER POLLUTION PREVENTION PLAN (SWPPP) PREPARED BY KIMLEY-HORN AND ASSOCIATES, INC. THE CONTRACTOR IS RESPONSIBLE FOR IMPLEMENTING THE PROVISIONS INDICATED IN THE SWPPP, INCLUDING EROSION CONTROL MEASURES AND INSPECTION FREQUENCY, AS REQUIRED BY THE NYC DEC SWPPP REQUIREMENTS.
- PUMPING SEDIMENT LADEN WATER INTO ANY STORMWATER FACILITY THAT IS NOT DESIGNATED TO BE A SEDIMENT TRAP, DRAINAGEWAY, OR OFFSITE AREA EITHER DIRECTLY OR INDIRECTLY WITHOUT FILTRATION IS PROHIBITED.
- SOIL STOCKPILES SHALL NOT BE LOCATED IN A DRAINAGEWAY, FLOOD PLAIN AREA OR A DESIGNATED BUFFER, UNLESS OTHERWISE APPROVED, UNDER SPECIFIC CONDITIONS TO BE ESTABLISHED BY THE DIRECTOR OR ADMINISTRATOR.
- STOCKPILES TO REMAIN IN PLACE FOR MORE THAN THREE DAYS SHALL BE PROVIDED WITH SESC MEASURES. MATERIAL IS TO BE HAULED OFF IMMEDIATELY AND LEGALLY IF NO STOCKPILE IS TO REMAIN IN PLACE.
- ALL TEMPORARY SESC MEASURES SHALL BE REMOVED WITHIN 30 DAYS AFTER FINAL STABILIZATION IS ACHIEVED. TRAPPED SEDIMENT AND OTHER DISTURBED SOILS RESULTING FROM TEMPORARY MEASURES SHALL BE PROPERLY DISPOSED OF PRIOR TO PERMANENT STABILIZATION.
- WATER REMOVED FROM TRAPS, BASINS, AND OTHER WATER HOLDING DEPRESSIONS OR EXCAVATIONS MUST FIRST PASS THROUGH A SEDIMENT CONTROL AND/OR FILTRATION DEVICE. WHEN DEWATERING DEVICES ARE USED, DISCHARGE LOCATIONS SHALL BE PROTECTED FROM EROSION.
- SITE STABILIZATION REQUIREMENTS ARE AS FOLLOWS:
  - WHERE THE INITIATION OF STABILIZATION MEASURE BY THE 7TH DAY AFTER CONSTRUCTION ACTIVITY TEMPORARILY OR PERMANENTLY CEASES ON A PORTION OF THE SITE IS PRECLUDED BY SNOW COVER, STABILIZATION MEASURE SHALL BE INITIATED AS SOON AS PRACTICABLE.
  - WHERE CONSTRUCTION ACTIVITY WILL RESUME ON A PORTION OF THE SITE WITHIN 14 DAYS FROM WHEN ACTIVITIES CEASED, (E.G. THE TOTAL TIME PERIOD THAT CONSTRUCTION ACTIVITY IS TEMPORARILY CEASED IS LESS THAN 14 DAYS) THEN STABILIZATION MEASURES DO NOT HAVE TO BE INITIATED ON THAT PORTION OF THE SITE BY THE 7TH DAY AFTER CONSTRUCTION ACTIVITY TEMPORARILY CEASED.

1. INSTALL SILT FENCING AS SHOWN IN THESE PLANS OR WHERE ADDITIONALLY REQUIRED.
2. INSTALL STABILIZED CONSTRUCTION ENTRANCE.
3. INSTALL TEMPORARY INLET PROTECTION ON ALL INLETS WITHIN PREMISE LINE.
4. COMMENCE SITE REMOVALS, CLEARING & GRUBBING AND CONSTRUCTION OF SUBJECT SITE.

NOTE: THE SEQUENCE OF CONSTRUCTION SHOWN ABOVE IS A GENERAL OVERVIEW AND IS INTENDED TO CONVEY THE GENERAL CONCEPTS OF THE EROSION CONTROL DESIGN AND SHOULD NOT BE RELIED UPON FOR CONSTRUCTION PURPOSES. THE CONTRACTOR IS SOLELY RESPONSIBLE FOR DETAILED PHASING AND CONSTRUCTION SEQUENCING NECESSARY TO CONSTRUCT THE PROPOSED IMPROVEMENTS INCLUDED IN THESE PLANS. THE CONTRACTOR SHALL BE RESPONSIBLE FOR OBTAINING ALL NECESSARY PERMITS AND/OR CONSTRUCTION AUTHORITY. ANY ADDITIONAL INFORMATION ON THE CONSTRUCTION SEQUENCE IS NECESSARY, THE CONTRACTOR IS SOLELY RESPONSIBLE FOR COMPLYING WITH THE REQUIREMENTS OF THE AUTHORITY HAVING JURISDICTION AND ALL OTHER APPLICABLE LAWS.


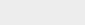
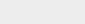




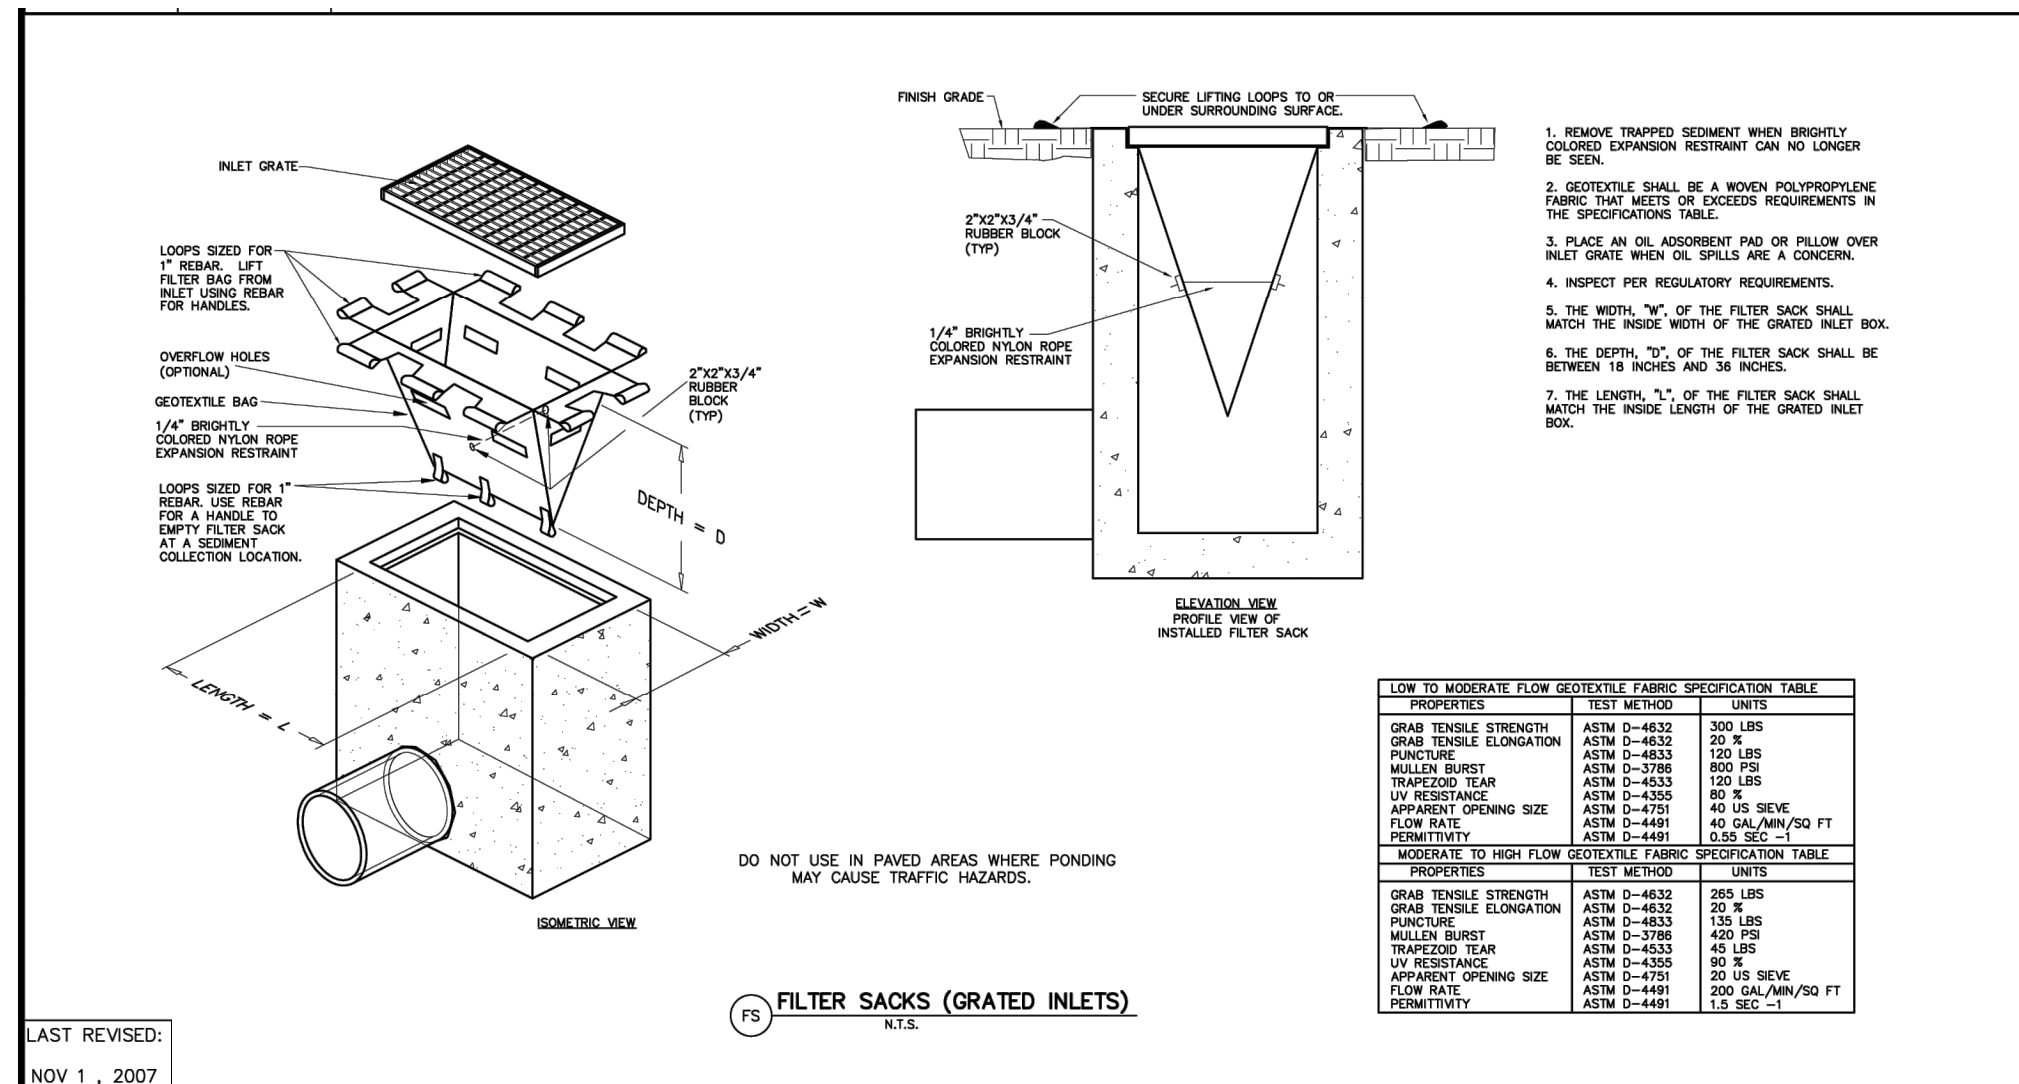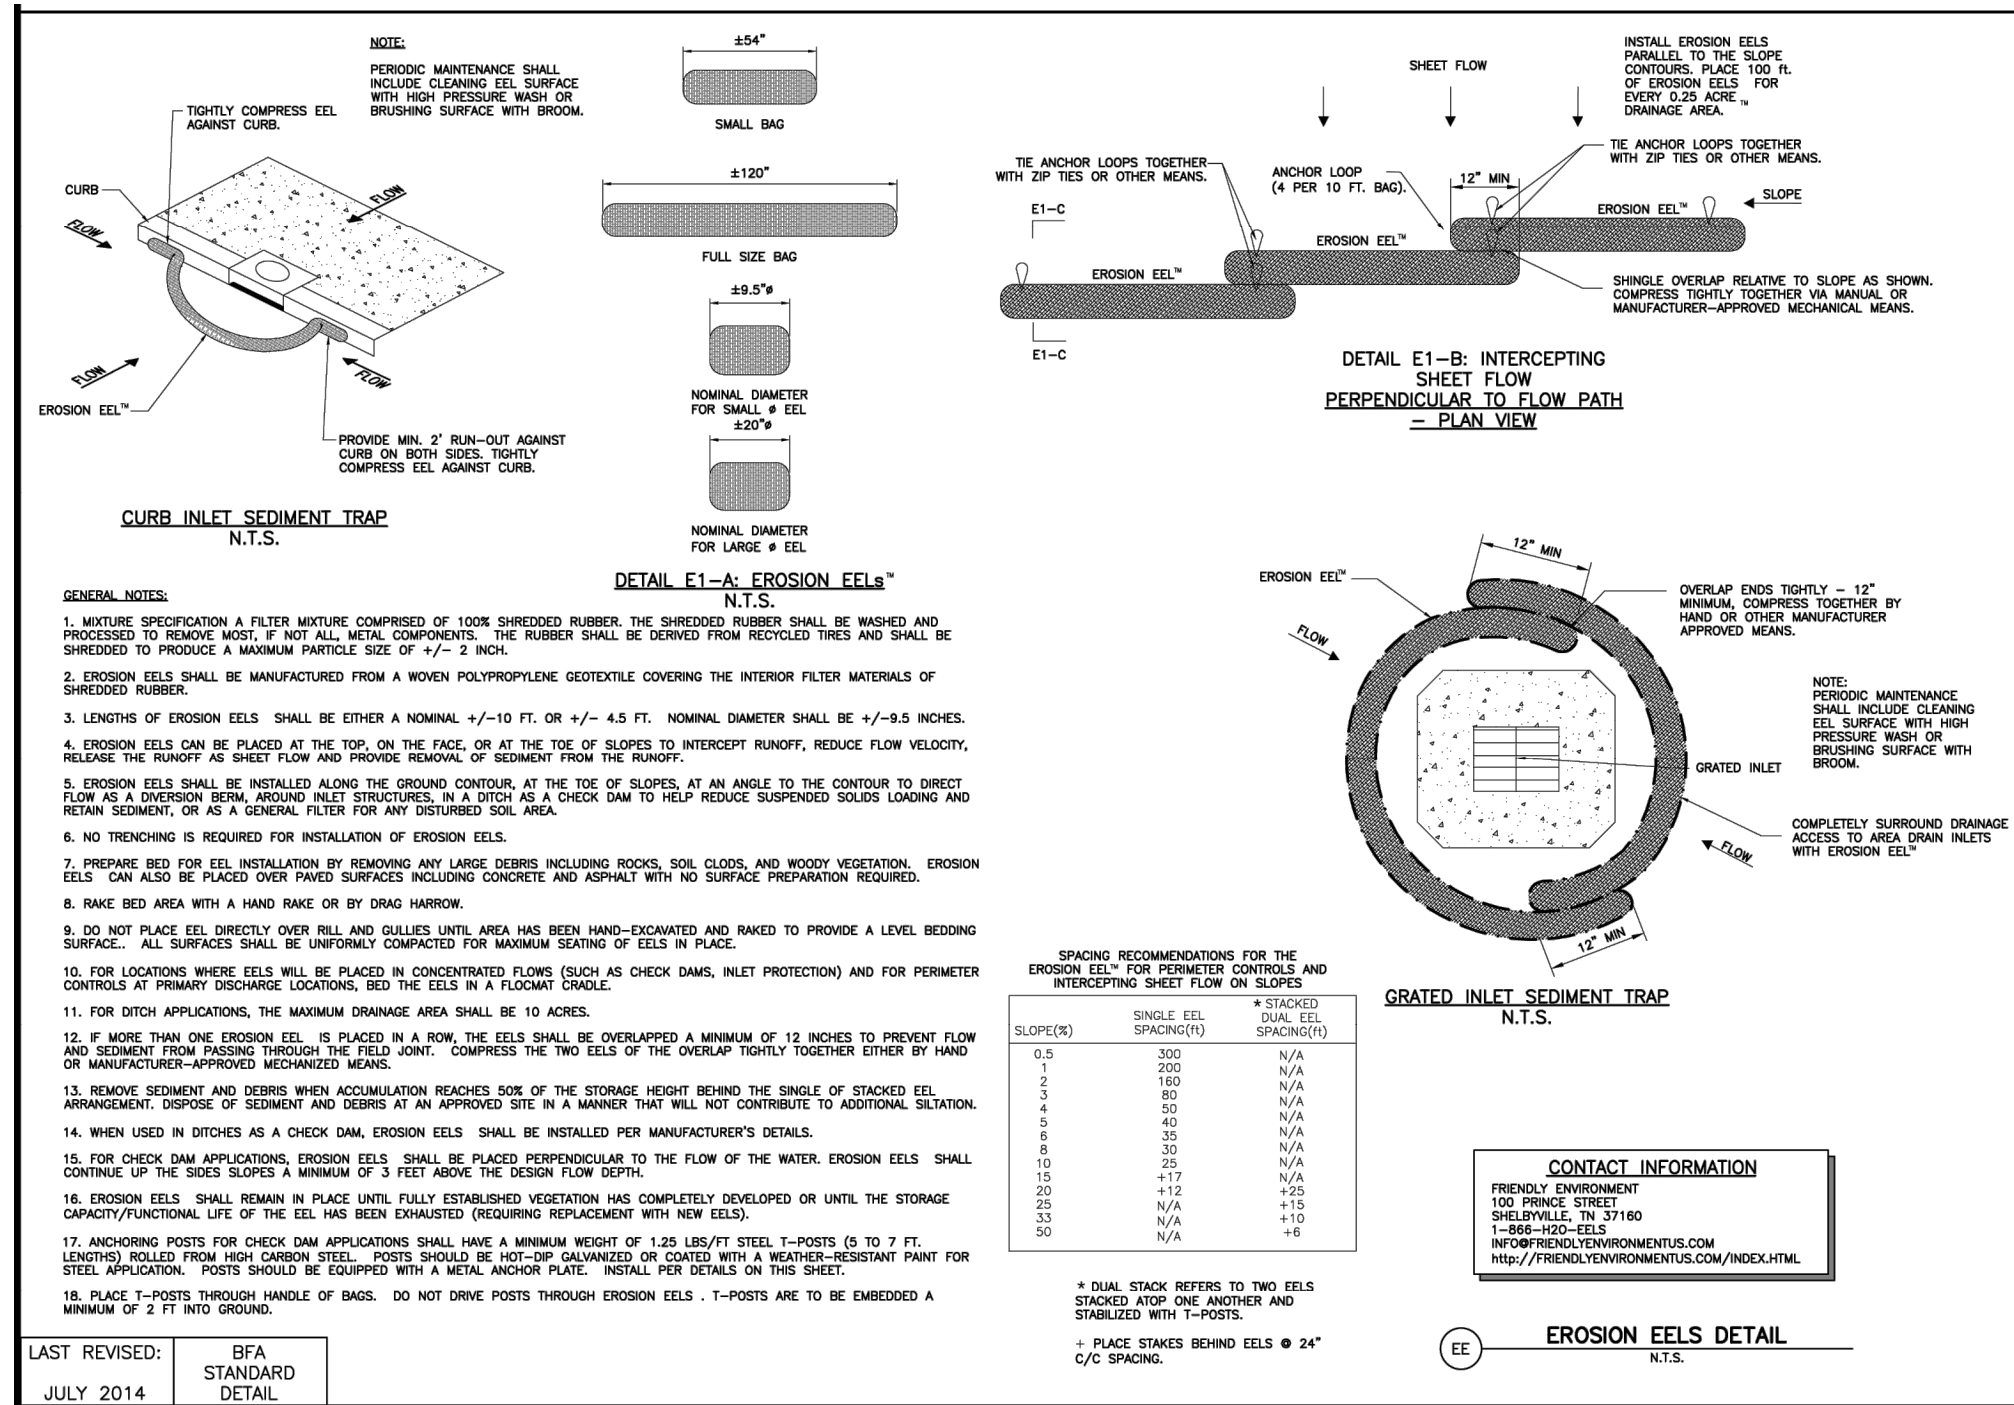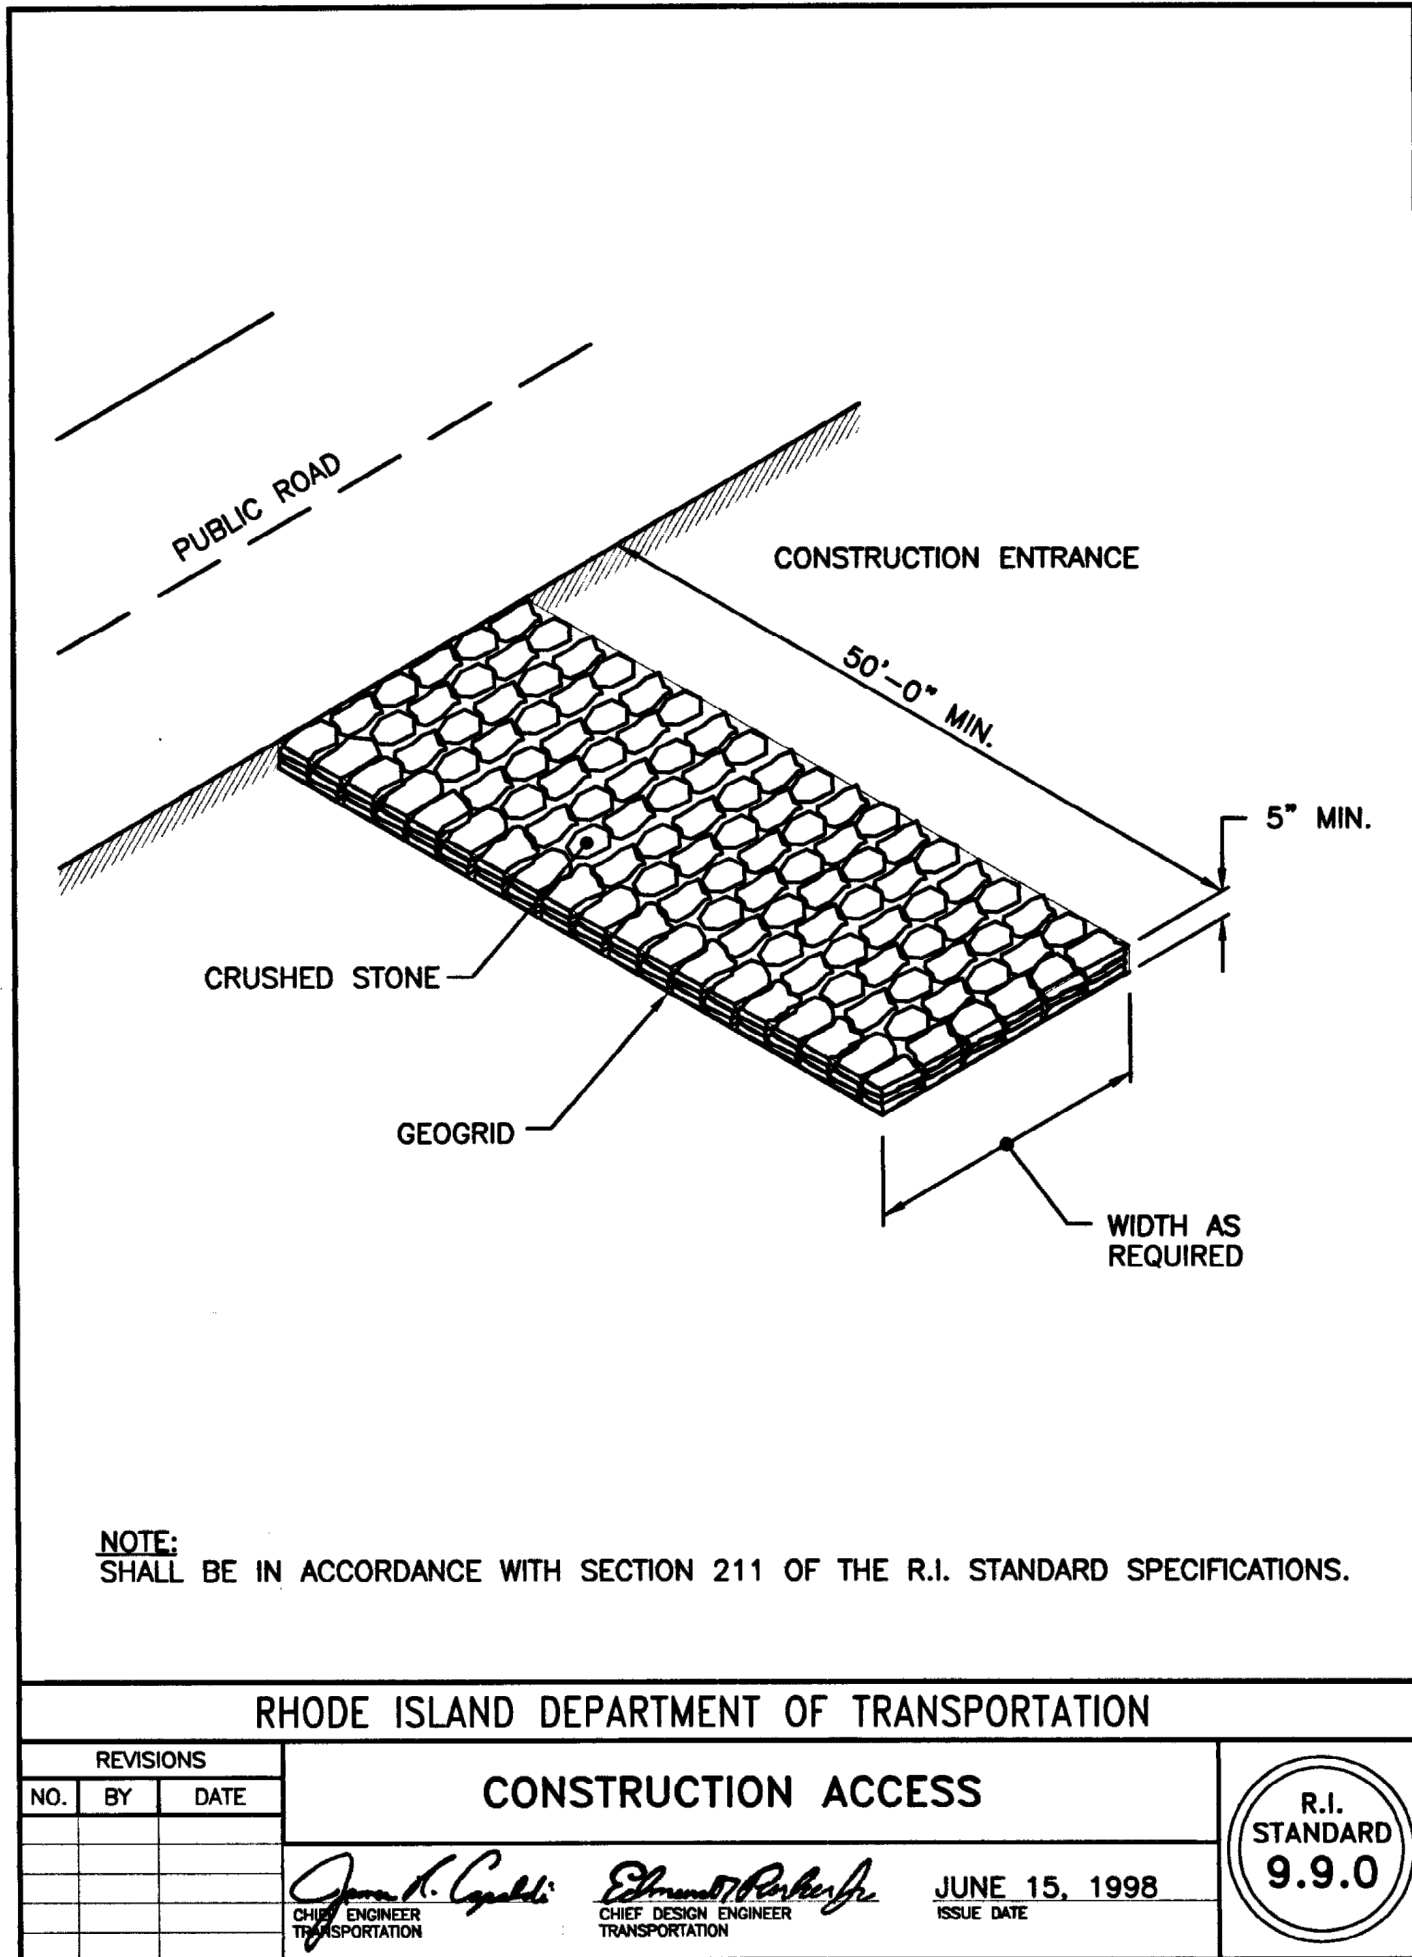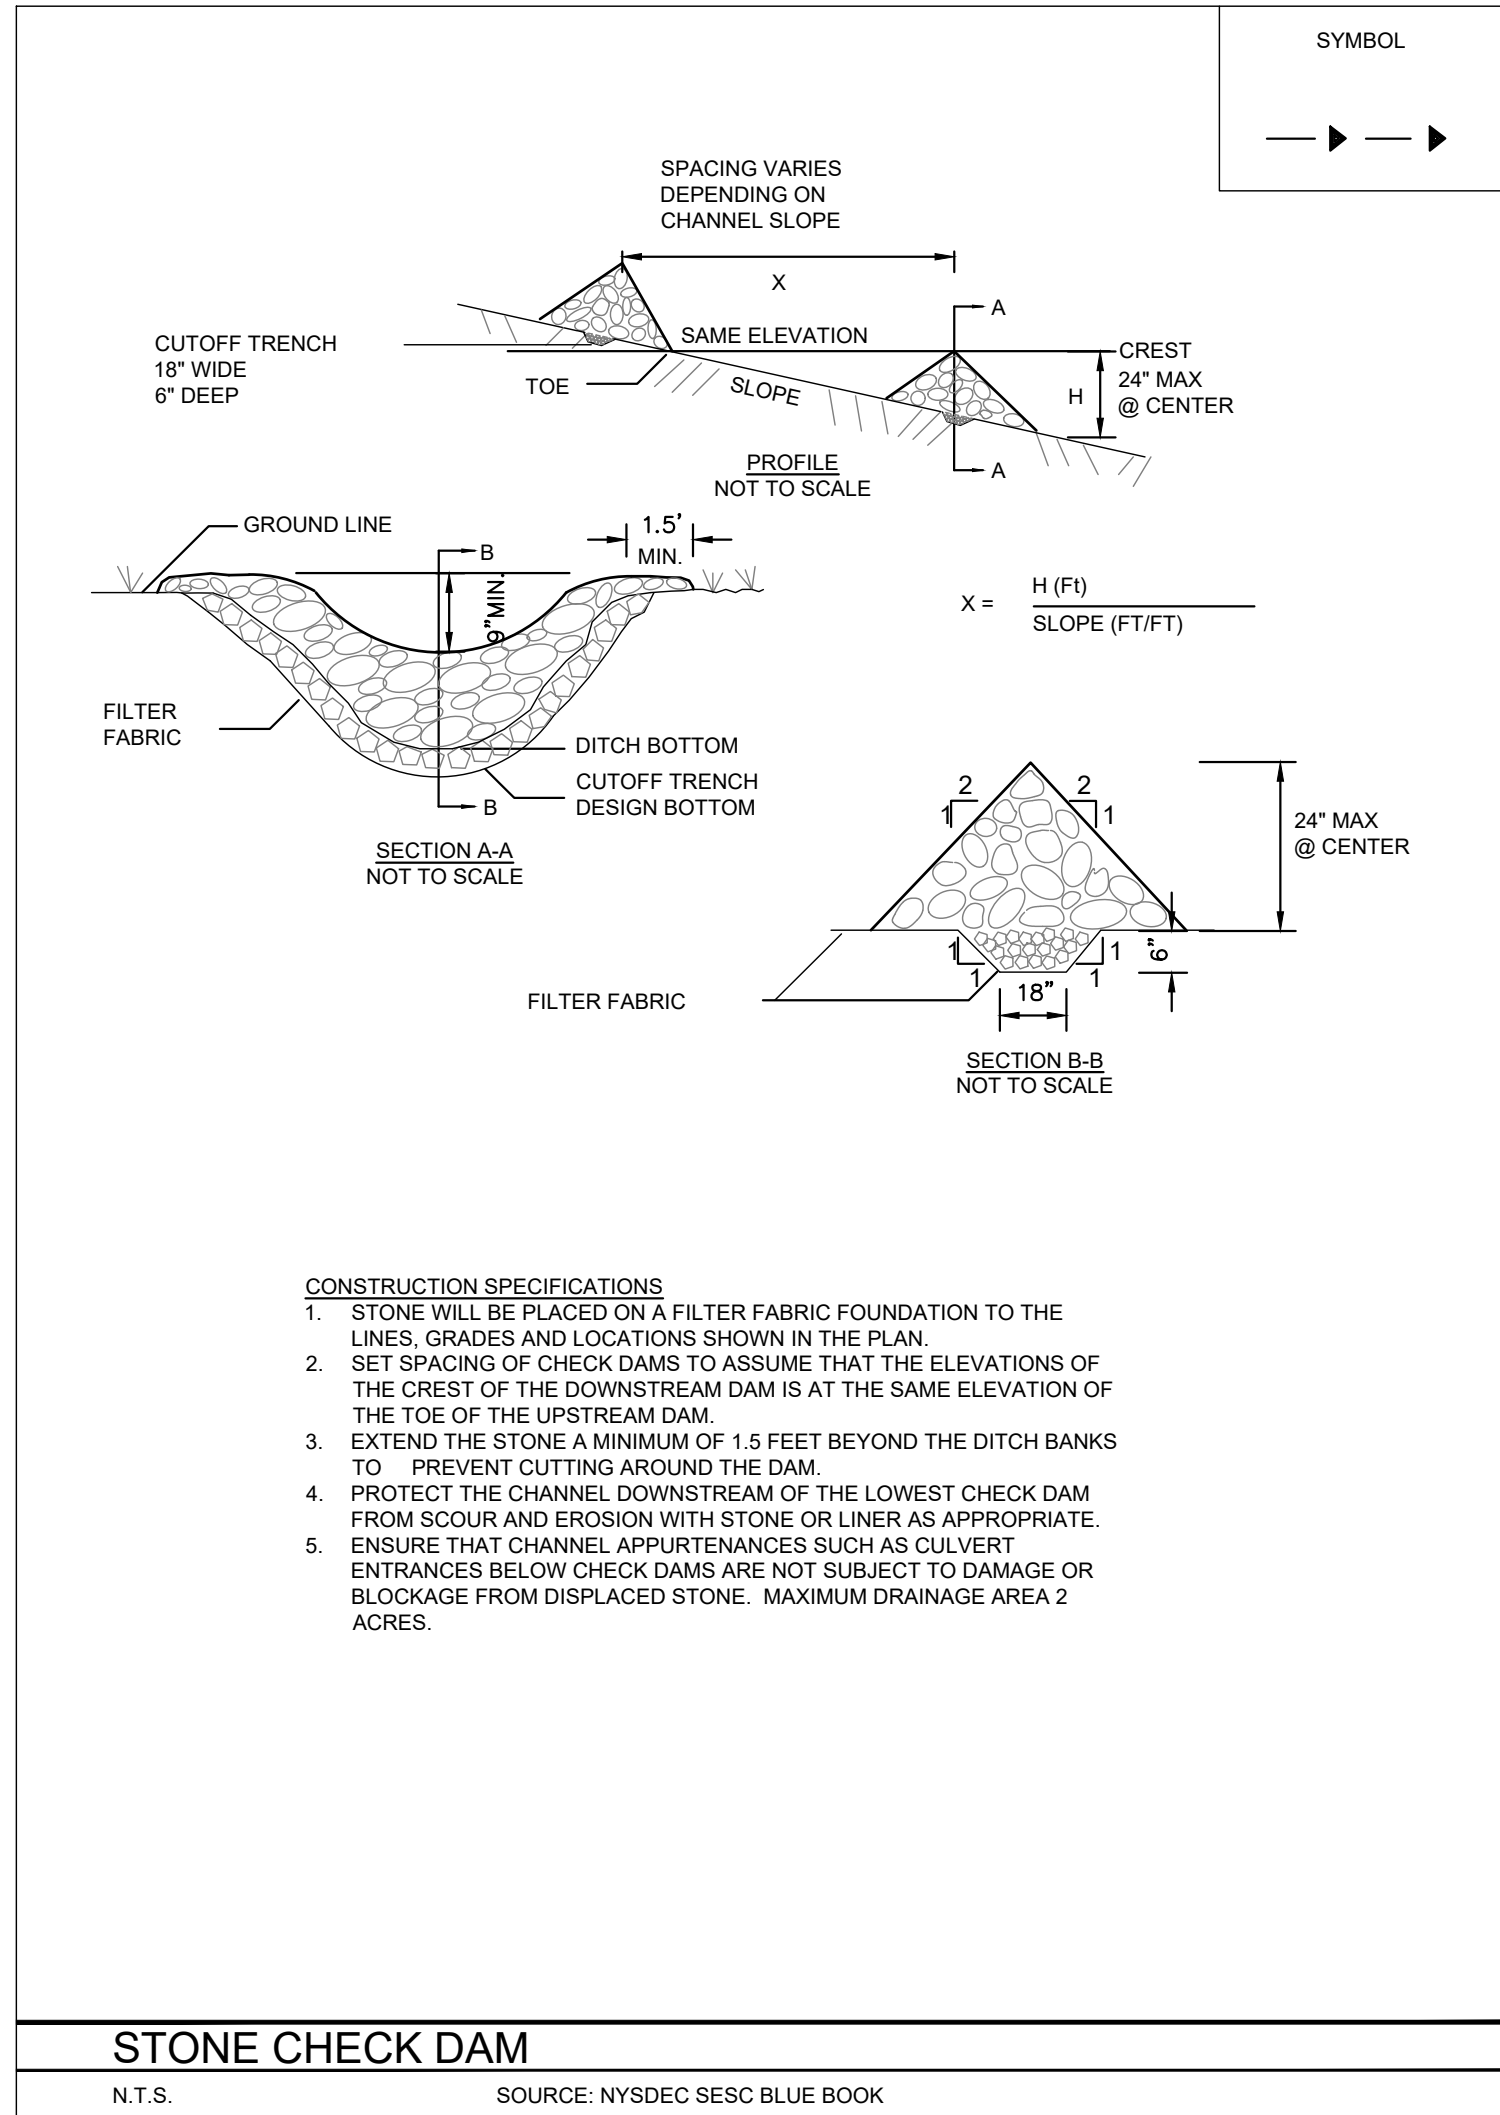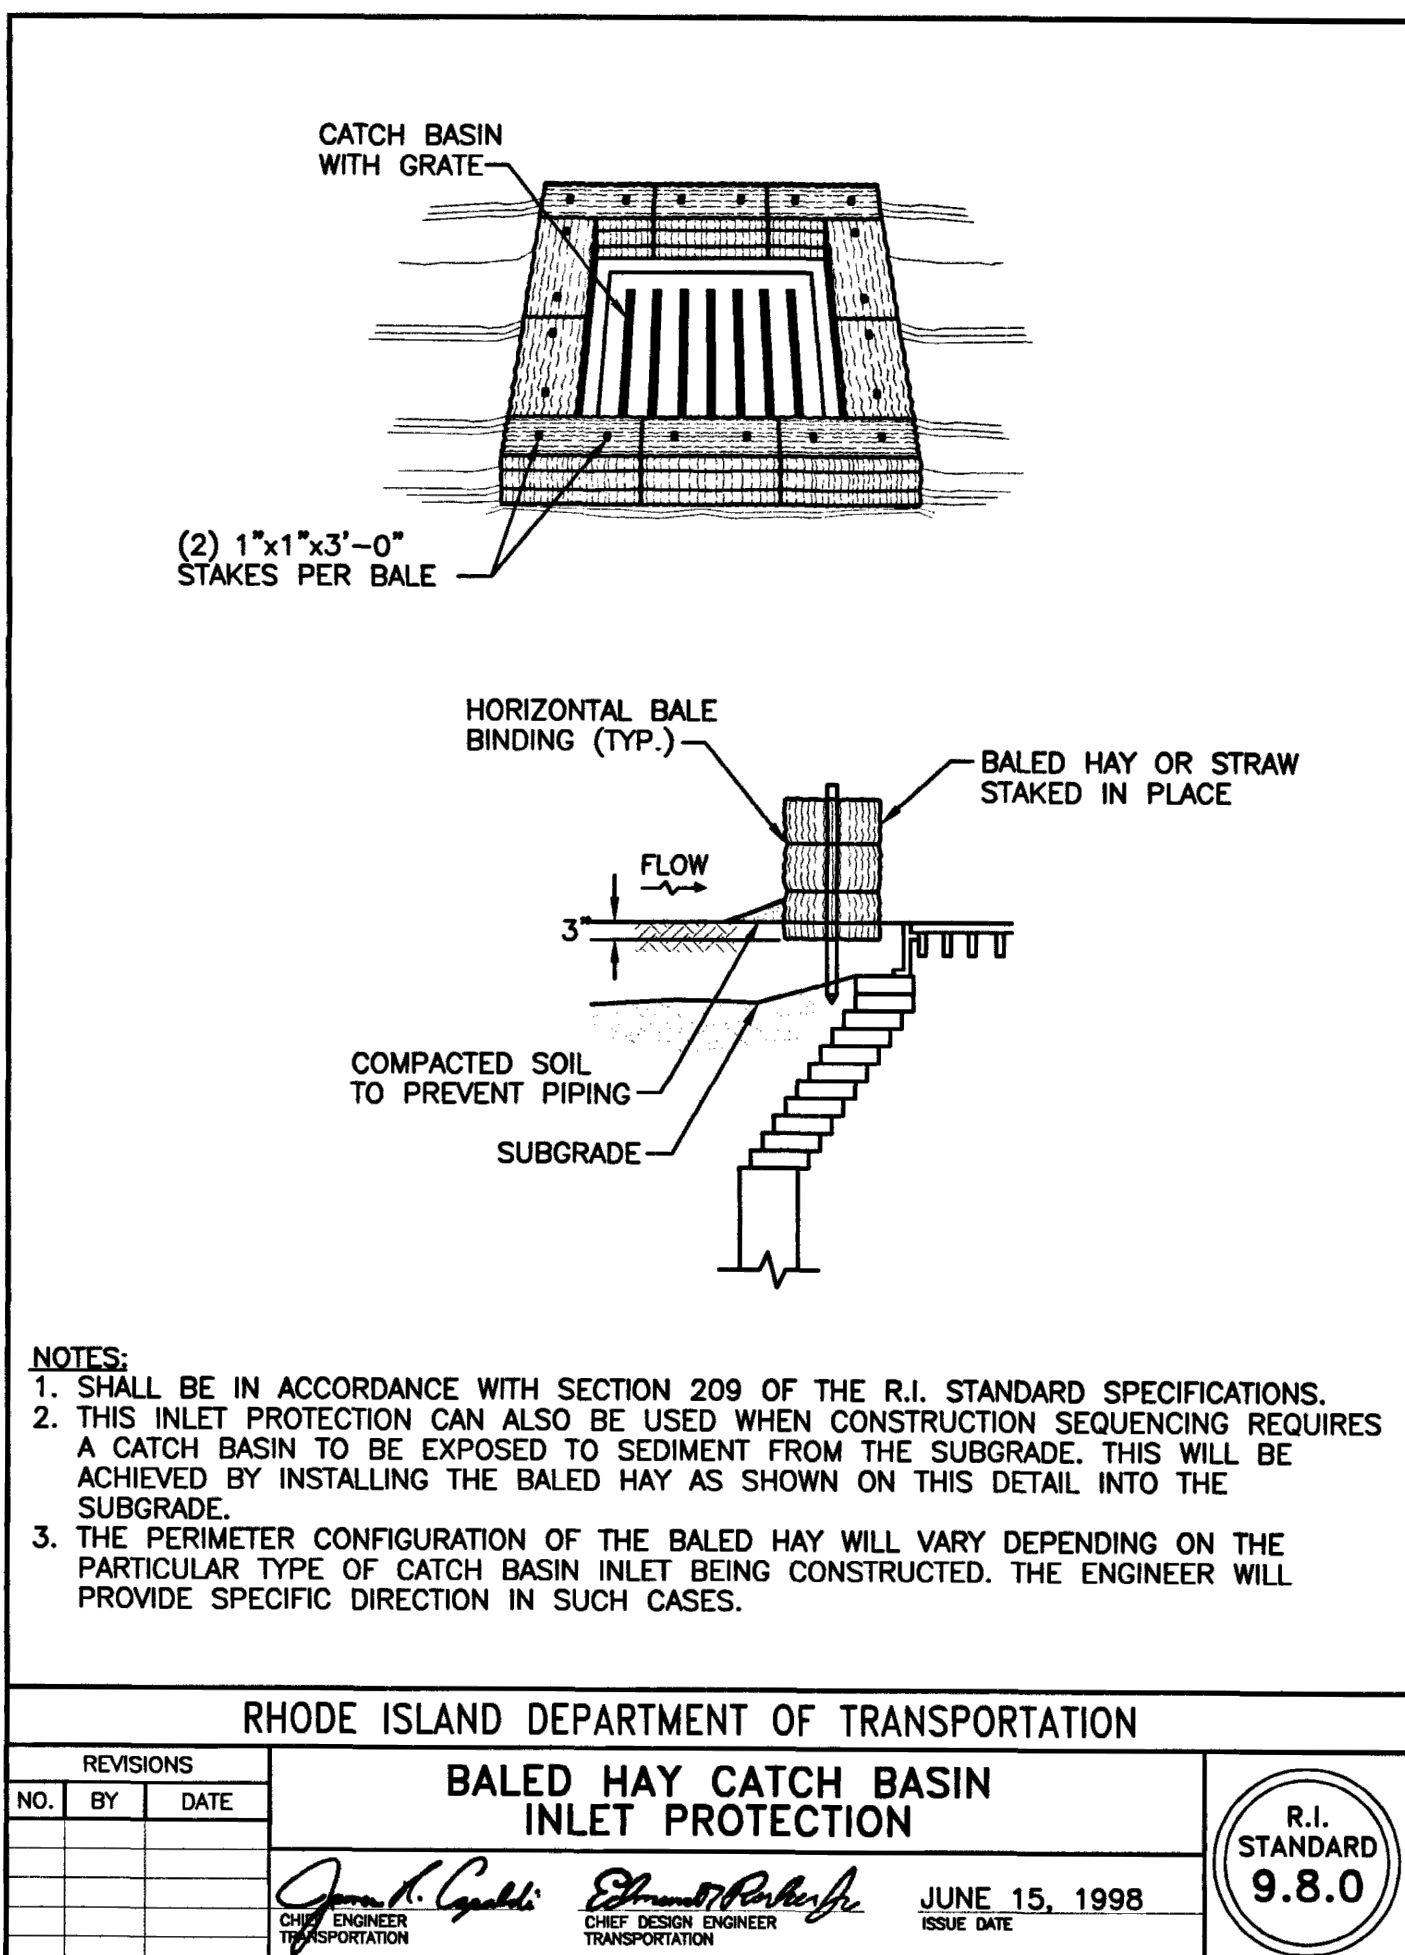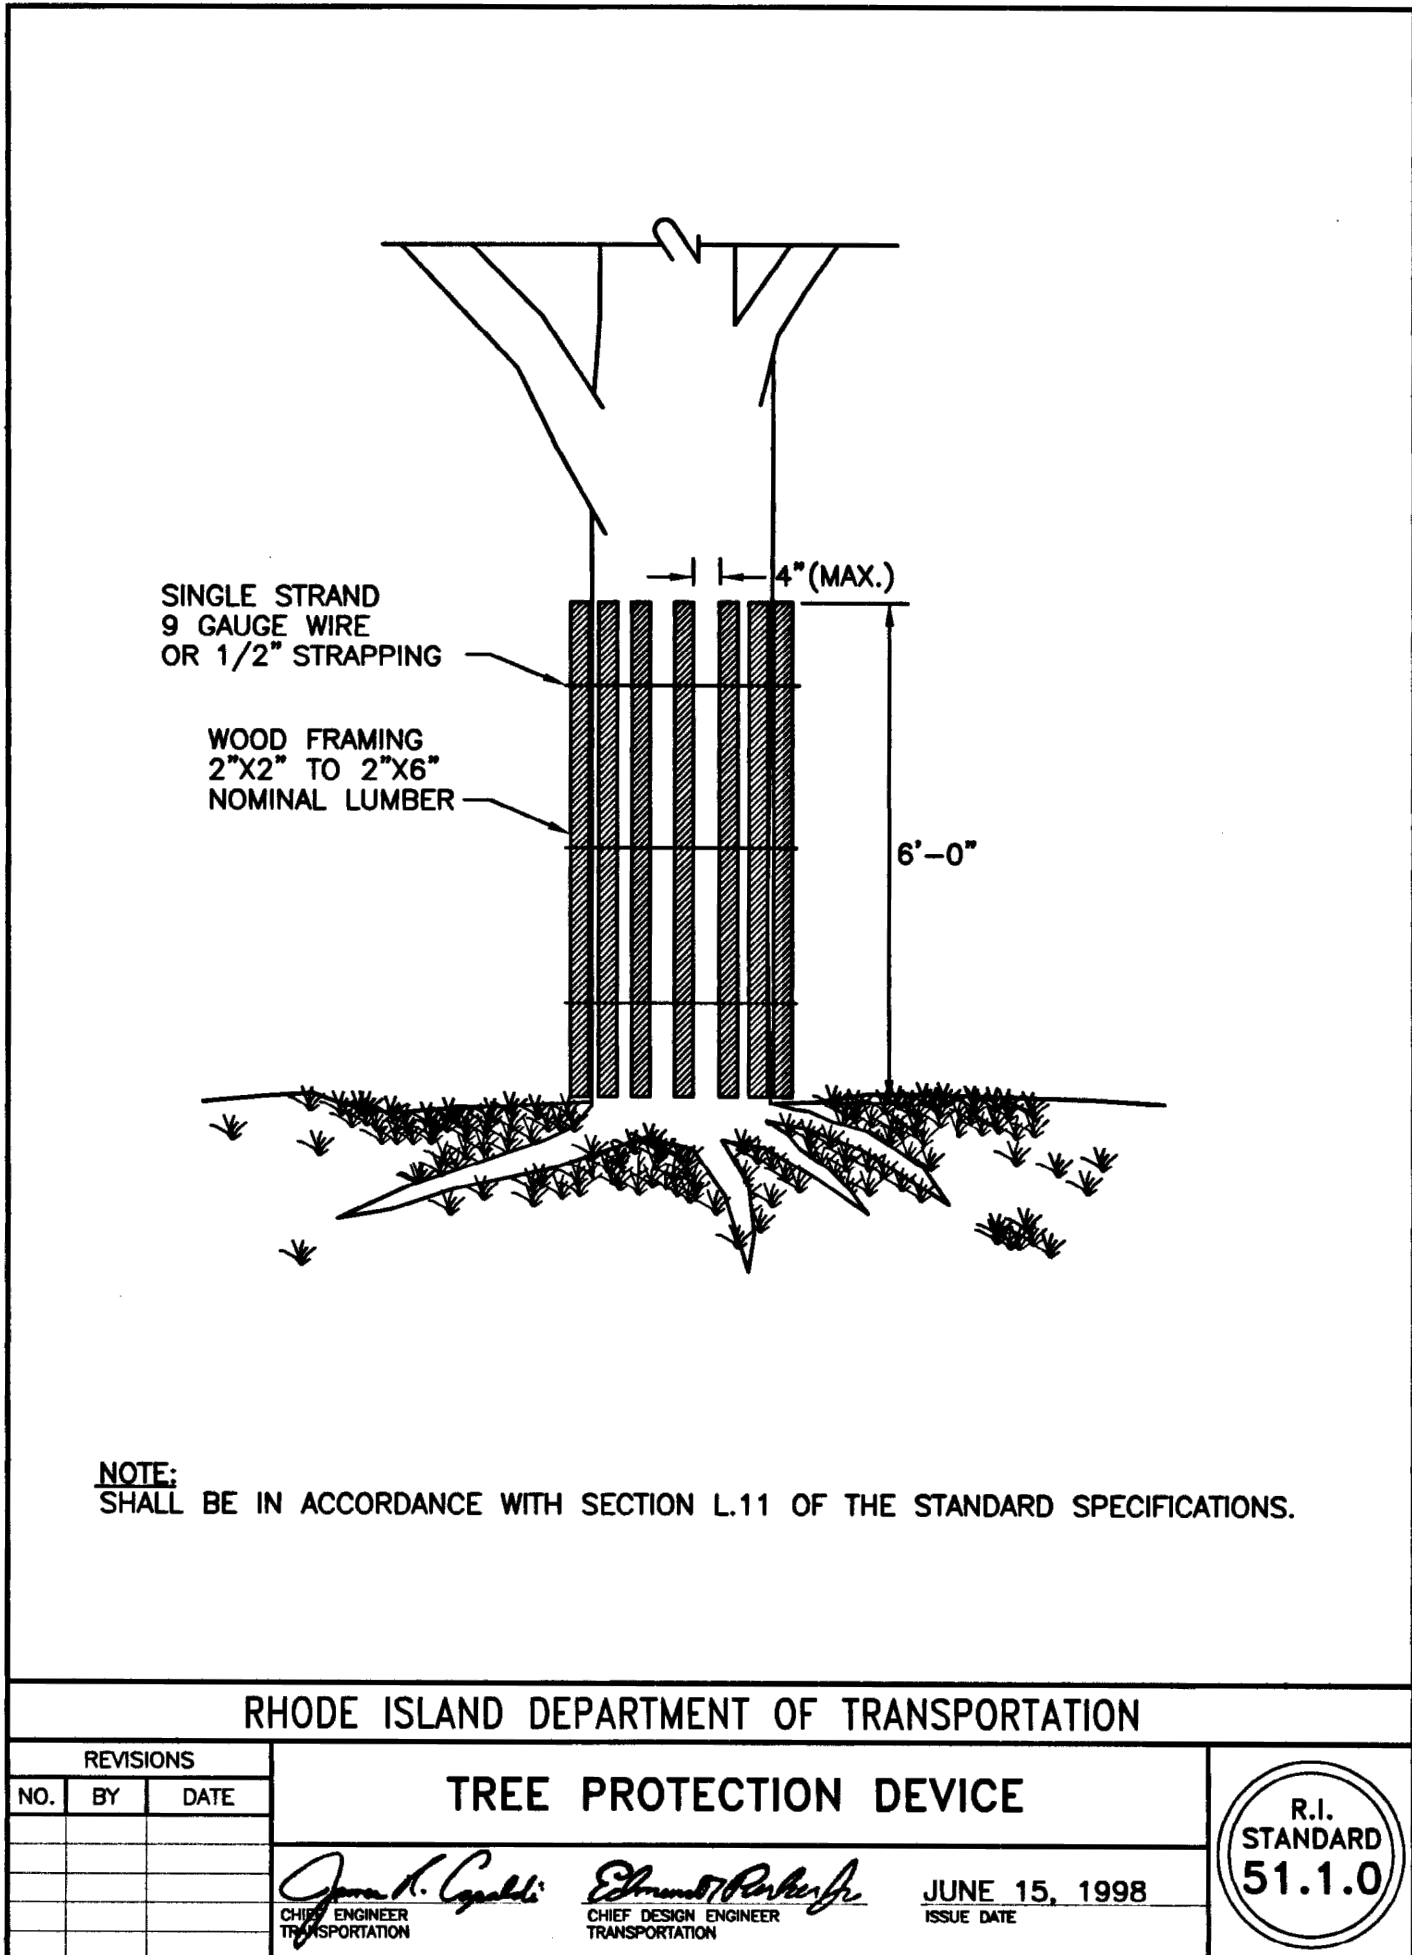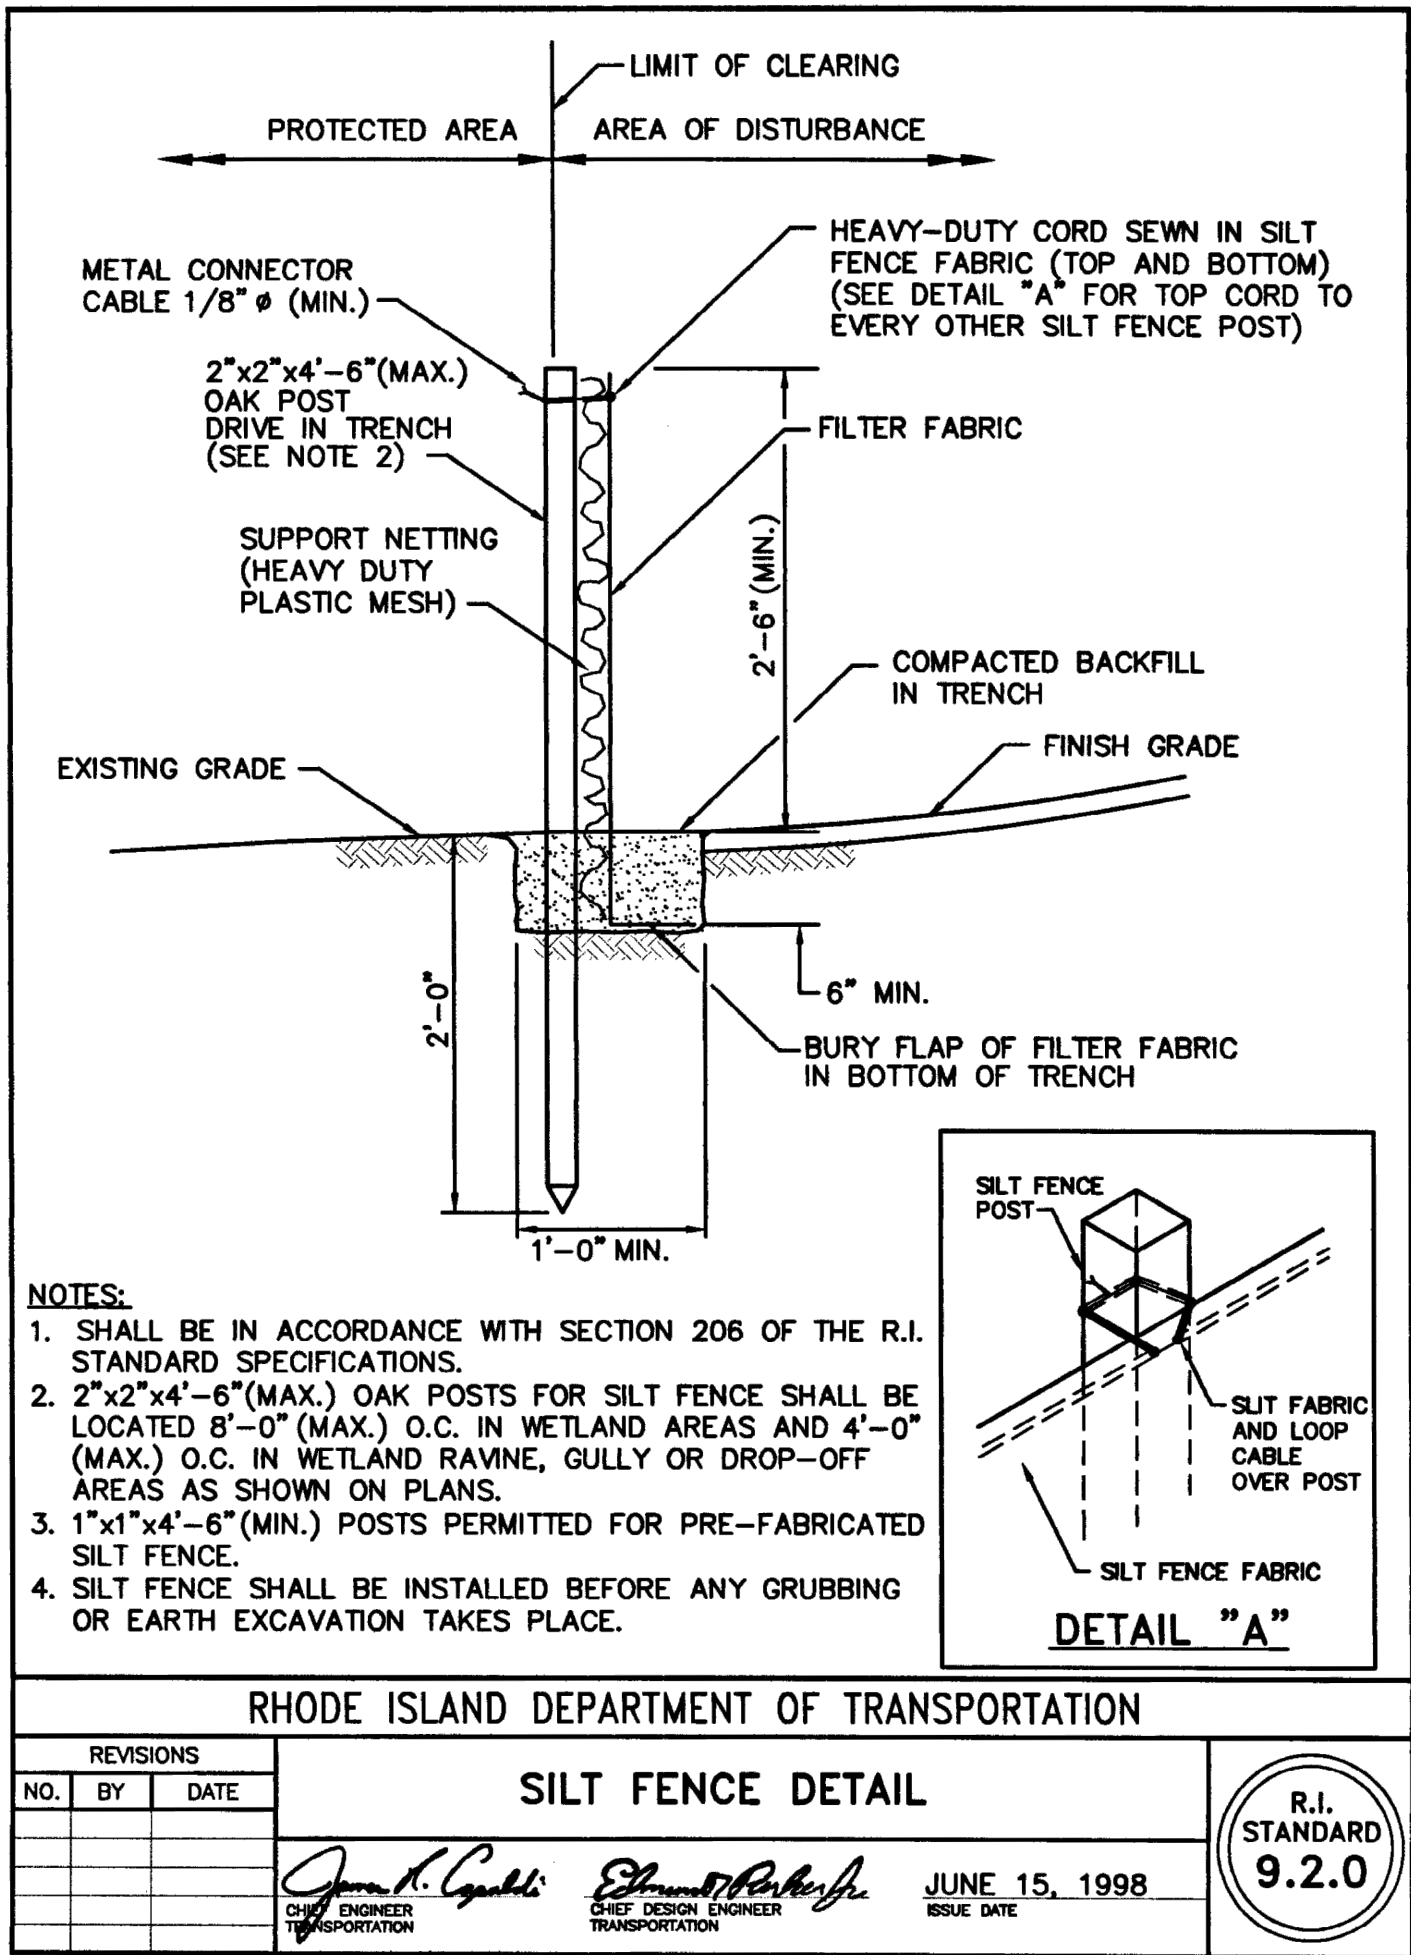

MEASURE	CALLOUT	SYMBOL
LIMIT OF DISTURBANCE		
SAFETY FENCE		
CONSTRUCTION ENTRANCE		
SILT FENCE		
INLET PROTECTION		
CULVERT INLET PROTECTION		
TEMPORARY SEEDING		
PERMANENT SEEDING		
TREE PROTECTION		
EROSION EEL		





## TREES

CODE	REQUIREMENT	PROPOSED
§ XVII-255-1740D COMMERCIAL PERIMETER LANDSCAPING	1 TREE 5 SHRUBS PER 35 LINEAR FEET  2.5' HT. BERM	303' BUFFER 9 TREES 43 SHRUBS
§ XVII-255-1750A PARKING LOT LANDSCAPING	3' HT. EVERGREEN HEDGE	SEE PLAN
§ XVII-255-1750B PARKING LOT PERIMETER LANDSCAPING	1 SHADE TREE PER 40 LF PARKING LOT PERIMETER	80 LF PARKING PERIMETER 2 TREES
§ XVII-255-1750C PARKING LOT AREA LANDSCAPING	5% OF INTERIOR LANDSCAPING	787 SF PARKING AREA 787 * 5% = 40 40 SF PARKING LANDSCAPING PROVIDED SEE PLAN

 PROPERTY LINE  
 PROP. BUILDING  
 PROP. ASPHALT  
 PROP. SIDEWALK  
 EXIST. WATER  
 PROP. WATER  
 EXIST. SEWER  
 PROP. SEWER  
 PROP. STORM LINE

