
# COVENTRY SELF STORAGE PRELIMINARY SITE PLAN

1920 NOOSENECK HILL ROAD COVENTRY, RHODE ISLAND



# LOCATION PLAN

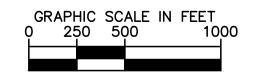



#### UTILITY & GOVERNING AGENCIES

ELECTRIC
NATIONAL GRID
280 MELROSE ST
PROVIDENCE, RI 02907
TEL: (800) 322-3223

NATURAL GAS
NATIONAL GRID
280 MELROSE ST
PROVIDENCE, RI 02907
TEL: (800) 322-3223

WATER
KENT COUNTY WATER AUTHORITY
1072 MAIN STREET

PO BOX 192 WEST WARWICK, RI 02893 TEL: (401) 821-9300

## PROJECT TEAM

OWNER/APPLICANT

NOOSENECK HILL COVENTRY, LLC

MORGAN BULLEN
75 COMMERCE DRIVE
PO BOX 859
GRAYSLAKE, IL 60030
(403) 828-5490

LEGAL COUNSELCIVIL ENGINEERROBINSON COLE, LLPKIMLEY-HORN AND ASSOCIATESGEORGE WATSONCONTACT: STEVEN FUSCOGWATSON@RC.COM271 WAVERLEY OAKS ROAD, SUITE 302<br/>WALTHAM, MA 02452

WALTHAM, MA 02452 (617) 351-9912 ENGINEER OF RECORD: BRIAN BREWER 2035 MAYWILL STREET, SUITE 200, RICHMOND, VA 23230 757-589-1832 **SURVEYOR** 

(540) 428-3550

MARTIN SURVEYING ASSOCIATES

CONTACT: DEAN MARTIN

6593 COMMERCE COURT

WARRENTON, VA 20187

# EARTHWORK ESTIMATE

CUT: 0 CY

FILL: 6870 CY


NET: 6870 CY (IMPORT)

NOTE: THE ABOVE QUANTITIES ARE APPROXIMATE IN PLACE VOLUMES CALCULATED FROM THE EXISTING GROUND TO THE PROPOSED FINISHED GRADE. EXISTING GROUND IS DEFINED BY THE CONTOURS AND SPOT GRADES ON THE BASE SURVEY. PROPOSED FINISHED GRADE IS DEFINED AS THE FINAL GRADE AS INDICATED ON THE GRADING PLAN(S).

THE EARTHWORK QUANTITIES ABOVE ARE FOR PERMIT PURPOSES ONLY. THEY HAVE NOT BEEN FACTORED TO ACCOUNT FOR CHANGES IN VOLUME DUE TO BULKING, CLEARING AND GRUBBING, SHRINKAGE, OVER-EXCAVATION AND RE-COMPACTION, AND CONSTRUCTION METHODS. NOR DO THEY ACCOUNT FOR THE THICKNESS OF PAVEMENT SECTIONS, FOOTINGS, SLABS, REUSE OF PULVERIZED MATERIALS THAT WILL UNDERLIE NEW PAVEMENTS, ETC. THE CONTRACTOR SHALL RELY ON THEIR OWN EARTHWORK ESTIMATES FOR BIDDING PURPOSES.

**Sheet List Table Sheet Title** Sheet Number **COVER SHEET GENERAL NOTES** C-2.0 **ALTA SURVEY** C-4.0 SITE AND UTILITY PLAN C-4.1 C-4.2 SITE DETAILS C-4.3 UTILITY DETAILS & SSWR PROFILE C-4.4 UTILITY DETAILS C-5.0 OVERALL GRADING AND DRAINAGE PLAN C-5.1 C-5.2 C-6.0 **EROSION & SEDIMENT CONTROL DETAILS** L-1.0 LANDSCAPE NOTES AND DETAILS

© 2024 KIMLEY-HORN AND ASSOC 271 WAVERLEY OAKS RD, SUITE 302, WA PHONE: 781-328-0676

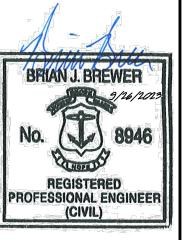

SCALE AS SHOWN
DESIGNED BY CGA
DRAWN BY CGA

OVER SHEET

PREPARED FOR

USENECK HILL COVENTRY, LLC

1920 NOOSENECK HILL RD

COVENTRY, RI 02816

SHEET NUMBER
C-1.0

VENTR

#### **GENERAL CONSTRUCTION NOTES**

- 1. THE CONTRACTOR AND SUBCONTRACTORS SHALL OBTAIN A COPY OF THE RHODE ISLAND DEPARTMENT OF TRANSPORTATION "STANDARD SPECIFICATIONS FOR ROAD AND BRIDGES" (LATEST EDITION), ITS SUPPLEMENTS, AND BECOME FAMILIAR WITH THE CONTENTS PRIOR TO COMMENCING WORK.
- 2. THE CONTRACTOR SHALL BE RESPONSIBLE FOR FURNISHING ALL MATERIAL AND LABOR TO CONSTRUCT THE FACILITY AS SHOWN AND DESCRIBED IN THE CONSTRUCTION DOCUMENTS IN ACCORDANCE WITH THE APPROPRIATE APPROVING AUTHORITIES, SPECIFICATIONS AND REQUIREMENTS. CONTRACTOR SHALL CLEAR AND GRUB ALL AREAS UNLESS OTHERWISE INDICATED, REMOVING TREES, STUMPS, ROOTS, MUCK, EXISTING PAVEMENT AND ALL OTHER DELETERIOUS MATERIAL.
- 3. EXISTING UTILITIES SHOWN ARE LOCATED ACCORDING TO THE INFORMATION AVAILABLE TO THE ENGINEER AT THE TIME OF THE TOPOGRAPHIC SURVEY AND HAVE NOT BEEN INDEPENDENTLY VERIFIED BY THE OWNER OR THE ENGINEER. GUARANTEE IS NOT MADE THAT ALL EXISTING UNDERGROUND UTILITIES ARE SHOWN OR THAT THE LOCATION OF THOSE SHOWN ARE ENTIRELY ACCURATE. FINDING THE ACTUAL LOCATION OF ANY EXISTING UTILITIES IS THE CONTRACTOR'S RESPONSIBILITY AND SHALL BE DONE BEFORE HE COMMENCES ANY WORK IN THE VICINITY. FURTHERMORE, THE CONTRACTOR SHALL BE FULLY RESPONSIBLE FOR ANY AND ALL DAMAGES DUE TO THE CONTRACTOR'S FAILURE TO EXACTLY LOCATE AND PRESERVE ANY AND ALL UNDERGROUND UTILITIES. THE OWNER OR ENGINEER WILL ASSUME NO LIABILITY FOR ANY DAMAGES SUSTAINED OR COST INCURRED BECAUSE OF THE OPERATIONS IN THE VICINITY OF EXISTING UTILITIES OR STRUCTURES, NOR FOR TEMPORARY BRACING AND SHORING OF SAME. IF IT IS NECESSARY TO SHORE, BRACE, SWING OR RELOCATE A UTILITY, THE UTILITY COMPANY OR DEPARTMENT AFFECTED SHALL BE CONTACTED AND THEIR PERMISSION OBTAINED REGARDING THE METHOD TO USE FOR SUCH WORK.
- 4. IT IS THE CONTRACTOR'S RESPONSIBILITY TO CONTACT THE VARIOUS UTILITY COMPANIES WHICH MAY HAVE BURIED OR AERIAL UTILITIES WITHIN OR NEAR THE CONSTRUCTION AREA BEFORE COMMENCING WORK. THE CONTRACTOR SHALL PROVIDE 3 BUSINESS DAYS MINIMUM NOTICE TO ALL UTILITY COMPANIES PRIOR TO BEGINNING CONSTRUCTION. A LIST OF THE UTILITY COMPANIES WHICH THE CONTRACTOR MUST CALL BEFORE COMMENCING WORK IS PROVIDED ON THE COVER SHEET OF THESE CONSTRUCTION PLANS. THIS LIST SERVES AS A GUIDE ONLY AND IS NOT INTENDED TO LIMIT THE UTILITY COMPANIES WHICH THE CONTRACTOR MAY WISH TO NOTIFY.
- 5. THE CONTRACTOR SHALL BE RESPONSIBLE FOR OBTAINING ALL REQUIRED CONSTRUCTION PERMITS AND BONDS IF REQUIRED PRIOR TO CONSTRUCTION.
- THE CONTRACTOR SHALL HAVE AVAILABLE AT THE JOB SITE AT ALL TIMES ONE COPY OF THE CONSTRUCTION DOCUMENTS INCLUDING PLANS, SPECIFICATIONS, AND SPECIAL CONDITIONS AND COPIES OF ANY REQUIRED CONSTRUCTION PERMITS INCLUDING THE NATIONAL POLLUTANT DISCHARGE ELIMINATION SYSTEM (NPDES) PERMIT AND ASSOCIATED STORMWATER POLLUTION PREVENTION PLAN (SWPPP).
- 7. ANY DISCREPANCIES ON THE DRAWINGS SHALL BE IMMEDIATELY BROUGHT TO THE ATTENTION OF THE OWNER AND ENGINEER BEFORE COMMENCING WORK. NO FIELD CHANGES OR DEVIATIONS FROM DESIGN ARE TO BE MADE WITHOUT PRIOR APPROVAL OF THE OWNER AND NOTIFICATION TO THE ENGINEER.
- 8. ALL COPIES OF COMPACTION, CONCRETE AND OTHER REQUIRED TEST RESULTS ARE TO BE SENT TO THE OWNER AND DESIGN ENGINEER OF RECORD DIRECTLY FROM THE TESTING AGENCY.
- 9. THE CONTRACTOR SHALL BE RESPONSIBLE FOR SUBMITTING TO THE ENGINEER A CERTIFIED RECORD SURVEY SIGNED AND SEALED BY A PROFESSIONAL LAND SURVEYOR REGISTERED IN THE STATE OF RHODE ISLAND DEPICTING THE ACTUAL FIELD LOCATION OF ALL CONSTRUCTED IMPROVEMENTS THAT ARE REQUIRED BY THE JURISDICTIONAL AGENCIES FOR THE CERTIFICATION PROCESS. ALL SURVEY COSTS WILL BE THE CONTRACTORS RESPONSIBILITY.
- 10. THE CONTRACTOR SHALL BE RESPONSIBLE FOR DOCUMENTING AND MAINTAINING AS-BUILT INFORMATION WHICH SHALL BE RECORDED AS CONSTRUCTION PROGRESSES OR AT THE COMPLETION OF APPROPRIATE CONSTRUCTION INTERVALS AND SHALL BE RESPONSIBLE FOR PROVIDING AS-BUILT DRAWINGS TO THE OWNER FOR THE PURPOSE OF CERTIFICATION TO JURISDICTIONAL AGENCIES AS REQUIRED. ALL AS-BUILT DATA SHALL BE COLLECTED BY A STATE OF RHODE ISLAND PROFESSIONAL LAND SURVEYOR WHOSE SERVICES ARE ENGAGED BY THE CONTRACTOR.
- 11. ANY WELLS DISCOVERED ON SITE THAT WILL HAVE NO USE MUST BE PLUGGED BY A LICENSED WELL DRILLING CONTRACTOR IN A MANNER APPROVED BY ALL JURISDICTIONAL AGENCIES. CONTRACTOR SHALL BE RESPONSIBLE FOR OBTAINING ANY WELL ABANDONMENT PERMITS REQUIRED.
- 12. ANY WELL DISCOVERED DURING EARTH MOVING OR EXCAVATION SHALL BE REPORTED TO THE APPROPRIATE JURISDICTIONAL AGENCIES WITHIN 24 HOURS AFTER DISCOVERY
- 13. THE CONTRACTOR SHALL BE RESPONSIBLE FOR VERIFYING THAT THE PROPOSED IMPROVEMENTS SHOWN ON THE PLANS DO NOT CONFLICT WITH ANY KNOWN EXISTING OR OTHER PROPOSED IMPROVEMENTS. IF ANY CONFLICTS ARE DISCOVERED, THE CONTRACTOR SHALL NOTIFY THE OWNER PRIOR TO INSTALLATION OF ANY PORTION OF THE SITE WORK THAT WOULD BE AFFECTED. FAILURE TO NOTIFY OWNER OF AN IDENTIFIABLE CONFLICT PRIOR TO PROCEEDING WITH INSTALLATION RELIEVES OWNER OF ANY OBLIGATION TO PAY FOR A RELATED CHANGE ORDER.
- 14. IN ACCORDANCE WITH THE GEOTECHNICAL ENGINEER'S REPORT FOR THE SITE, ALL FILL FOR PAVEMENT OR BUILDING PAD SUBGRADE SHALL BE STRUCTURAL FILL AND COMPACTED TO 95% ASTM D-1557 (MODIFIED PROCTOR), UNLESS OTHERWISE DIRECTED BY THE GEOTECHNICAL ENGINEER.
- 15. DURING CONSTRUCTION, NO WORK ON THE SITE SHALL BEGIN BEFORE 8:00AM OR EXTEND LATER THAN 5PM MONDAY THROUGH SATURDAY. NO WORK ON SUNDAYS OR BANK HOLIDAYS.

#### **DEMOLITION NOTES**

- 1. ALL MATERIAL REMOVED FROM THIS SITE BY THE CONTRACTOR SHALL BE DISPOSED OF BY THE CONTRACTOR IN A LEGAL MANNER.
- 2. REFER TO THE TOPOGRAPHIC SURVEY FOR ADDITIONAL DETAILS OF EXISTING STRUCTURES, ETC., LOCATED WITHIN THE PROJECT SITE. UNLESS OTHERWISE NOTED, ALL EXISTING BUILDINGS, STRUCTURES, FOUNDATIONS, SLABS, CONCRETE, ASPHALT, DEBRIS PILES, SIGNS, AND ALL APPURTENANCES ARE TO BE REMOVED FROM THE SITE BY THE FOUNDATIONS CONTRACTOR AND PROPERLY DISPOSED OF IN A LEGAL MANNER AS PART OF THIS CONTRACT. SOME ITEMS TO BE REMOVED MAY NOT BE DEPICTED ON THE TOPOGRAPHIC SURVEY. IT IS THE CONTRACTOR'S RESPONSIBILITY TO VISIT THE SITE AND DETERMINE THE FULL EXTENT OF ITEMS TO BE REMOVED. IF ANY ITEMS ARE IN QUESTION, THE CONTRACTOR SHALL CONTACT THE OWNER PRIOR TO REMOVAL OF SAID ITEMS.
- 3. THE CONTRACTOR SHALL REFER TO THE DEMOLITION PLAN FOR DEMOLITION/PRESERVATION OF EXISTING TREES. ALL TREES NOT SPECIFICALLY SHOWN TO BE PRESERVED OR RELOCATED SHALL BE REMOVED AS A PART OF THIS CONTRACT. TREE PROTECTION FENCING SHALL BE INSTALLED PRIOR TO ANY DEMOLITION.

#### PAVING, GRADING AND DRAINAGE NOTES

- 1. ALL PAVING, CONSTRUCTION, MATERIALS, AND WORKMANSHIP WITHIN STATE AND TOWN RIGHT-OF-WAY SHALL BE IN ACCORDANCE WITH LOCAL OR STATE SPECIFICATIONS AND STANDARDS (LATEST EDITION) OR RIDOT SPECIFICATIONS AND STANDARDS (LATEST EDITION) IF NOT COVERED BY STATE OR TOWN REGULATIONS.
- 2. ALL UNPAVED AREAS IN EXISTING RIGHTS-OF-WAY DISTURBED BY CONSTRUCTION SHALL BE REGRADED AND SODDED.
- 3. TRAFFIC CONTROL ON ALL TOWN AND STATE RIGHTS-OF-WAY SHALL MEET THE REQUIREMENTS OF THE MANUAL OF UNIFORM TRAFFIC CONTROL DEVICES (U.S. DOT/FHA) AND THE REQUIREMENTS OF THE STATE AND ANY LOCAL AGENCY HAVING JURISDICTION. IN THE EVENT THAT THE CONTRACT DOCUMENTS AND THE JURISDICTIONAL AGENCY REQUIREMENTS ARE NOT IN AGREEMENT, THE MOST STRINGENT SHALL GOVERN.
- 4. THE CONTRACTOR SHALL GRADE THE SITE TO THE ELEVATIONS INDICATED AND SHALL REGRADE WASHOUTS WHERE THEY OCCUR AFTER EVERY RAINFALL UNTIL A GRASS STAND IS WELL ESTABLISHED OR ADEQUATE STABILIZATION OCCURS.
- 5. ALL OPEN AREAS WITHIN THE PROJECT SITE SHALL BE SODDED UNLESS INDICATED OTHERWISE ON THE LANDSCAPE PLAN.
- 6. ALL AREAS INDICATED AS PAVEMENT SHALL BE CONSTRUCTED IN ACCORDANCE WITH THE TYPICAL PAVEMENT SECTIONS AS INDICATED ON THE DRAWINGS.
- 7. WHERE EXISTING PAVEMENT IS INDICATED TO BE REMOVED AND REPLACED, THE CONTRACTOR SHALL SAW CUT A MINIMUM 2" DEEP FOR A SMOOTH AND STRAIGHT JOINT AND REPLACE THE PAVEMENT WITH THE SAME TYPE AND DEPTH OF MATERIAL AS EXISTING OR AS INDICATED.
- 8. WHERE NEW PAVEMENT MEETS THE EXISTING PAVEMENT, THE CONTRACTOR SHALL SAW CUT THE EXISTING PAVEMENT A MINIMUM 2" DEEP FOR A SMOOTH AND STRAIGHT JOINT AND MATCH THE EXISTING PAVEMENT ELEVATION WITH THE PROPOSED PAVEMENT UNLESS OTHERWISE INDICATED.
- 9. THE CONTRACTOR SHALL INSTALL FILTER FABRIC OVER ALL DRAINAGE STRUCTURES FOR THE DURATION OF CONSTRUCTION AND UNTIL ACCEPTANCE OF THE PROJECT BY THE OWNER. ALL DRAINAGE STRUCTURES SHALL BE CLEANED OF DEBRIS AS REQUIRED DURING AND AT THE END OF CONSTRUCTION TO PROVIDE POSITIVE DRAINAGE FLOWS.
- 10. IF DEWATERING IS REQUIRED, THE CONTRACTOR SHALL OBTAIN ANY APPLICABLE REQUIRED PERMITS. THE CONTRACTOR IS TO COORDINATE WITH THE OWNER AND THE DESIGN ENGINEER PRIOR TO ANY EXCAVATION. EFFLUENT FROM DEWATERING OPERATIONS SHALL BE FILTERED OR PASSED THROUGH AN APPROVED SEDIMENT TRAPPING DEVICE, SEDIMENTATION TANK OR STRAW BALE/SILT FENCE PIT, OR BOTH, AND DISCHARGED IN A MANNER THAT DOES NOT ADVERSELY AFFECT ADJACENT PROPERTIES, WETLANDS, WATERWAYS OR THE STORM DRAINAGE SYSTEM. CONTRACTOR IS RESPONSIBLE FOR SIZING TANK OR PITS BASED ON PROPOSED FLOWS FROM DEWATERING OPERATIONS.
- 11. STRIP TOPSOIL AND ORGANIC MATTER FROM ALL AREAS OF THE SITE AS REQUIRED. IN SOME CASES TOPSOIL MAY BE STOCKPILED ON SITE FOR PLACEMENT WITHIN LANDSCAPED AREAS BUT ONLY AS DIRECTED BY THE OWNER.
- 12. FIELD DENSITY TESTS SHALL BE TAKEN AT INTERVALS IN ACCORDANCE WITH THE LOCAL JURISDICTIONAL AGENCY OR TO MASS HIGHWAY STANDARDS. IN THE EVENT THAT THE CONTRACT DOCUMENTS AND THE JURISDICTIONAL AGENCY REQUIREMENTS ARE NOT IN AGREEMENT, THE MOST STRINGENT SHALL GOVERN.
- 13. ALL SLOPES AND AREAS DISTURBED BY CONSTRUCTION SHALL BE GRADED AS PER PLANS. THE AREAS SHALL THEN BE SODDED OR SEEDED AS SPECIFIED IN THE PLANS, FERTILIZED, MULCHED, WATERED AND MAINTAINED UNTIL HARDY GRASS GROWTH IS ESTABLISHED IN ALL AREAS. ANY AREAS DISTURBED FOR ANY REASON PRIOR TO FINAL ACCEPTANCE OF THE JOB SHALL BE CORRECTED BY THE CONTRACTOR AT NO ADDITIONAL COST TO THE OWNER. ALL EARTHEN AREAS WILL BE SODDED OR SEEDED AND MULCHED AS SHOWN ON THE LANDSCAPING PLAN.
- 14. ALL CUT OR FILL SLOPES SHALL BE 4 (HORIZONTAL) :1 (VERTICAL) OR FLATTER UNLESS OTHERWISE SHOWN.
- 15. THE CONTRACTOR SHALL BE RESPONSIBLE FOR THE CONTROL OF DUST AND DIRT RISING AND SCATTERING IN THE AIR DURING CONSTRUCTION AND SHALL PROVIDE WATER SPRINKLING OR OTHER SUITABLE METHODS OF CONTROL. THE CONTRACTOR SHALL COMPLY WITH ALL GOVERNING REGULATIONS PERTAINING TO ENVIRONMENTAL PROTECTION.
- 16. SOD, WHERE CALLED FOR, MUST BE INSTALLED AND MAINTAINED ON EXPOSED SLOPES WITHIN 48 HOURS OF COMPLETING FINAL GRADING, AND AT ANY OTHER TIME AS NECESSARY, TO PREVENT EROSION, SEDIMENTATION OR TURBID DISCHARGES.
- 17. THE CONTRACTOR SHALL ENSURE THAT ISLAND PLANTING AREAS AND OTHER PLANTING AREAS ARE NOT COMPACTED AND DO NOT CONTAIN ROAD BASE MATERIALS. THE CONTRACTOR SHALL ALSO EXCAVATE AND REMOVE ALL UNDESIRABLE MATERIAL FROM ALL AREAS ON THE SITE TO BE PLANTED AND PROPERLY DISPOSED OF IN A LEGAL MANNER.
- 18. THE CONTRACTOR SHALL ENSURE THAT ALL ONSITE DRAINAGE PIPES AND NEXT DOWNSTREAM DRAINAGE PIPE ARE CLEANED FOLLOWING CONSTRUCTION.

#### **CONCRETE NOTES**

- 1. CONTRACTOR SHALL VERIFY AND BE RESPONSIBLE FOR ALL DIMENSIONS AND CONDITIONS AT THE JOB SITE.
- FOUNDATION CONCRETE MAY BE PLACED DIRECTLY INTO NEAT EXCAVATIONS, PROVIDED THE SIDES OF THE EXCAVATION ARE STABLE. WHERE CAVING OCCURS, PROVIDE SHORING. TYPE AND METHOD OF SHORING SHALL BE AT CONTRACTORS OPTIONS.
- 3. THE EXCAVATION SHALL BE KEPT DRY AT ALL TIMES. GROUND WATER, IF ENCOUNTERED, SHALL BE PUMPED FROM THE EXCAVATIONS.
- 4. CONCRETE SHALL BE LABORATORY DESIGNED, MACHINE MIXED, PRODUCING 3,000 PSI (MINIMUM) AT 28 DAYS, UNLESS OTHERWISE NOTED IN CONTRACT DOCUMENTS.
- 5. CEMENT SHALL BE TESTED PORTLAND CEMENT CONFORMING TO ASTM C150, TYPE II ONLY.
- 6. AGGREGATES SHALL CONFORM TO ASTM C33 & B GRADE PER STANDARD SPECIFICATIONS. MAXIMUM SIZE OF AGGREGATE SHALL BE 1-1/2 INCHES.
- REINFORCING STEEL SHALL BE DEFORMED BARS CONFORMING TO ASTM A615, GRADE 60 (60,000 PSI).
- 8. HOOKS AND BENDS SHALL CONFORM TO ACI STANDARD 318. LATEST REVISIONS.
  INSIDE DIAMETER OF HOOKS AND BENDS SHALL BE AT LEAST SIX (6) BAR DIAMETERS.
- PROVIDE SPACER BARS, CHAIRS, SPREADERS, BLOCKS, ETC. AS REQUIRED TO POSITIVELY HOLD THE STEEL IN PLACE BEFORE CONCRETE IS POURED.
- 10. CONCRETE SHALL BE CONVEYED FROM THE MIXER TO FINAL DEPOSIT BY METHODS THAT WILL PREVENT SEPARATION OR LOSS OF MATERIALS.
- 11. CONCRETE SHALL BE THOROUGHLY CONSOLIDATED BY SUITABLE MEANS DURING PLACEMENT AND SHALL BE THOROUGHLY WORKED AROUND REINFORCEMENT AND EMBEDDED FIXTURES AND CORNERS OF FORMS.

#### **CONCRETE NOTES (CONT.)**

- 12. CONCRETE SHALL BE MAINTAINED ABOVE 50 DEGREES F (10 DEGREES C) AND IN A MOIST CONDITION FOR AT LEAST SEVEN (7) DAYS AFTER PLACEMENT. ADEQUATE EQUIPMENT SHALL BE PROVIDED FOR HEATING CONCRETE MATERIALS AND PROTECTING CONCRETE DURING FREEZING OR NEAR FREEZING WEATHER.
- 13. WHERE EXTERIOR WALL FACE REQUIRES SHORING AND/OR FORMING, THE FORMS SHALL BE SUBSTANTIAL AND SUFFICIENTLY TIGHT TO PREVENT LEAKAGE. FORMS SHALL NOT BE REMOVED UNTIL THE CONCRETE IS SEVEN (7) DAYS OLD.
- 14. BACKFILLING SHALL BE DONE BY DEPOSITING AND TAMPING INTO PLACE CLEAN SAND OR POURING LEAN CONCRETE, TO 95% COMPACTION. WATER JETTING SHALL NOT BE ALLOWED.
- 15. CONDUITS AND PIPES OF ALUMINUM SHALL NOT BE ALLOWED.
- 16. CONSTRUCTION JOINTS NOT INDICATED ON THE DRAWINGS SHALL NOT BE ALLOWED. WHERE A CONSTRUCTION JOINT IS TO BE MADE, THE SURFACE OF THE CONCRETE SHALL BE THOROUGHLY CLEANED AND ALL LAITANCE AND STANDING WATER REMOVED.
- 17. CONTRACTOR SHALL BE RESPONSIBLE FOR THE PROTECTION OF ALL ADJACENT AREAS AGAINST DAMAGE AND SHALL REPAIR OR PATCH ALL DAMAGED AREAS TO MATCH EXISTING IMPROVEMENTS.
- 18. CONTRACTOR SHALL KEEP THE CONSTRUCTION AREA CLEAN AT ALL TIMES AND AT COMPLETION OF WORK, REMOVE ALL SURPLUS MATERIALS, EQUIPMENT AND DEBRIS AND LEAVE THE PREMISES IN A CLEAN CONDITION ACCEPTABLE TO THE OWNER OR OWNER'S REPRESENTATIVE.

#### **EROSION CONTROL NOTES**

- 1. THE STORM WATER POLLUTION PREVENTION PLAN ("SWPPP") IS COMPRISED OF THIS EROSION CONTROL PLAN, THE STANDARD DETAILS, THE PLAN NARRATIVE, ATTACHMENTS INCLUDED IN SPECIFICATIONS OF THE SWPPP, PLUS THE PERMIT AND ALL SUBSEQUENT REPORTS AND RELATED DOCUMENTS.
- 2. ALL CONTRACTORS AND SUBCONTRACTORS INVOLVED WITH STORM WATER POLLUTION PREVENTION SHALL OBTAIN A COPY OF THE STORM WATER POLLUTION PREVENTION PLAN AND THE STATE OF RHODE ISLAND POLLUTANT DISCHARGE ELIMINATION SYSTEM GENERAL PERMIT (RIPDES PERMIT) AND BECOME FAMILIAR WITH THEIR CONTENTS.
- 3. THE CONTRACTOR SHALL IMPLEMENT BEST MANAGEMENT PRACTICES AS REQUIRED BY THE SWPPP. ADDITIONAL BEST MANAGEMENT PRACTICES SHALL BE IMPLEMENTED AS DICTATED BY CONDITIONS AT NO ADDITIONAL COST TO THE OWNER THROUGHOUT ALL PHASES OF CONSTRUCTION.
- 4. BEST MANAGEMENT PRACTICES (BMP'S) AND CONTROLS SHALL CONFORM TO FEDERAL, STATE, OR LOCAL REQUIREMENTS OR MANUAL OF PRACTICE, AS APPLICABLE. THE CONTRACTOR SHALL IMPLEMENT ADDITIONAL CONTROLS AS DIRECTED BY THE PERMITTING AGENCY OR OWNER.
- EROSION CONTROL PLAN MUST CLEARLY DELINEATE ALL STATE WATERS. PERMITS FOR ANY CONSTRUCTION ACTIVITY IMPACTING STATE WATERS OR REGULATED WETLANDS MUST BE MAINTAINED ON SITE AT ALL TIMES.
- 6. THE CONTRACTOR SHALL MINIMIZE CLEARING TO THE MAXIMUM EXTENT PRACTICAL OR AS REQUIRED BY THE GENERAL PERMIT.
- 7. CONTRACTOR SHALL DENOTE ON PLAN THE TEMPORARY PARKING AND STORAGE AREA WHICH SHALL ALSO BE USED AS THE EQUIPMENT MAINTENANCE AND CLEANING AREA, EMPLOYEE PARKING AREA, AND AREA FOR LOCATING PORTABLE FACILITIES, OFFICE TRAILERS, AND TOILET FACILITIES.
- 8. ALL WASH WATER (CONCRETE TRUCKS, VEHICLE CLEANING, EQUIPMENT CLEANING, ETC.) SHALL BE DETAINED AND PROPERLY TREATED OR DISPOSED.
- 9. SUFFICIENT OIL AND GREASE ABSORBING MATERIALS AND FLOTATION BOOMS SHALL BE MAINTAINED ON SITE OR READILY AVAILABLE TO CONTAIN AND CLEAN-UP FUEL OR CHEMICAL SPILLS AND LEAKS.
- 10. THE CONTRACTOR SHALL BE RESPONSIBLE FOR DUST CONTROL ON SITE. THE USE OF MOTOR OILS AND OTHER PETROLEUM BASED OR TOXIC LIQUIDS FOR DUST SUPPRESSION OPERATIONS IS PROHIBITED.
- 11. RUBBISH, TRASH, GARBAGE, LITTER, OR OTHER SUCH MATERIALS SHALL BE DEPOSITED INTO SEALED CONTAINERS. MATERIALS SHALL BE PREVENTED FROM LEAVING THE PREMISES THROUGH THE ACTION OF WIND OR STORM WATER DISCHARGE INTO DRAINAGE DITCHES OR WATERS OF THE STATE.
- 12. ALL STORM WATER POLLUTION PREVENTION MEASURES PRESENTED ON THE PLAN, SHALL BE INITIATED AS SOON AS PRACTICABLE.
- 13. STABILIZATION PRACTICES SHOULD BE INITIATED AS SOON AS PRACTICAL, BUT IN NO CASE MORE THAN 7 DAYS WHERE CONSTRUCTION HAS TEMPORARILY CEASED.
- 14. DISTURBED PORTIONS OF THE SITE WHERE CONSTRUCTION ACTIVITY WILL CEASE FOR MORE THAN 14 DAYS SHALL BE PERMANENTLY SEEDED. THESE AREAS SHALL BE SEEDED NO LATER THAN 7 DAYS AFTER THE LAST CONSTRUCTION ACTIVITY OCCURRED IN THESE AREAS.
- 15. IF THE ACTION OF VEHICLES TRAVELING OVER THE GRAVEL CONSTRUCTION ENTRANCES IS NOT SUFFICIENT TO REMOVE THE MAJORITY OF DIRT OR MUD, THEN THE TIRES MUST BE WASHED BEFORE THE VEHICLES ENTER A PUBLIC ROAD. IF WASHING IS USED, PROVISIONS MUST BE MADE TO INTERCEPT THE WASH WATER AND TRAP THE SEDIMENT BEFORE IT IS CARRIED OFF THE SITE.
- 16. ALL MATERIALS SPILLED, DROPPED, WASHED, OR TRACKED FROM VEHICLES ONTO ROADWAYS OR INTO STORM DRAINS MUST BE REMOVED AS SOON AS POSSIBLE.
- 17. THE CONTRACTOR SHALL BE RESPONSIBLE FOR REMOVING SEDIMENT IN THE UNDERGROUND DETENTION FACILITY AND ANY SEDIMENT THAT MAY HAVE COLLECTED IN THE STORM SEWER DRAINAGE SYSTEMS. REMOVAL OF SEDIMENT SHALL BE PERFORMED BY MECHANICAL METHODS (VACUUM), HAND REMOVAL, WATER FLUSHING, OR A COMBINATION OF THESE METHODS. SEDIMENT MUST BE COLLECTED FROM THE SYSTEM WITHOUT DISCHARGING ONTO THE SITE THROUGH THE OUTFALL.
- 18. ON-SITE & OFF SITE SOIL STOCKPILE AND BORROW AREAS SHALL BE PROTECTED FROM EROSION AND SEDIMENTATION THROUGH IMPLEMENTATION OF BEST MANAGEMENT PRACTICES. STOCKPILE AND BORROW AREA LOCATIONS SHALL BE NOTED ON THE EROSION CONTROL PLAN AND PERMITTED IN ACCORDANCE WITH GENERAL PERMIT REQUIREMENTS.
- 19. SLOPES SHALL BE LEFT IN A ROUGHENED CONDITION DURING THE GRADING PHASE TO REDUCE RUNOFF VELOCITIES AND EROSION.
- 20. DUE TO GRADE CHANGES DURING THE DEVELOPMENT OF THE PROJECT, THE CONTRACTOR SHALL BE RESPONSIBLE FOR ADJUSTING THE EROSION CONTROL MEASURES (SILT FENCES, ETC.) TO PREVENT EROSION.
- 21. ALL CONSTRUCTION SHALL BE STABILIZED AT THE END OF EACH WORKING DAY, THIS INCLUDES BACK FILLING OF TRENCHES FOR UTILITY CONSTRUCTION AND PLACEMENT OF GRAVEL OR BITUMINOUS PAVING FOR ROAD CONSTRUCTION.
- 22. ALL PROPOSED STORM INLET OR GRATE STRUCTURES SHALL BE PROTECTED WITH APPROVED INLET PROTECTION MEASURES IMMEDIATELY FOLLOWING INSTALLATION.
- 23. ALL SLOPES 3:1 OR GREATER SHALL BE STABILIZED WITH JUTE MESH OR OTHER APPROVED SOIL STABILIZATION FABRIC IMMEDIATELY FOLLOWING DISTURBANCE OF THE SLOPED AREA.

#### **MAINTENANCE**

ALL MEASURES STATED ON THE EROSION AND SEDIMENT CONTROL PLAN, AND IN THE STORM WATER POLLUTION PREVENTION PLAN, SHALL BE MAINTAINED IN FULLY FUNCTIONAL CONDITION UNTIL NO LONGER REQUIRED FOR A COMPLETED PHASE OF WORK OR FINAL STABILIZATION OF THE SITE. ALL EROSION AND SEDIMENTATION CONTROL MEASURES SHALL BE CHECKED BY A QUALIFIED PERSON AT LEAST ONCE EVERY SEVEN CALENDAR DAYS AND WITHIN 24 HOURS OF THE END OF A 0.5" OR MORE RAINFALL EVENT, AND CLEANED AND REPAIRED IN ACCORDANCE WITH THE FOLLOWING:

- 1. INLET PROTECTION DEVICES AND BARRIERS SHALL BE REPAIRED OR REPLACED IF THEY SHOW SIGNS OF UNDERMINING, OR DETERIORATION.
- 2. ALL SEEDED AREAS SHALL BE CHECKED REGULARLY TO SEE THAT A GOOD STAND IS MAINTAINED. AREAS SHOULD BE FERTILIZED, WATERED AND RESEEDED AS NEEDED.
- SILT FENCES SHALL BE REPAIRED TO THEIR ORIGINAL CONDITIONS IF DAMAGED. SEDIMENT SHALL BE REMOVED FROM THE SILT FENCES WHEN IT REACHES ONE-HALF THE HEIGHT OF THE SILT FENCE.
- 4. THE CONSTRUCTION ENTRANCES SHALL BE MAINTAINED IN A CONDITION WHICH WILL PREVENT TRACKING OR FLOW OF MUD ONTO PUBLIC RIGHTS-OF-WAY. THIS MAY REQUIRE PERIODIC TOP DRESSING OF THE CONSTRUCTION ENTRANCES AS CONDITIONS DEMAND.
- 5. THE TEMPORARY PARKING AND STORAGE AREA SHALL BE KEPT IN GOOD CONDITION (SUITABLE FOR PARKING AND STORAGE). THIS MAY REQUIRE PERIODIC TOP DRESSING OF THE TEMPORARY PARKING AS CONDITIONS DEMAND.
- 6. ALL MAINTENANCE OPERATIONS SHALL BE DONE IN A TIMELY MANNER BUT IN NO CASE LATER THAN 2 CALENDAR DAYS FOLLOWING THE INSPECTION.

#### **UTILITY NOTES**

- 1. WATER LINES SHALL BE DUCTILE IRON PIPE AND SHALL CONFORM TO AWWA STANDARD C-151 LATEST REVISION, CLASS 52 MANUFACTURED BY US PIPE, GRIFFIN PIPE CO., ATLANTIC STATES PIPE OR APPROVED EQUAL.
- 2. ALL FITTINGS SHALL CONFORM TO AWWA STANDARD C-153 LATEST REVISION, MADE OF DUCTILE IRON, COMPACT, MECHANICAL JOINT, DOUBLE CEMENT LINED, AND BITUMEN COATED MANUFACTURED BY AMERICAN CAST IRON PIPE, SIGMA, OR APPROVED EQUAL.
- 3. RETAINER GLANDS SHALL BE MEG-A-LUG TYPE AS MANUFACTURED BY EBBA IRON SERIES 2100, OR APPROVED EQUAL.
- 4. ALL GATE VALVES SHALL MEET AWWA STANDARD C509 LATEST REVISION, BE MECHANICAL JOINT, HAVE O-RING STEM SEALS AND HAVE AN EPOXY COATED BODY. ALL GATES MUST OPEN RIGHT. ALL GATES FROM 4" THROUGH 16" WILL BE DESIGNED VERITCAL INSTALLATION.
- 5. BUTTERFLY VALVES ARE NOT ALLOWED WITHIN THE CITY'S WATER DISTRIBUTION SYSTEM.
- 6. SERVICE SADDLES SHALL BE DUCTILE IRON WITH 12 MILL EXPOXY COATING WITH 2 STAINLESS STEEL STRAPS.
- 7. TAPPING SLEEVES SHALL BE MADE OF DUCTILE IRON CONSTRUCTED TO ASTM A536 STANDARDS MECHANICAL JOINT RATED 250 PSI. ALL SLEEVES MUST HAVE A TEST PORT FOR AIR TESTING. TAPPING SLEEVES SHALL BE MANUFACTURED BY AMERICAN FLOW CONTROL SERIES 2800, MUELLER H-615 OR APPROVED EQUAL.
- 8. TAPPING VALVES SHALL CONFORM TO AWWA/ANSI C515, NSF61 APPROVED FOR POTABLE WATER. ALL VALVES WILL BE OPEN RIGHT, EPOXY COATED, WITH RESILIENT WEDGE. TAPPING VALVES MUST BE SUPPLIED BY THE SAME MANUFACTURER AS THE TAPPING SLEEVE TO BE USED.
- 9. FIRE HYDRANTS SHALL CONFORM TO AWWA C502, FM 1510, AND UL 246 LISTED. THE HYDRANT MAINE VALVE WILL BE 5-1/4", OPEN LEFT.

5. APPROVAL OF DRAINAGE PLAN AND MAINTENANCE AGREEMENT BY TOWN ENGINEER

## PERMITS / APPROVALS REQUIRED

- 1. RIPDES PERMIT
- 2. APPROVAL FROM CENTRAL COVENTRY FIRE DISTRICT
- 3. TOWN OF COVENTRY MAJOR LAND DEVELOPMENT FINAL PLAN APPROVAL
- 4. PARKING AND LOADING VARIANCE FROM THE TOWN OF COVENTRY
- 6. APPROVAL OF EROSION CONTROL PLAN BY TOWN ENGINEER
- 7. APPROVAL BY KENT WATER

© 2024 KIMLEY-HORN AND ASSOCIATES, II 271 WAVERLEY OAKS RD, SUITE 302, WALTHAM, PHONE: 781-328-0676



DATE
7/1/2024
SCALE AS SHOWN
DESIGNED BY CGA
DRAWN BY CGA

ENERAL NOTES

NOOSENE 1920 I

C-1.1

Z



- The bearings for this survey are based upon the North American Datum of 1983, Rhode Island 2011 State Plane
- Coordinate System.
- This property has an area of 178,031 square feet or 4.086 acres of land (survey).
- This property is designated by Newport County, as Tax Map Parcel 57-4.
- There was no observable evidence of cemeteries found at the time of this survey. In response to Table A Items 16 and 17 there was no observable evidence of earth moving work, building construction or additions and no known proposed changes in right of way lines, recent street or sidewalk construction or repairs.
- The property has direct access via Nooseneck Hill Road, which is a public right of way. Interior roadways appear to be private, variable in width and unnamed, unless otherwise shown.
- The features depicted hereon are the result of a field survey. The field work was concluded on February 1, 2022.
- This survey has been produced with the benefit of a title commitment provided by First American Title Insurance Company. Commitment number: 3020-1105994, with an effective date if September 6, 2022.
- 0. No evidence of any offsite easements or servitudes which benefit the surveyed property were disclosed in the record
- documents provided to the surveyor. 11. as designated by the client, there are no party wall/walls on the subject property.

# SCHEDULE B - TITLE EXCEPTION NOTES

Being the same tract of land described in a Title Report prepared by First American Title Insurance Company, Commitment No. 3020-1105994, dated September 6, 2022.

8. Boundary Agreement by and between Daniel A Vaccaro, Peter P. Borghesani, Marcia Borghesani as Grantor and Mapleroot Realty as Grantee, dated April 4, 2022 and recorded in Book 2251, Page 527

## SIGNIFICANT DBSERVATIONS

No encroachments were observed while conducting the field survey.

## ZONING NOTES

The subject parcel lies entirely within a General Business District (GB-1) district with the following regulations based upon the zoning report provided by: Global Zoning; Global Zoning Job Number: GZ 16763; Dated: February 25, 2022.

Zoned: General Business District (GB-1)

Permitted Use Classification: Self-Storage Facility. variance for use approved August 22, 1994.

Observed Use(s): Self-Storage Facility

Zoning Regulations are subject to change and interpretation, for further information contact: Town of Coventry, Contact's Name: John Studley, Associate Planner, Phone: 401.822.6230

#### Site Restrictions:

- 1. Minimum building setbacks: 2. Measured building tie distances: Front: 10 feet North: 29.4 feet Side: 10 feet East: 107.1 feet
- South: 22.2 feet Rear: 40 feet West: 239.1 feet
- 3. Minimum lot size: 43,560 S.F. (min. provided: 186,832 S.F. (min. provided: 329.77± feet )
- 4. Minimum lot frontage: 200 feet 5. Maximum building height: 35 feet (max. provided: 10 feet)
- 6. Maximum lot coverage: 60% (max. provided: 43.4% coverage)

### MAP REFERENCES

- A. "PLAN OF LAND IN COVENTRY, R.I. SURVEYED FOR RURAL REALTY" SCALE: 1"=100'; BY: RAY.C. MATTESON, DECEMBER 1956.
- B. "STATE OF RHODE ISLAND HIGHWAY PLAT NUMBER 563.

#### Parking Tabulation:

Total regular spaces provided: Total handicap spaces provided: 0 Total combined spaces provided: 0

#### FLOOD ZONE NOTE


Surveying Associates, LLC

By graphic plotting only, this property is in Zone X of the Flood Insurance Rate Map, Community Panel No. 44003C0111H, which bears an effective date of October 2, 2015 IS NOT in a Special Flood Hazard Area. By telephone call to the National Flood Insurance Program (800-638-6620) we have learned this community DOES currently participate in the program. No field surveying was performed to determine this zone and an elevation certificate may be needed to verify this determination or apply for a variance from the Federal Emergency Management Agency.

#### Survey Prepared By:

www.martinsurvey.com

Martin Surveying Associates, LLC. 201 Christian Lane, Suite D Berlin, CT 06037 martin Phone: 860.832.9328

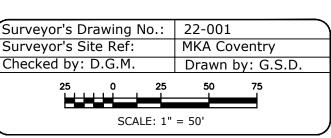

#### LEGEND OF SYMBOLS & ABBREVIATIONS LEGEND: —— — BOUNDARY LINE O IRON PIN (FOUND) GUARD RAIL POST Rebar/Drill Hole (To Be Set) UNDERGROUND \_ \_ \_ \_ PIPING (San., Stm.) ✓ GUY ANCHOR ☐ MONUMENT (FOUND) ——— G ——— U/G GAS LINE ♦ UTILITY POLE MANHOLE U/G ELEC. LINE ① DRAINAGE MANHOLE WG WATER GATE WM WATER METER ——— W——— U/G WATER LINE (S) SANITARY MANHOLE GV GAS VALVE © ELEC. MANHOLE OVERHEAD UTILITIES ① TELE. MANHOLE © GAS METER T U/G TELE. LINE "C" CATCH BASIN \* \* \* CHAIN LINK FENCE TRANSFORMER ☐ "C-L" CATCH BASIN TREE LINE S ELEC. METER ξ.) DECIDUOUS TREES MAIL BOX ----- OHP ----- OVERHEAD WIRES ☆ EVERGREEN TREES ☐ HAND HOLE (D) = DEED**₩** SHRUB/BUSH (S) = SURVEYD BUTTON BOX ↑ FLAG POLE A.C. UNIT CBX TRAFFIC CONTROL BOX ← TRAFFIC LIGHT POB POINT OF BEGINNING

(DRY WELL)

SUMP=249.06'

× 254.2

SUMP=249.01

WOOD₽D ÀREA

SHORESIDE REALTY LLC BOOK: 2227 PAGE: 487

AP: 18-085.0

BUILDING —

m HEIGHT ≥ 10'±

×257.2'\_\_

BUILDING - กู้ HEIGHT= 10

FIELD LOCATED X 254.3

FIELD LOCATED SAN. PAINT

604.66' (D)&(S)

1 STORY METAL STORAGE BUILDING

1 STORY METAL STORAGE BUILDING

1 STORY METAL STORAGE BUILDING 5,020 S.F. ±

BITUMINOUS

1 STORY METAL STORAGE BUILDING

1 STORY METAL STORAGE BUILDING

682.05' (D)&(S)

MAPLEROOT REALTY, LLC

BOOK: 1980 PAGE: 585 AP: 18-032.0

8 PROPERTY LINE AGREEMENT

AS DESCRIBED IN BOOK 2251 PAGE 527

DESCRIBED IN BOOK 2251 PAGE 525.

PARCEL CONVEYED TO MAPLEROOT REALTY, LLC AS

178031 Sq. Feet

× 254.4.0870 Acres<sub>× 254.4</sub>

× 254.6°


TREE LINE

(DRY WELL) + × 254.6' TF=254.10'

(DRY WELL) TF=253.83'

SUMP=257.83'

(DRY WELL) TF=253.70' SUMP=249.90'

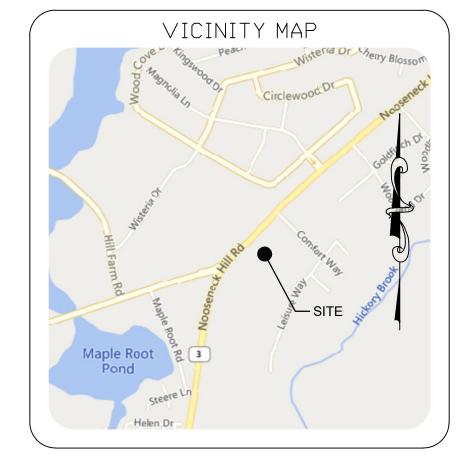

SITE LOCATION MAP (NOT TO SCALE)

255.3'

95°2<u>0'08" (D)&(S)</u>

10' SIDE SETBACK\_

SUBJECT PARCEL

178,031 ± S.F.

4.086 ± ACRES

BK. 2251 PG. 535

REBAR FOUND N22°52'42"W 1.36'

FROM CORNER

BOOK: 2145 PAGE: 584

 $_{(D)}^{\circ}$   $\stackrel{(6'00'')}{\bullet}$  REBAR TO BE SET (TYP.)

N/F

LOUIS PALMISCIANO

# SURVEYOR DESCRIPTION

#### SURVEYOR DESCRIPTION:

BEGINNING AT A POINT IN THE SOUTHERLY STREET LINE OF NOOSENECK HILL ROAD AT THE DIVISION LINE OF LAND NOW OR FORMERLY OF SHORESIDE REALTY LLC.

THENCE RUNNING ALONG SAID LAND OF SHORESIDE REALTY LLC 604.66 FEET TO A POINT AT THE DIVISION LINE OF LAND NOW OR FORMERLY OF LOUIS PALMISCIANO;

THENCE TURNING AN INTERIOR ANGLE OF 95º20'08" AND RUNNING A DISTANCE OF 79.27 FEET TO A POINT;

THENCE TURNING AN INTERIOR ANGLE OF 195º16'00" AND RUNNING A DISTANCE OF 187.69 FEET TO LAND NOW OR FORMERLY OF MAPLEROOT REALTY, LLC, THE LAST TWO COURSE BEING BOUNDED SOUTHEASTERLY BY SAID LAND OF LOUIS PALMISCIANO:

THENCE TURNING AN INTERIOR ANGLE OF 75º32'53" AND RUNNING A DISTANCE OF 679.91 FEET ALONG SAID LAND OF MAPLEROOT REALTY, LLC TO A REBAR IN THE SOUTHERLY STREET LINE OF NOOSENECK HILL ROAD, SAID POINT BEING NORTHEASTERLY 12.95 FEET FROM THE POINT OF CURVATURE HAVING A STATION OF 224+50.06 ON STATE HIGHWAY

THENCE TURNING AN ANGLE OF 85°50'18" AND RUNNING ALONG THE SAID SOUTHERLY STREET LINE OF NOOSENECK HILL ROAD A DISTANCE OF 303.82 FEET TO THE POINT OR PLACE OF BEGINNING, SAID FIRST AND LAST COURSE FORMING AN INTERIOR ANGLE OF 90º00'41".

SAID PARCEL CONTAINS 178,031 S.F. +/-, 4.086 ACRES +/-.

THE SURVEYOR'S LEGAL DESCRIPTION AS SHOWN HEREON, IS THE SAME PROPERTY DESCRIBED AS IN THE FIRST AMERICAN TITLE INSURANCE COMPANY COMMITMENT NUMBER 3020-1105994. DATED SEPTEMBER 6. 2022.

## ALTA/NSPS LAND TITLE SURVEY

Coventry Mini Storage 1920 Nooseneck Hill Road Coventry, Rhode Island 02816

Surveyor's Certification

To: Macritchie Storage Ventures LLC; First American Title Insurance Company; Nooseneck Hill Coventry, LLC; Harter Secrest & Emery LLP; and MKAssociates, Inc.

This is to certify that this map or plat and the survey on which it is based were made in accordance with the 2021 Minimum Standard Detail Requirements for ALTA/NSPS Land Title Surveys, jointly established and adopted by ALTA and NSPS and includes Items 1-5, 6(a), 6(b), 7(a), 7(b), 7(c) 8, 9, 10, 11B, 13, 14, 16, 17, 19 of Table A thereof.

The field work was completed on February 11, 2022.


Date of Plat or Map: February 15, 2022.

REV. #1 - Add Table Item 5. September 29, 2022.



Surveyor's Signature

Registered Surveyor: Dean Martin Registration Number: 1983 In the State of: Rhode Island

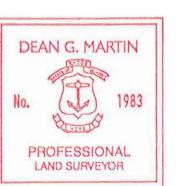

PROJECT NAME: Coventry Mini Storage ADDRESS: 1920 Nooseneck Hill Road

MKA PROJECT No.: 6061-22-8275R

For Inquiries Concerning This Survey Contact MKA

CITY: Coventry

National Coordinators of Land Survey Services 6593 Commerce Court - Warrenton, Virginia

Phone: (540) 428-3550 Email: comments@mkassociates.com www.mkassociates.com

SHEET I OF

STATE: Rhode Isla

UTILITY INFORMATION

No utility records or utility service provider contact information has been provided to the surveyor for the production of this survey.

NET&T CO

NET&T CO

CP-1 (MAG NAIL) N:214061.71 E:300942.00 Z:256.81

LEANING

NET&T CO

NET&T CO

© TF=257.21

257.4℃

PC STA 224+50.06

FOUND


\_\_83°48'22" CHORD


L=13.00'(D)&(S)

WATER MH-

TF=255.42


POINT OF BEGINNING

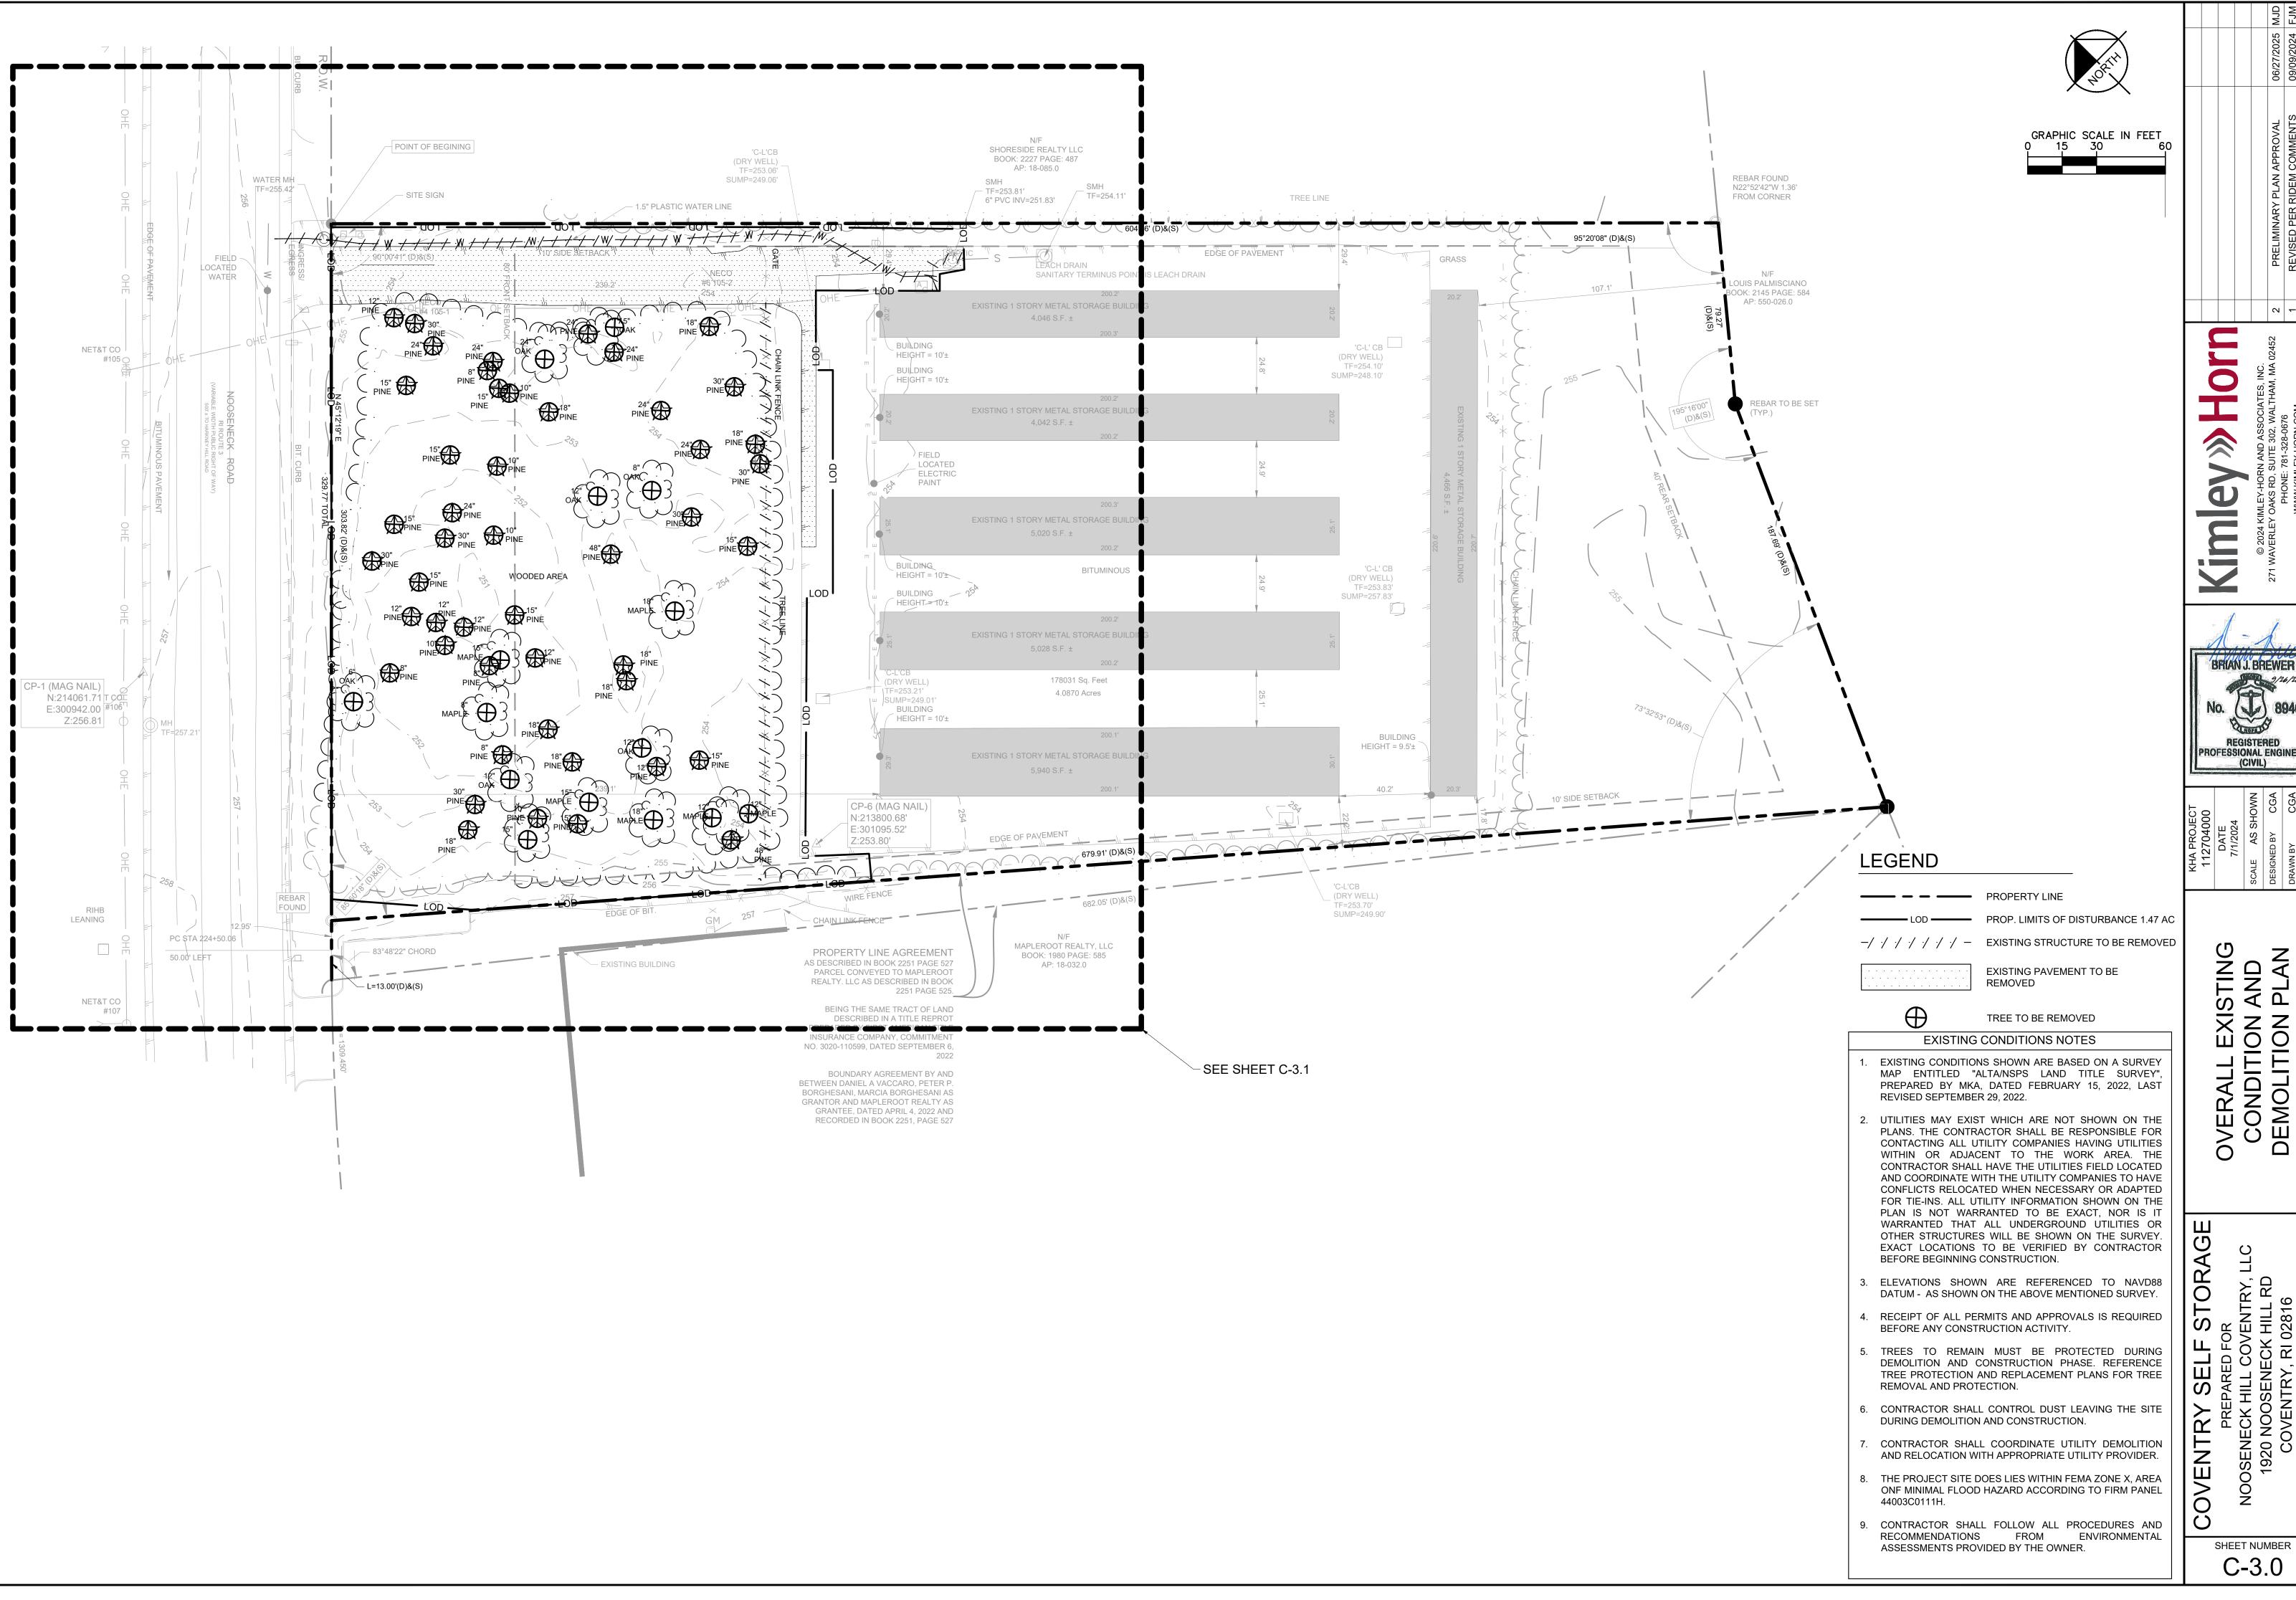


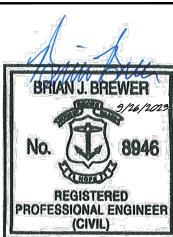



STING AND PLAN ERALL EXIS

SHEET NUMBER C-3.0

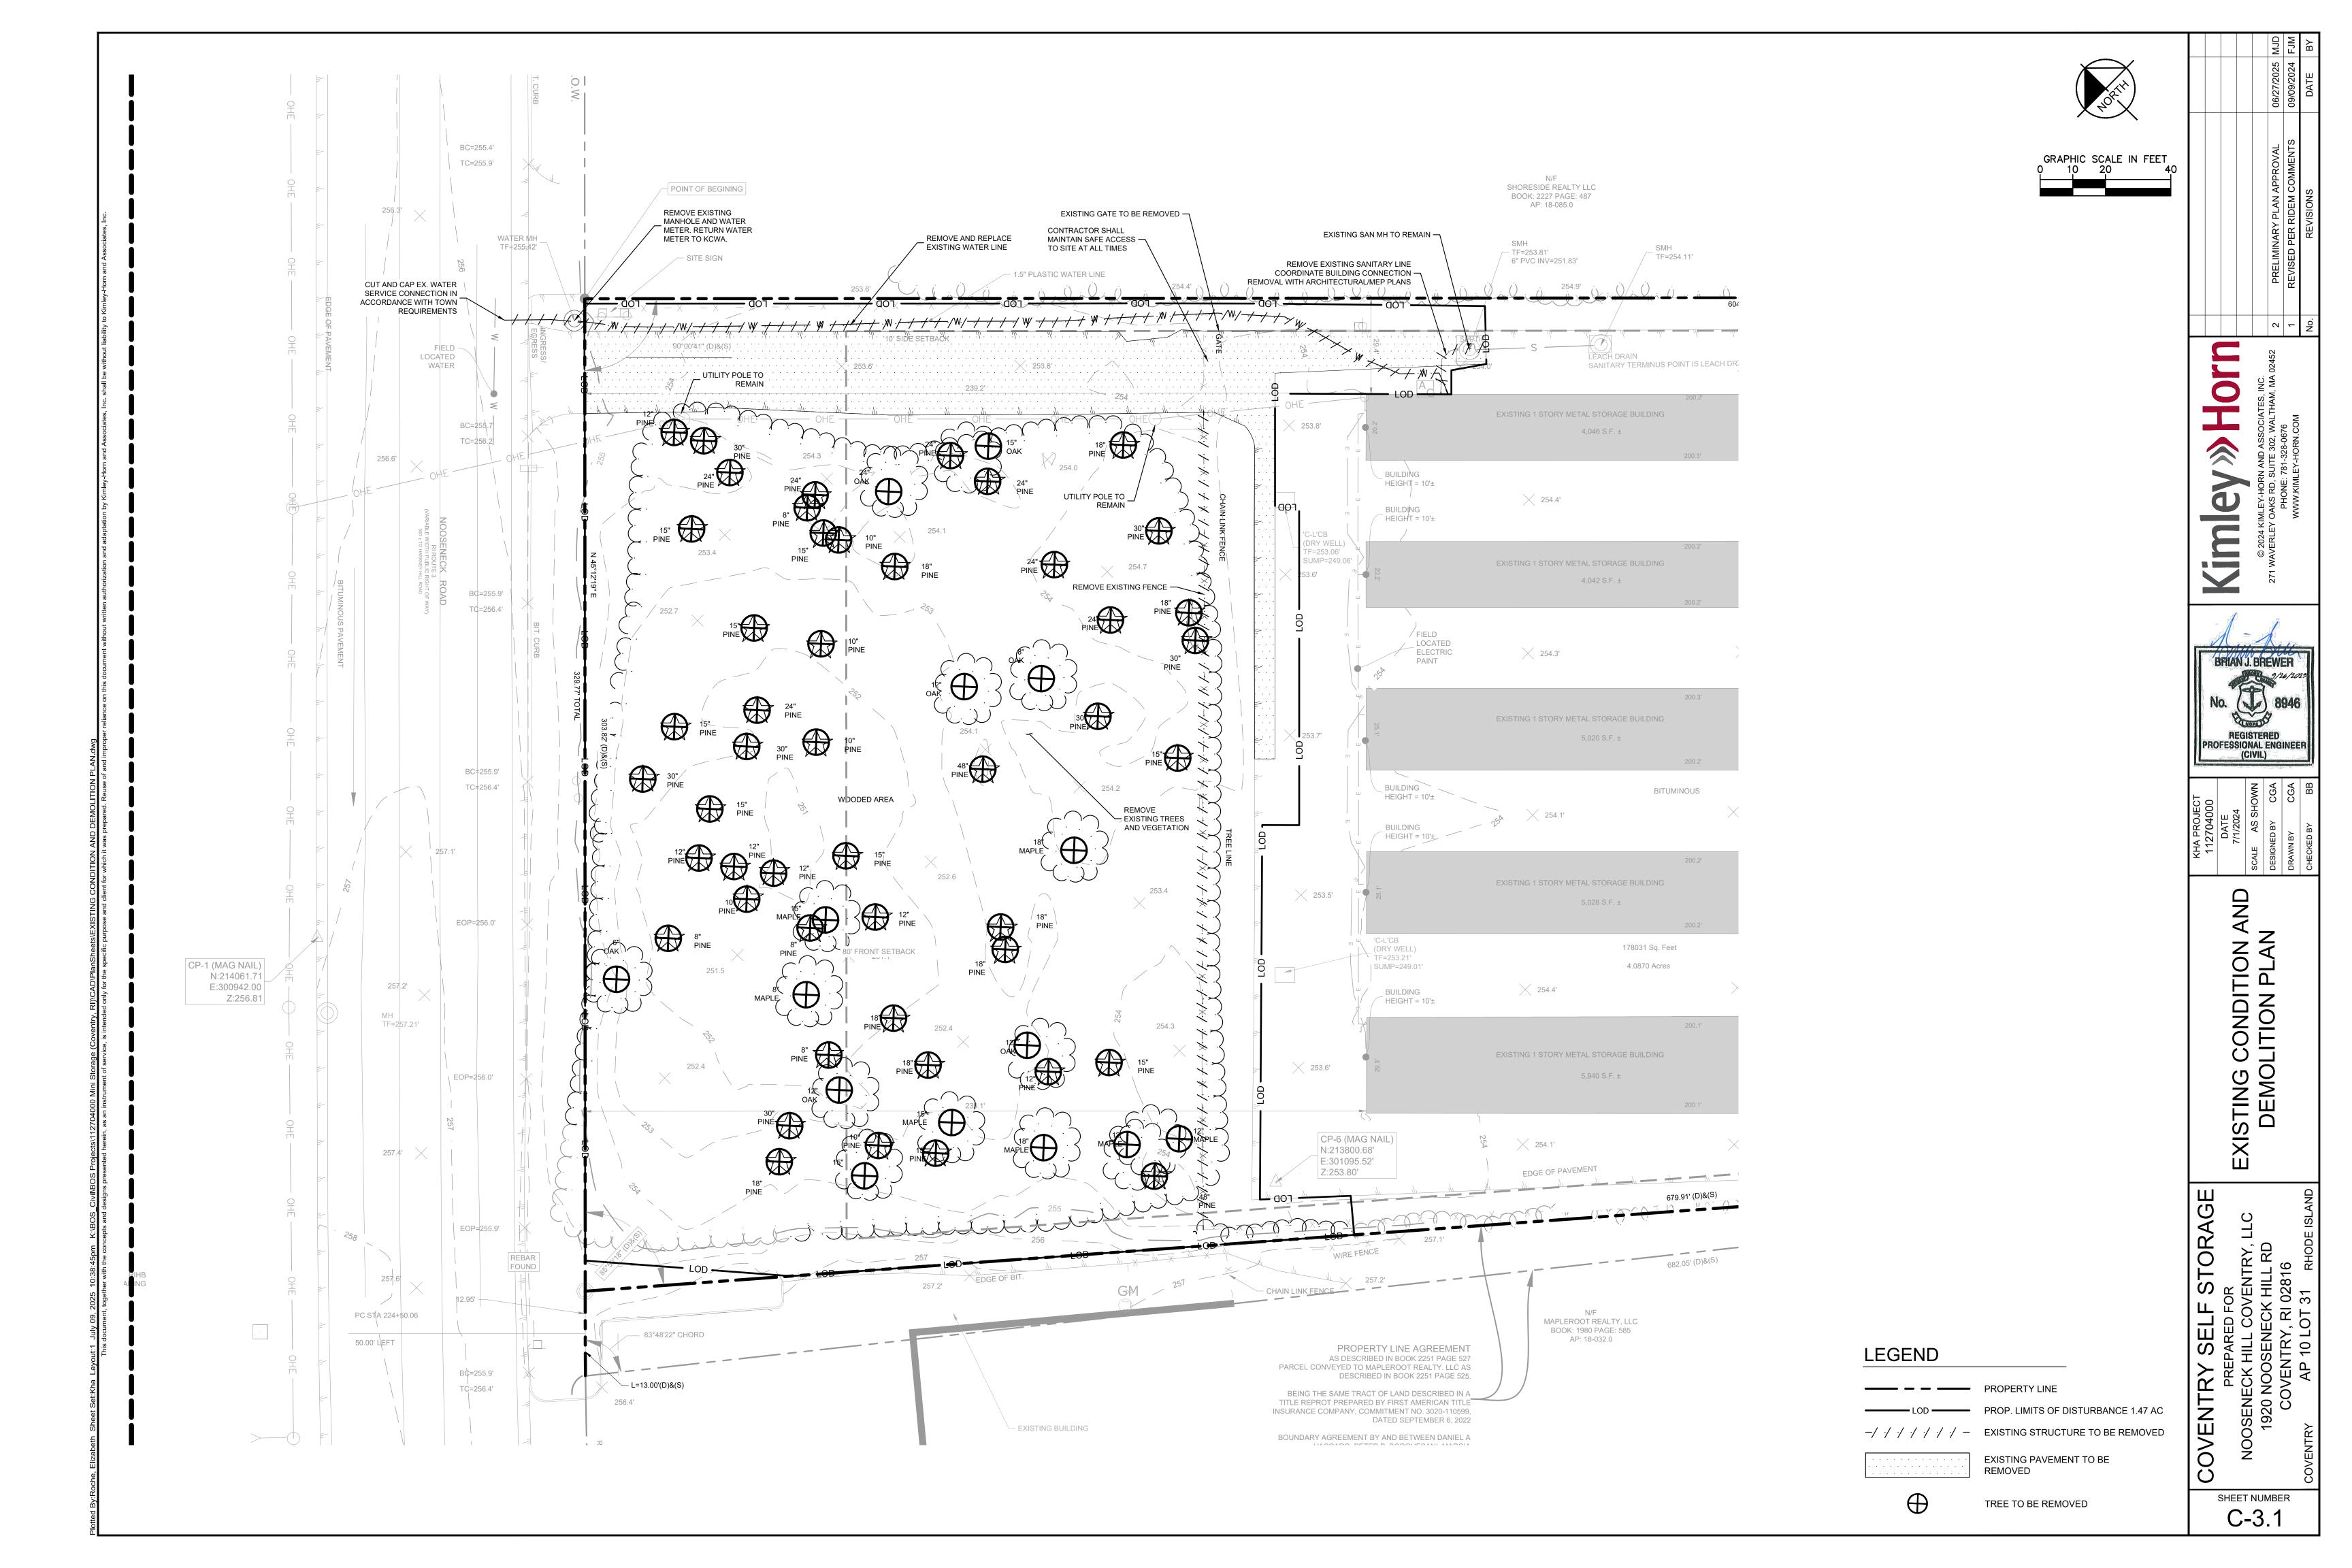

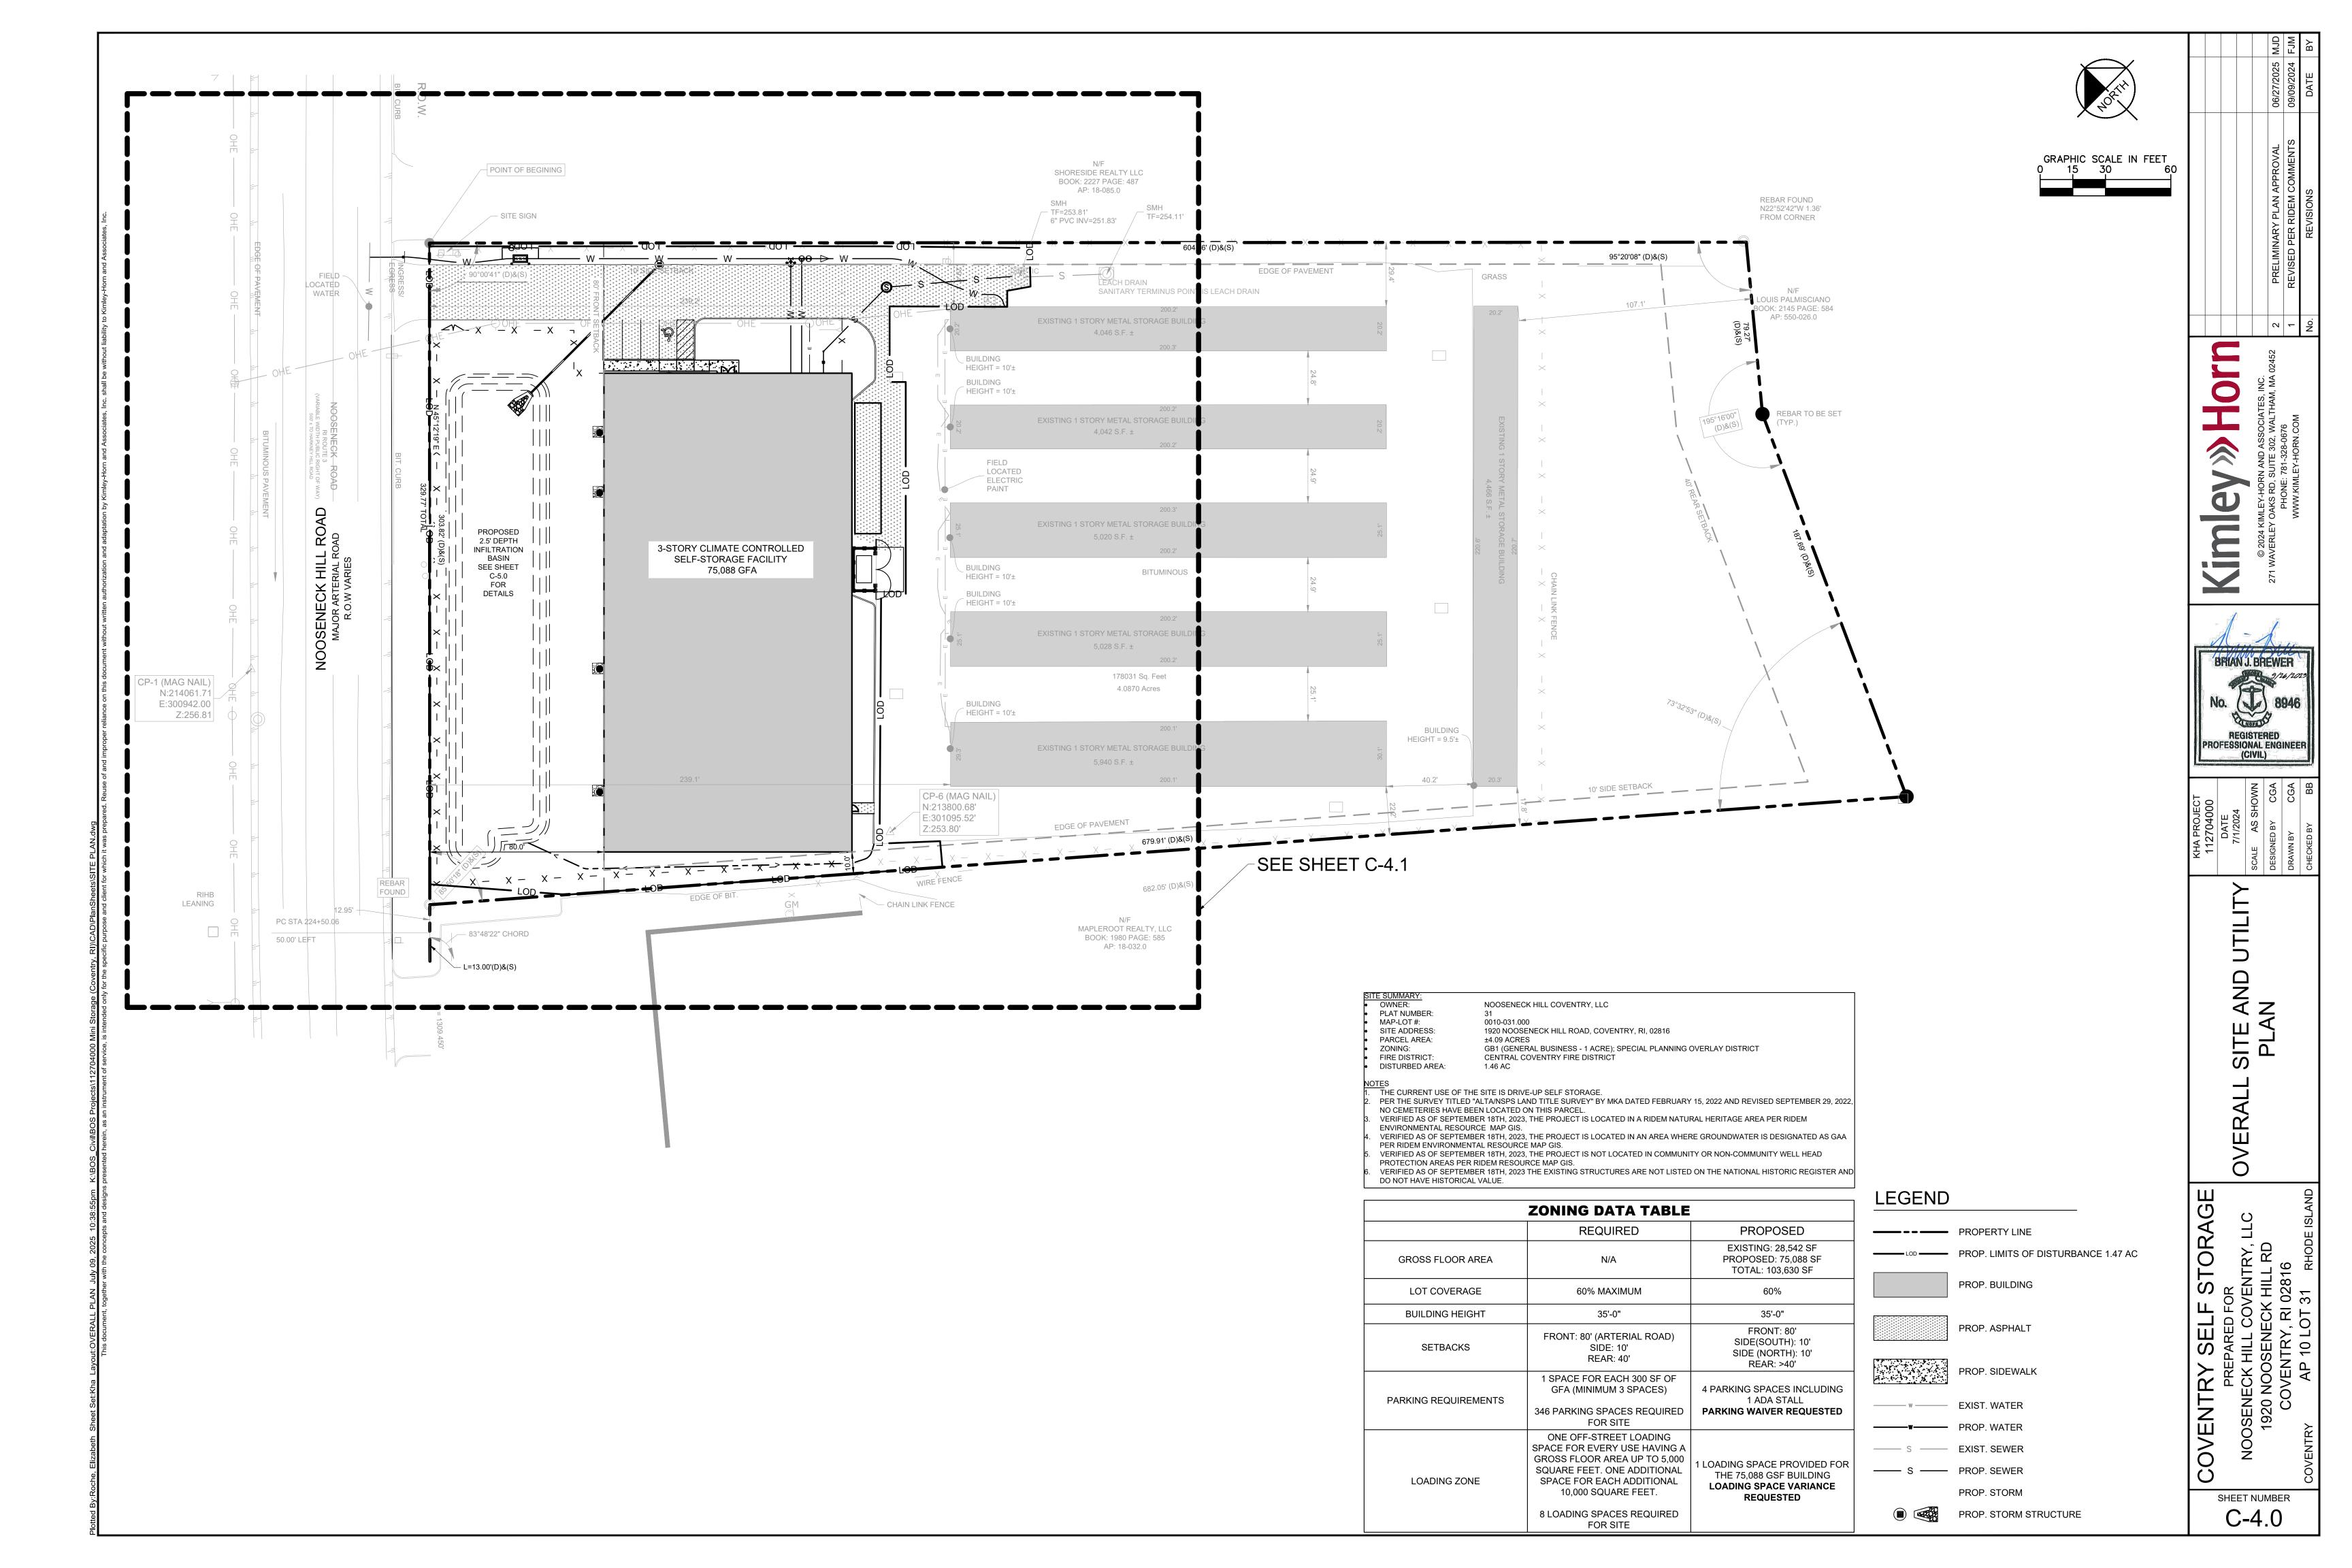

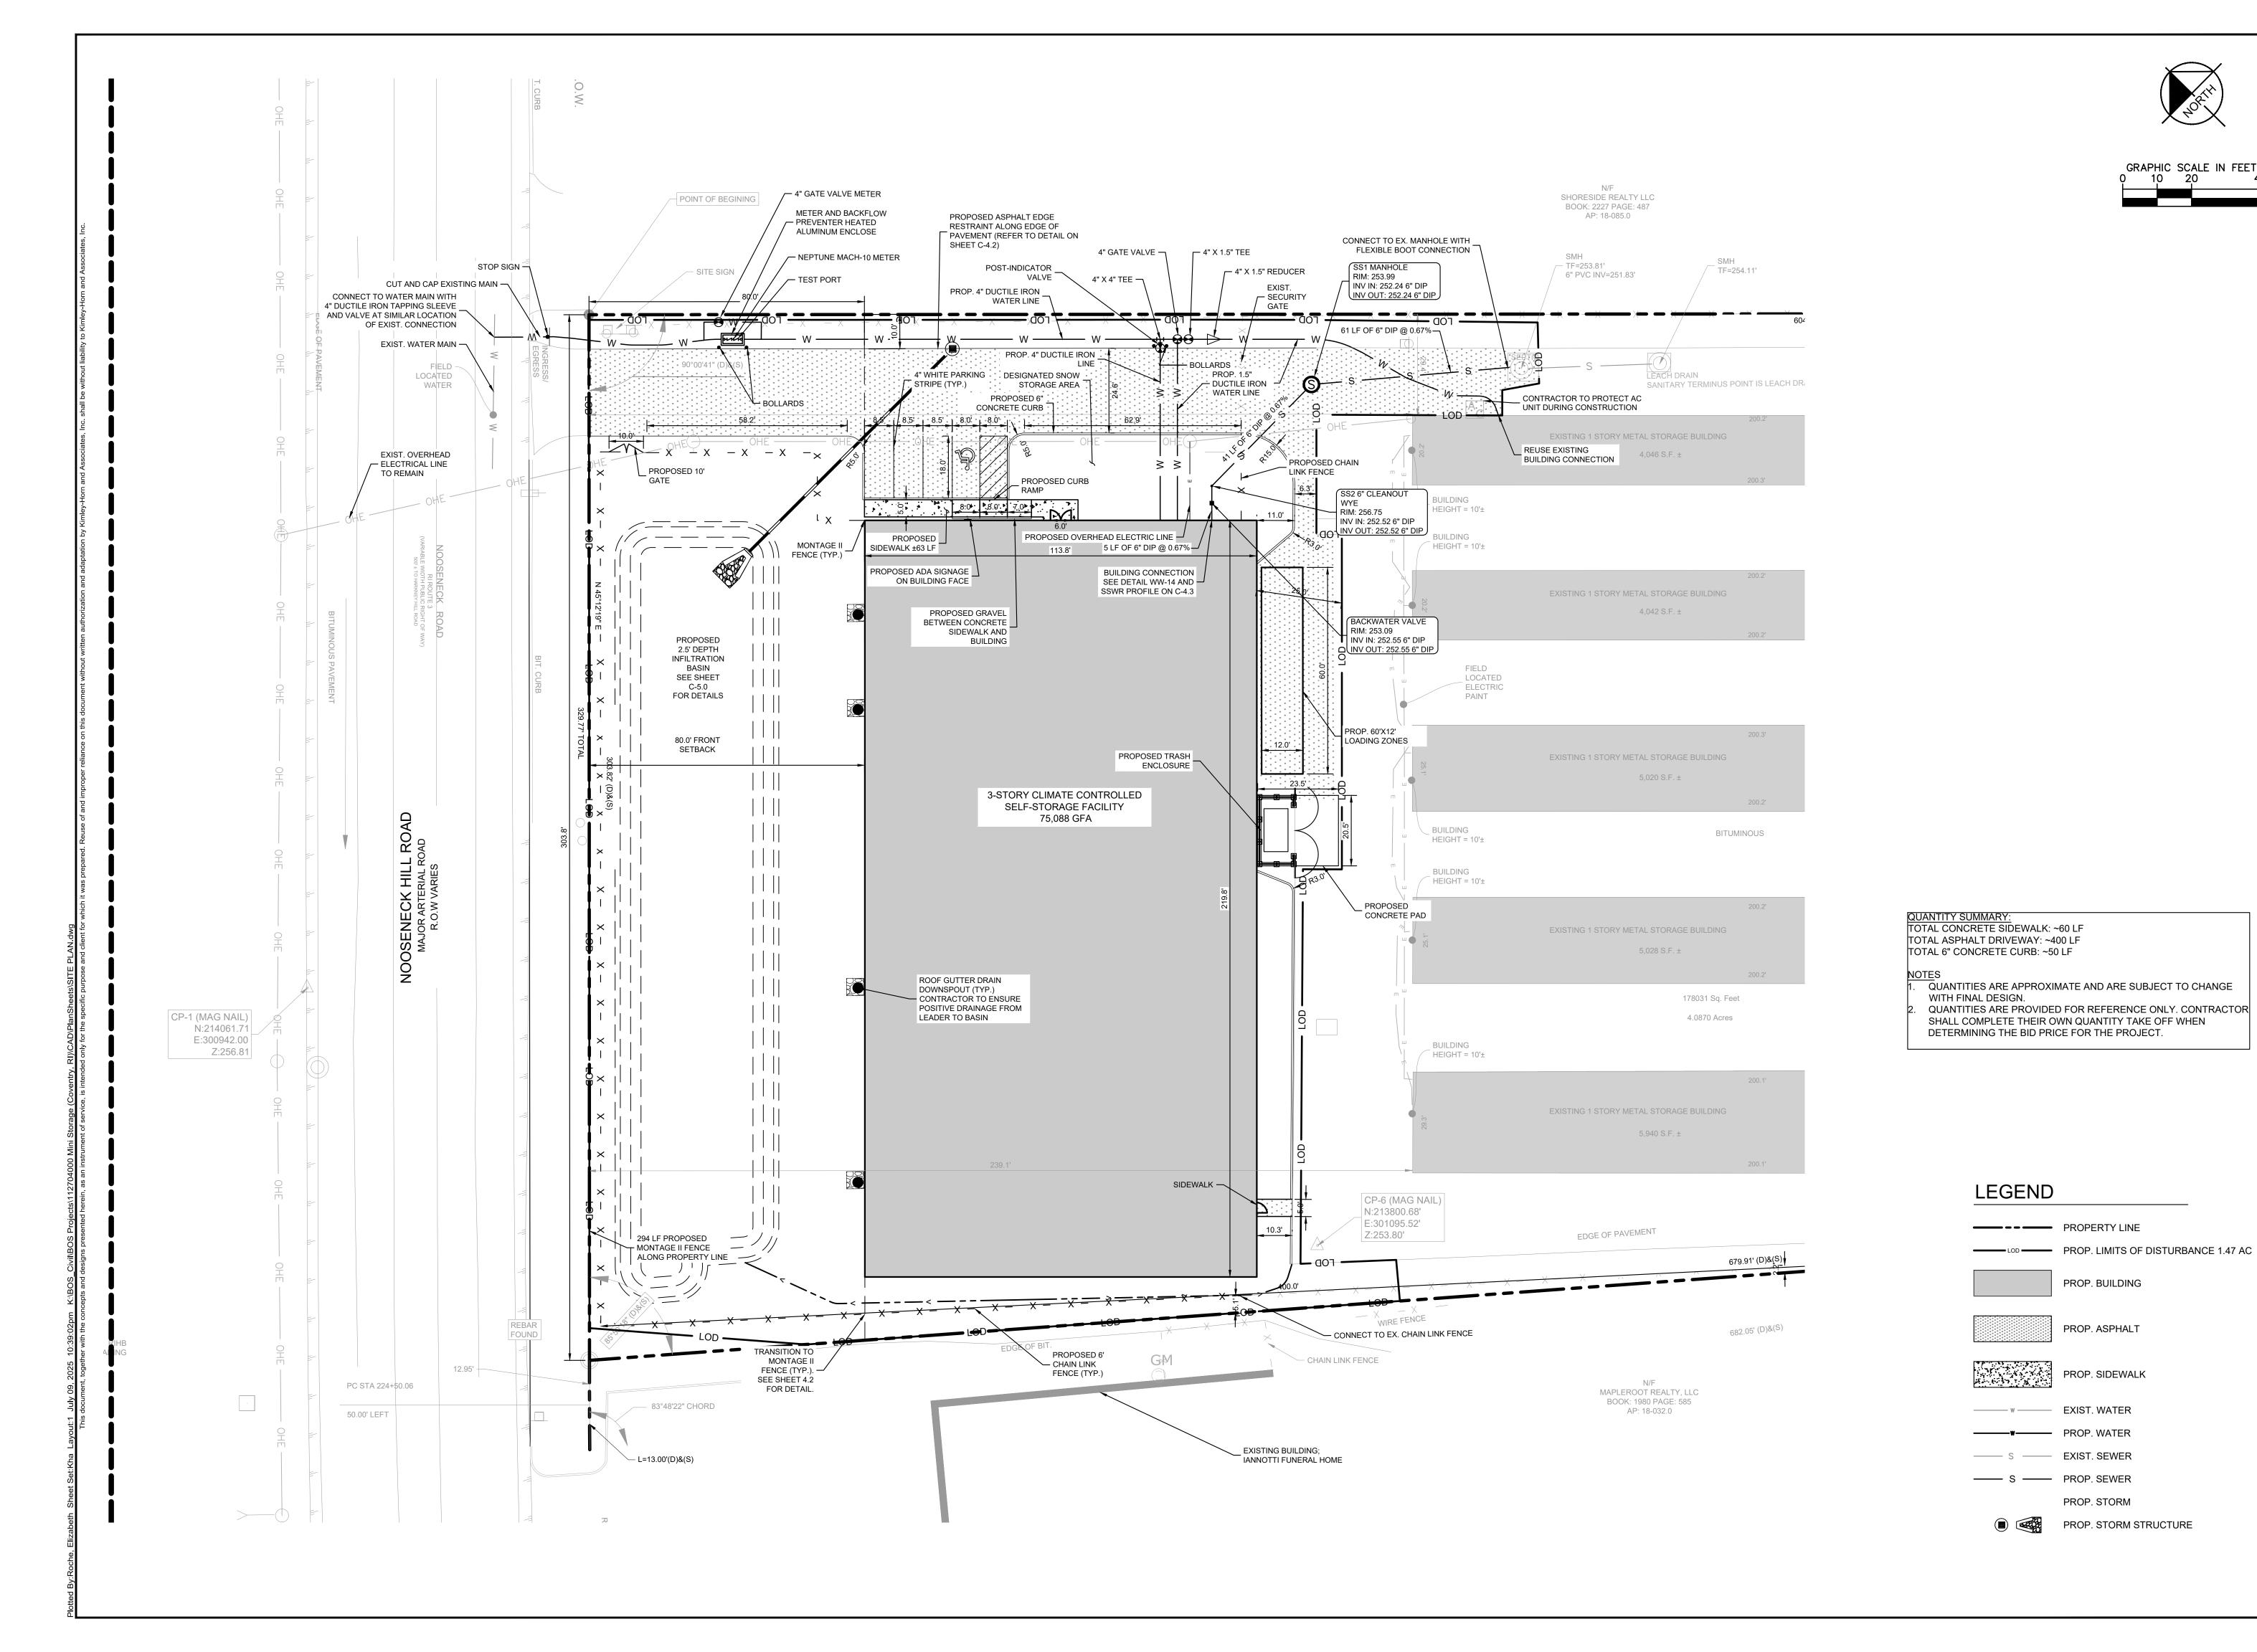

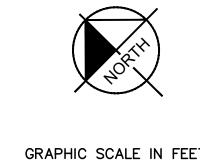

GRAPHIC SCALE IN FEET 0 10 20 4

REGISTERED PROFESSIONAL ENGINEER (CIVIL)

SITE

PROP. BUILDING


PROP. ASPHALT

PROP. SIDEWALK

PROP. STORM

PRE OSENECK I 1920 NOO: COVEN VENTR

SHEET NUMBER C-4.1

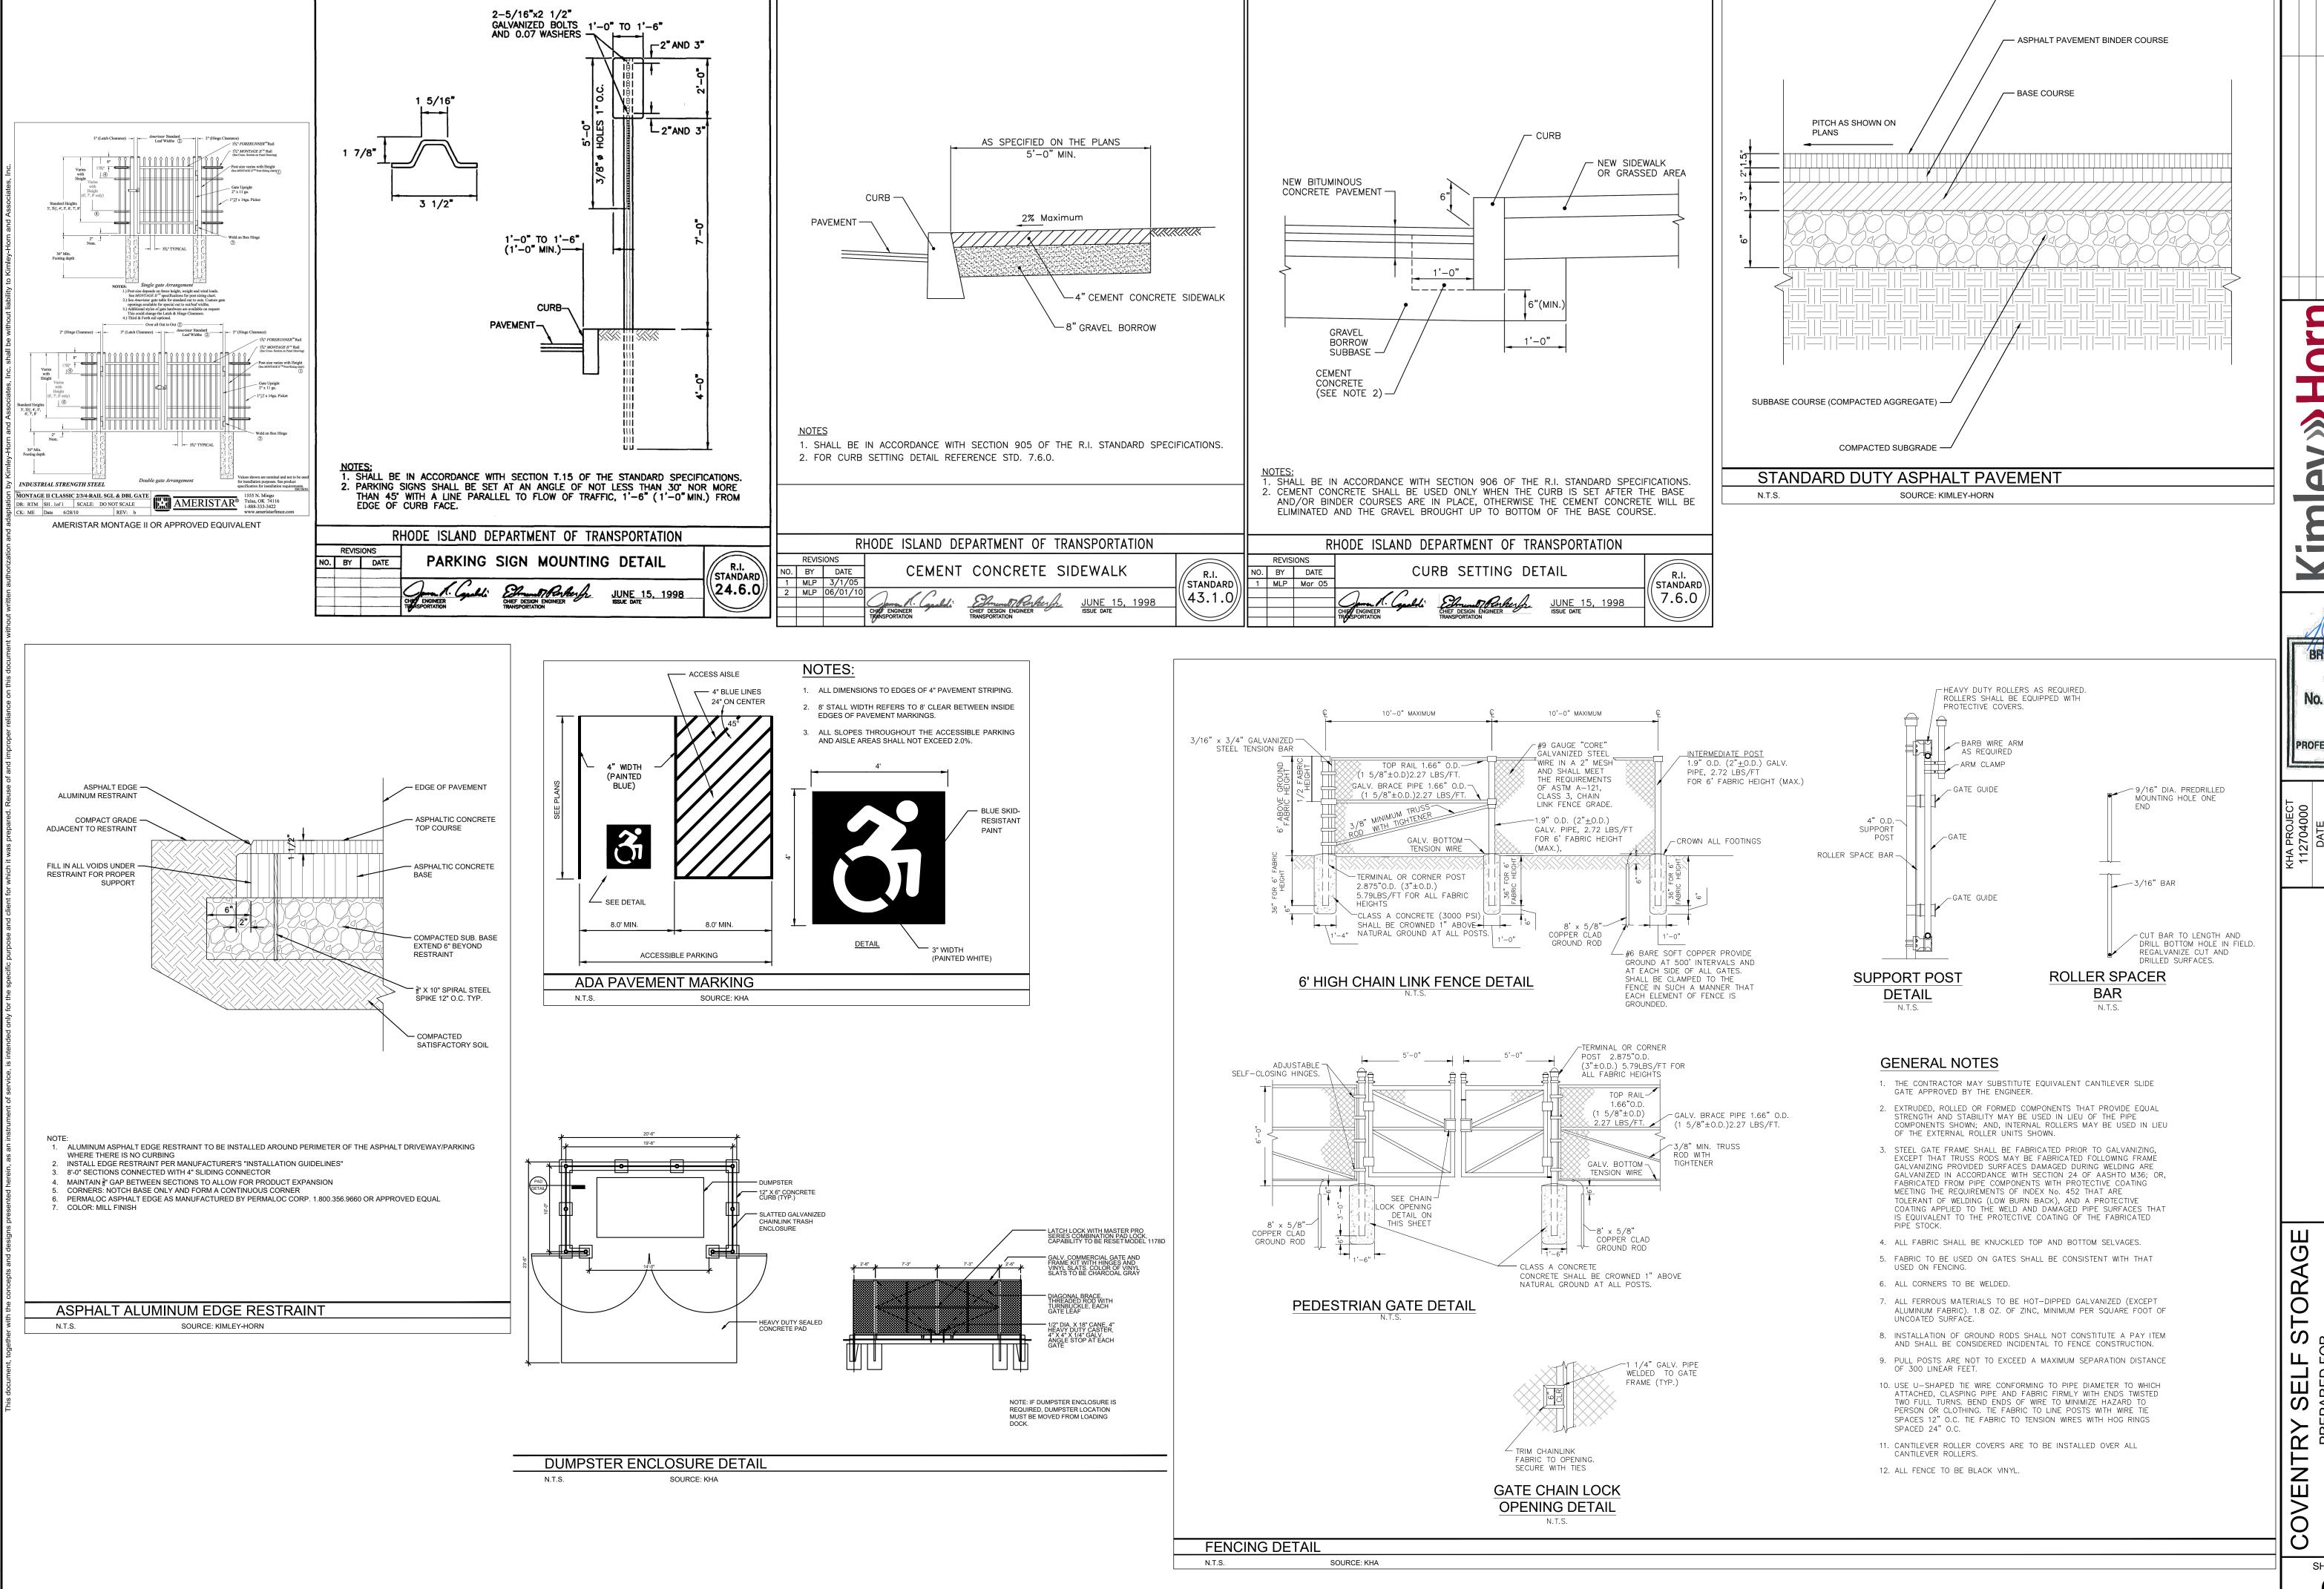


ASPHALT PAVEMENT SURFACE COURSE


REGISTERED PROFESSIONAL ENGINEER (CIVIL)


SIT


VENTRY, I K HILL RD 02816 31 PLOTE 1920 C(


SHEET NUMBER

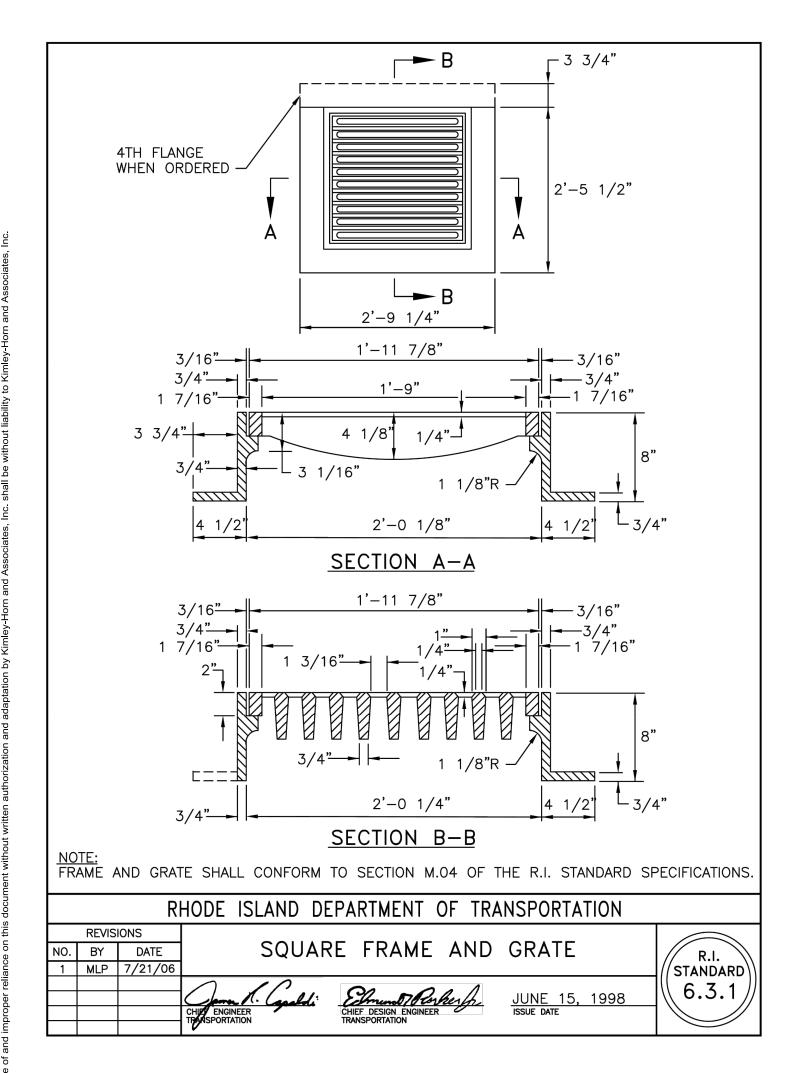

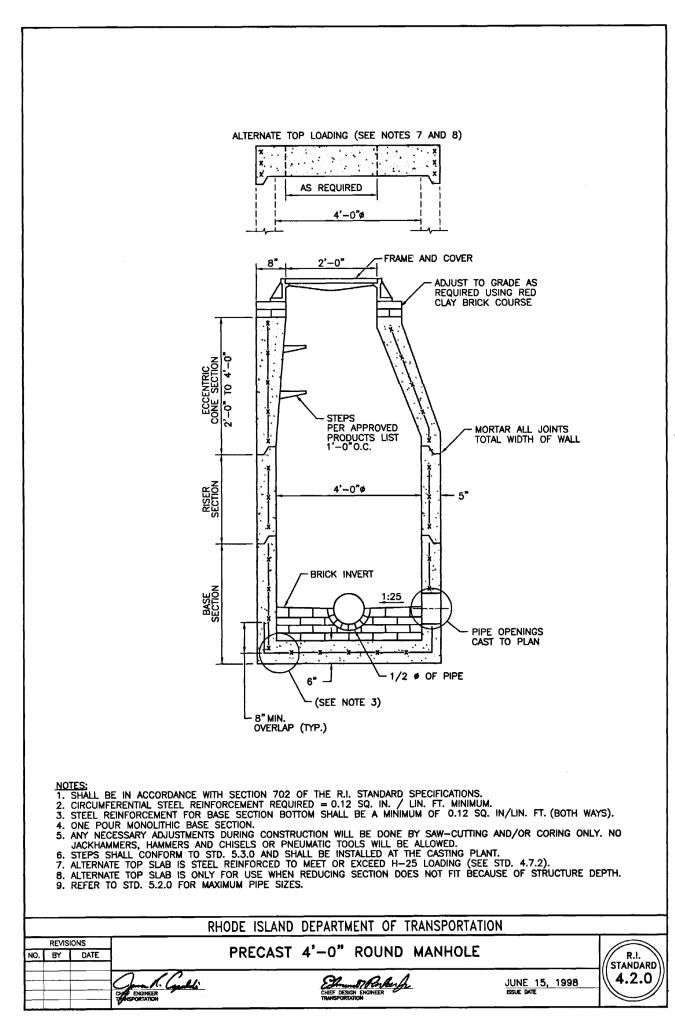

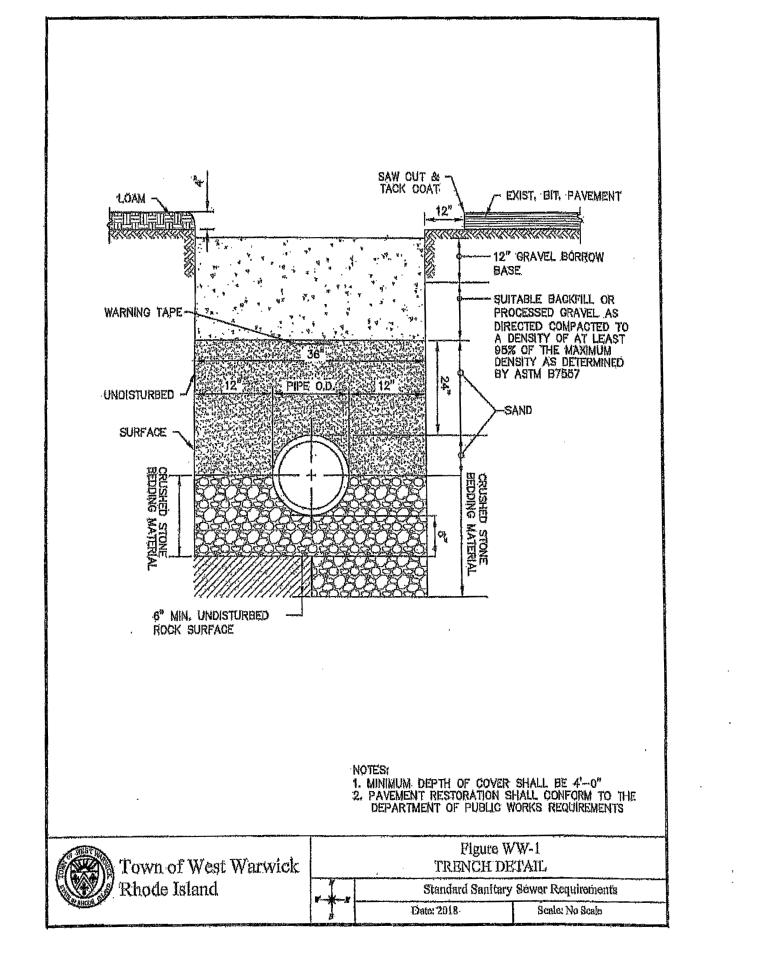


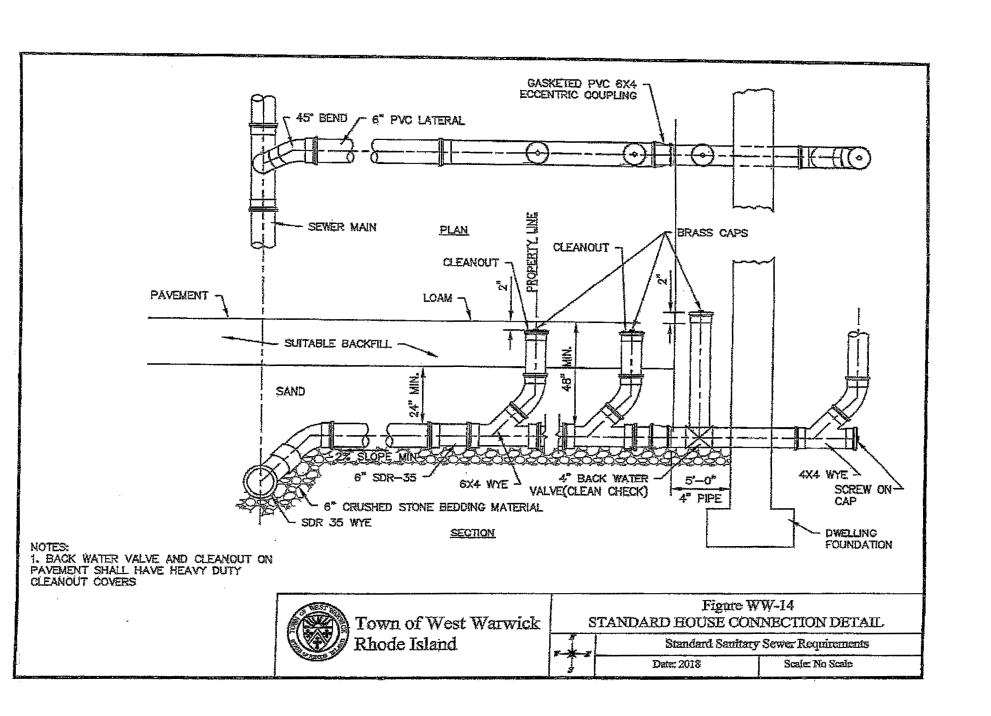

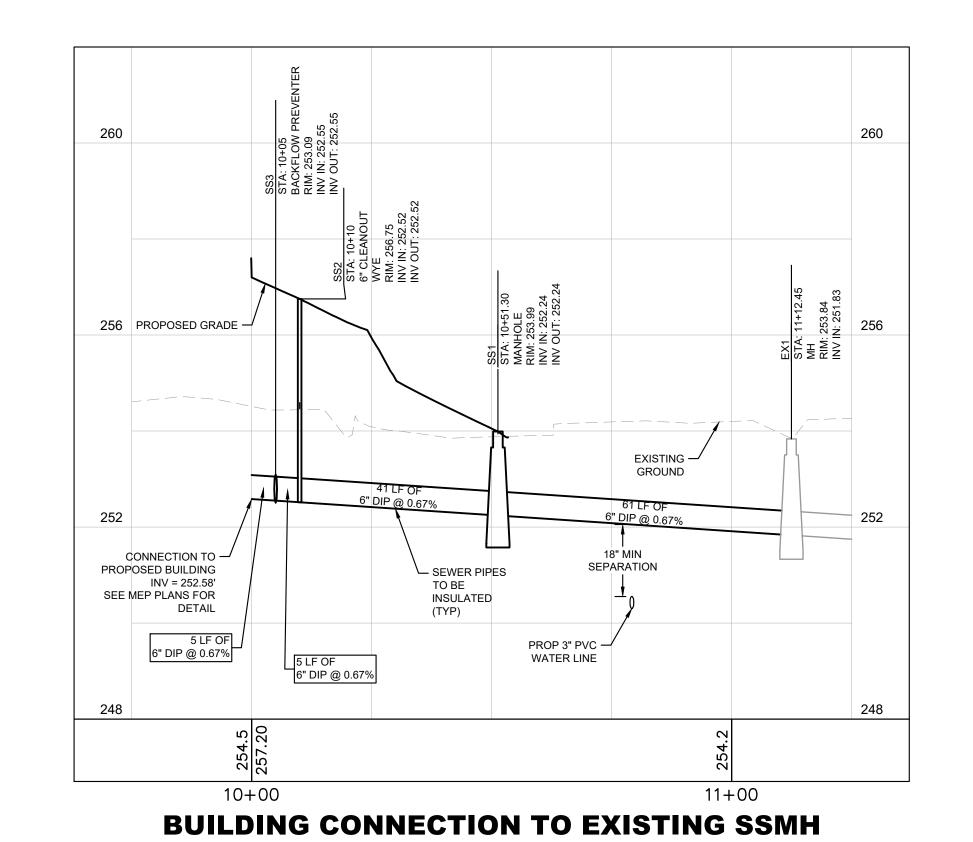

SCALE: 1" = 20' H

1" = 2' V

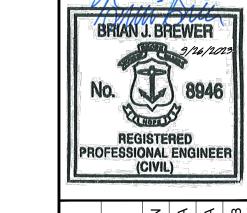


DETAILS PROFILE


STORAGE NOOSENECK HILL COVENTRY, LI
1920 NOOSENECK HILL RD
COVENTRY, RI 02816


OVENTRY AP 10 LOT 31 RHODE VENTRY


SHEET NUMBER


C-4.3

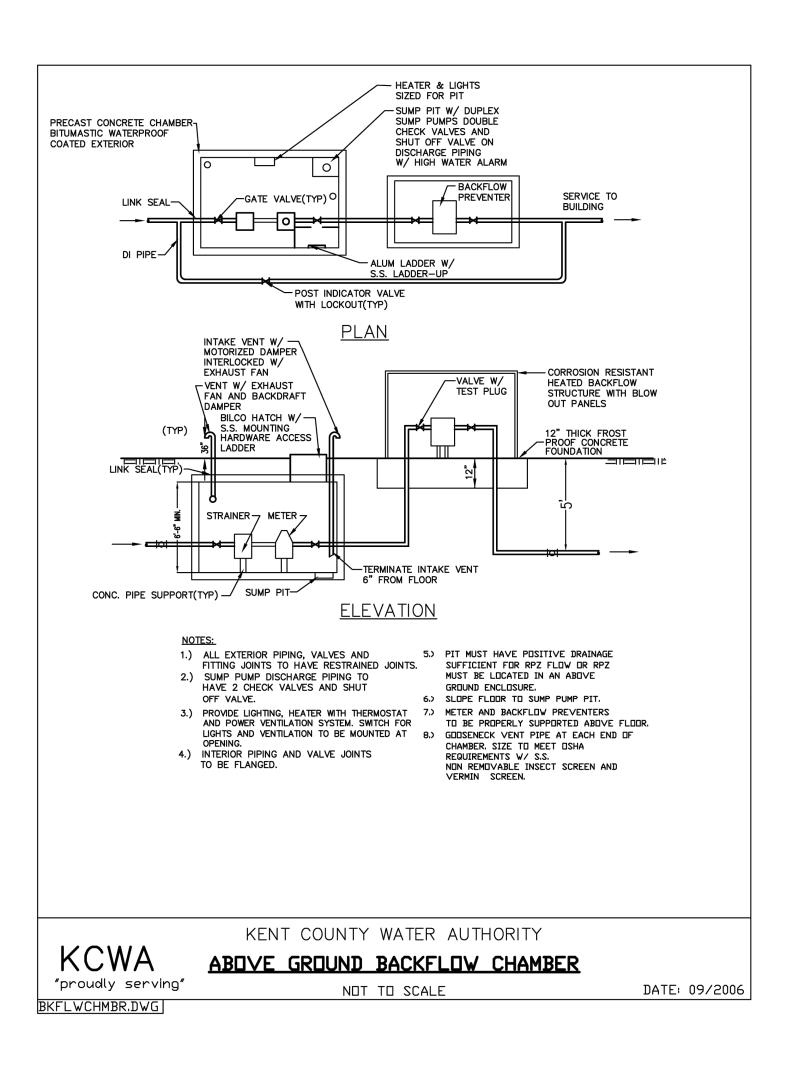


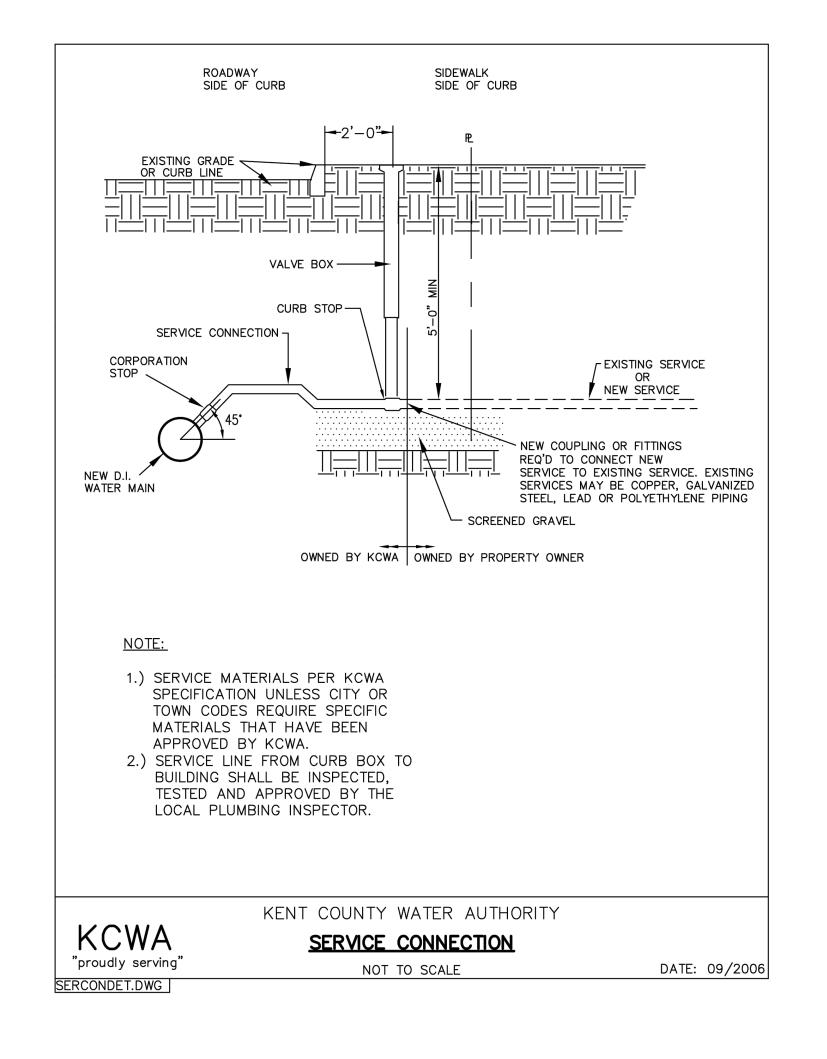

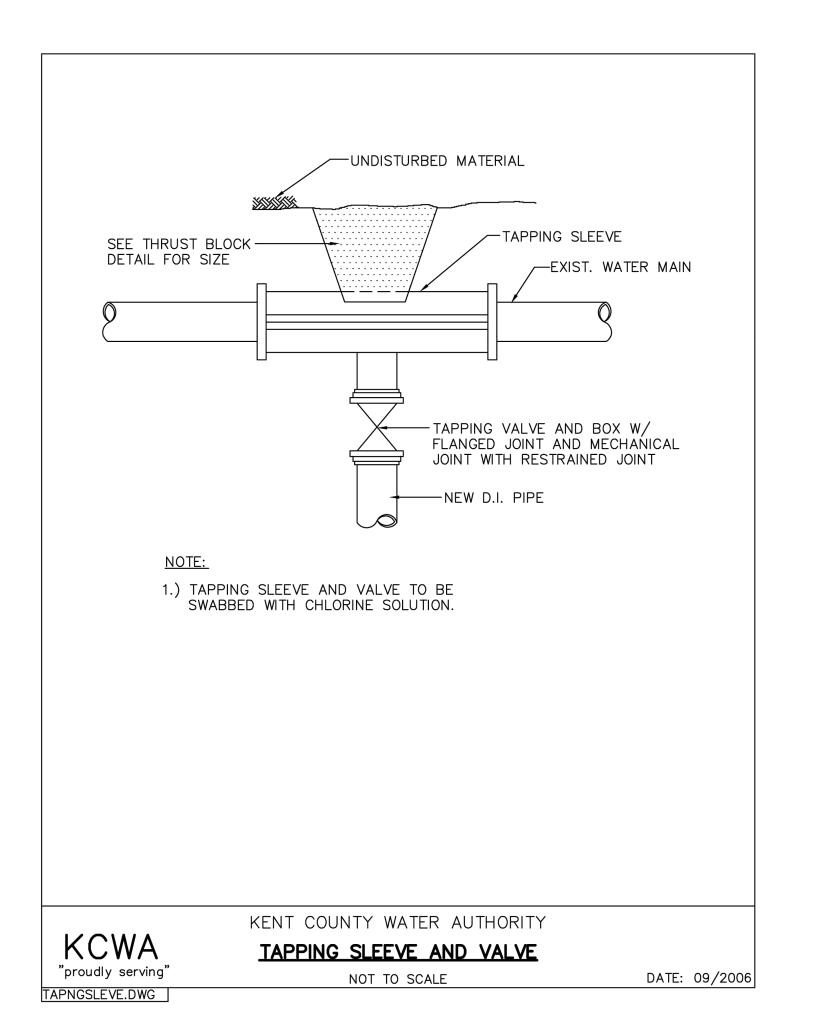

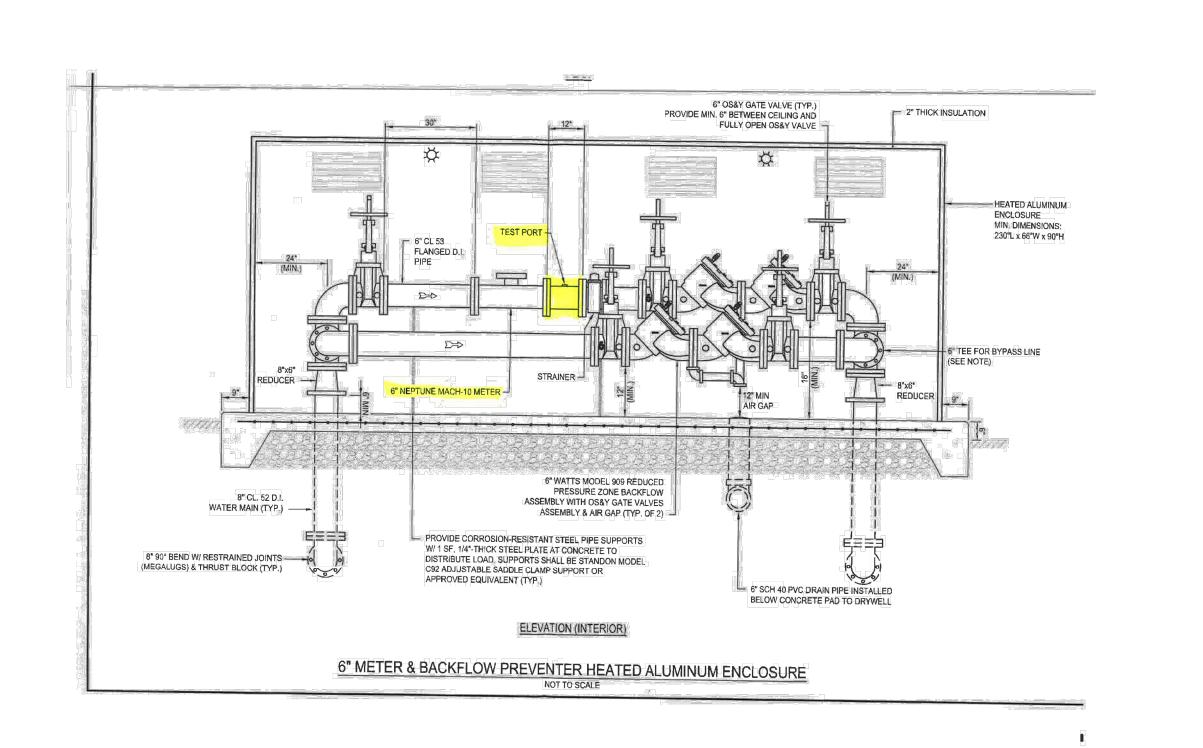

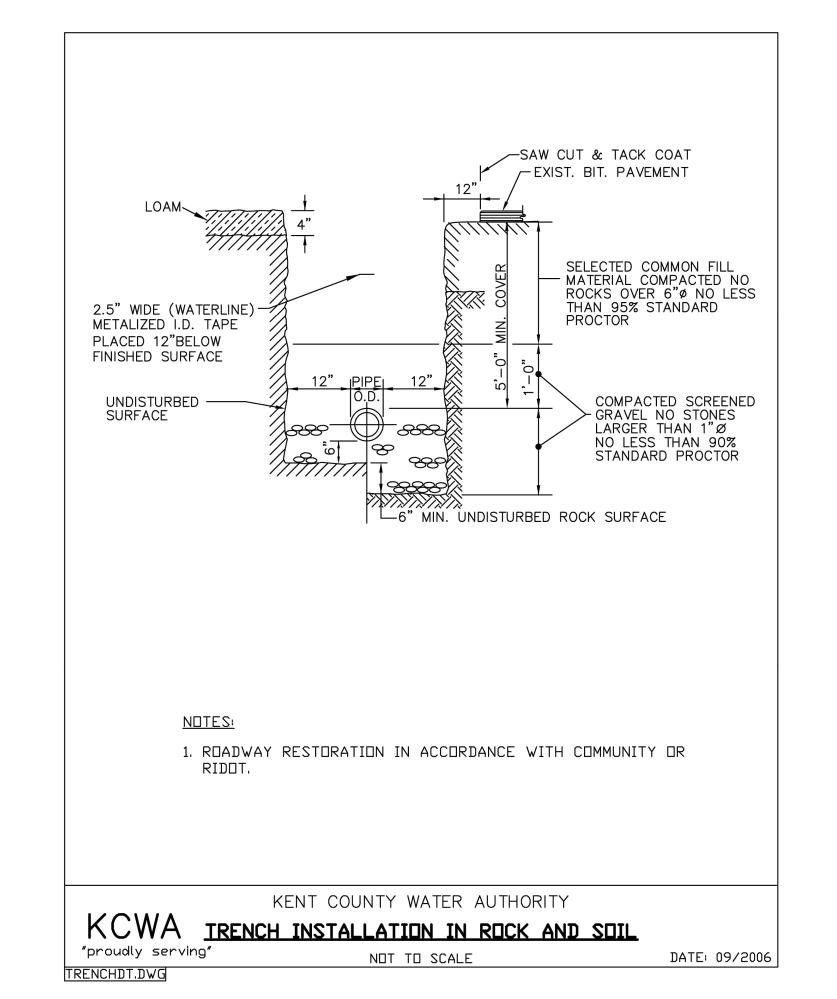

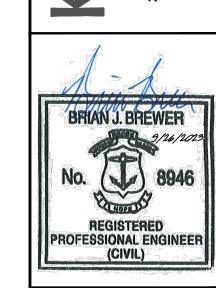


CALE AS SHOWN
ESIGNED BY CGA

TY DETAILS


PREPARED FOR ENECK HILL COVENTRY, LLC 20 NOOSENECK HILL RD COVENTRY, RI 02816


SHEET NUMBER


C-4.4

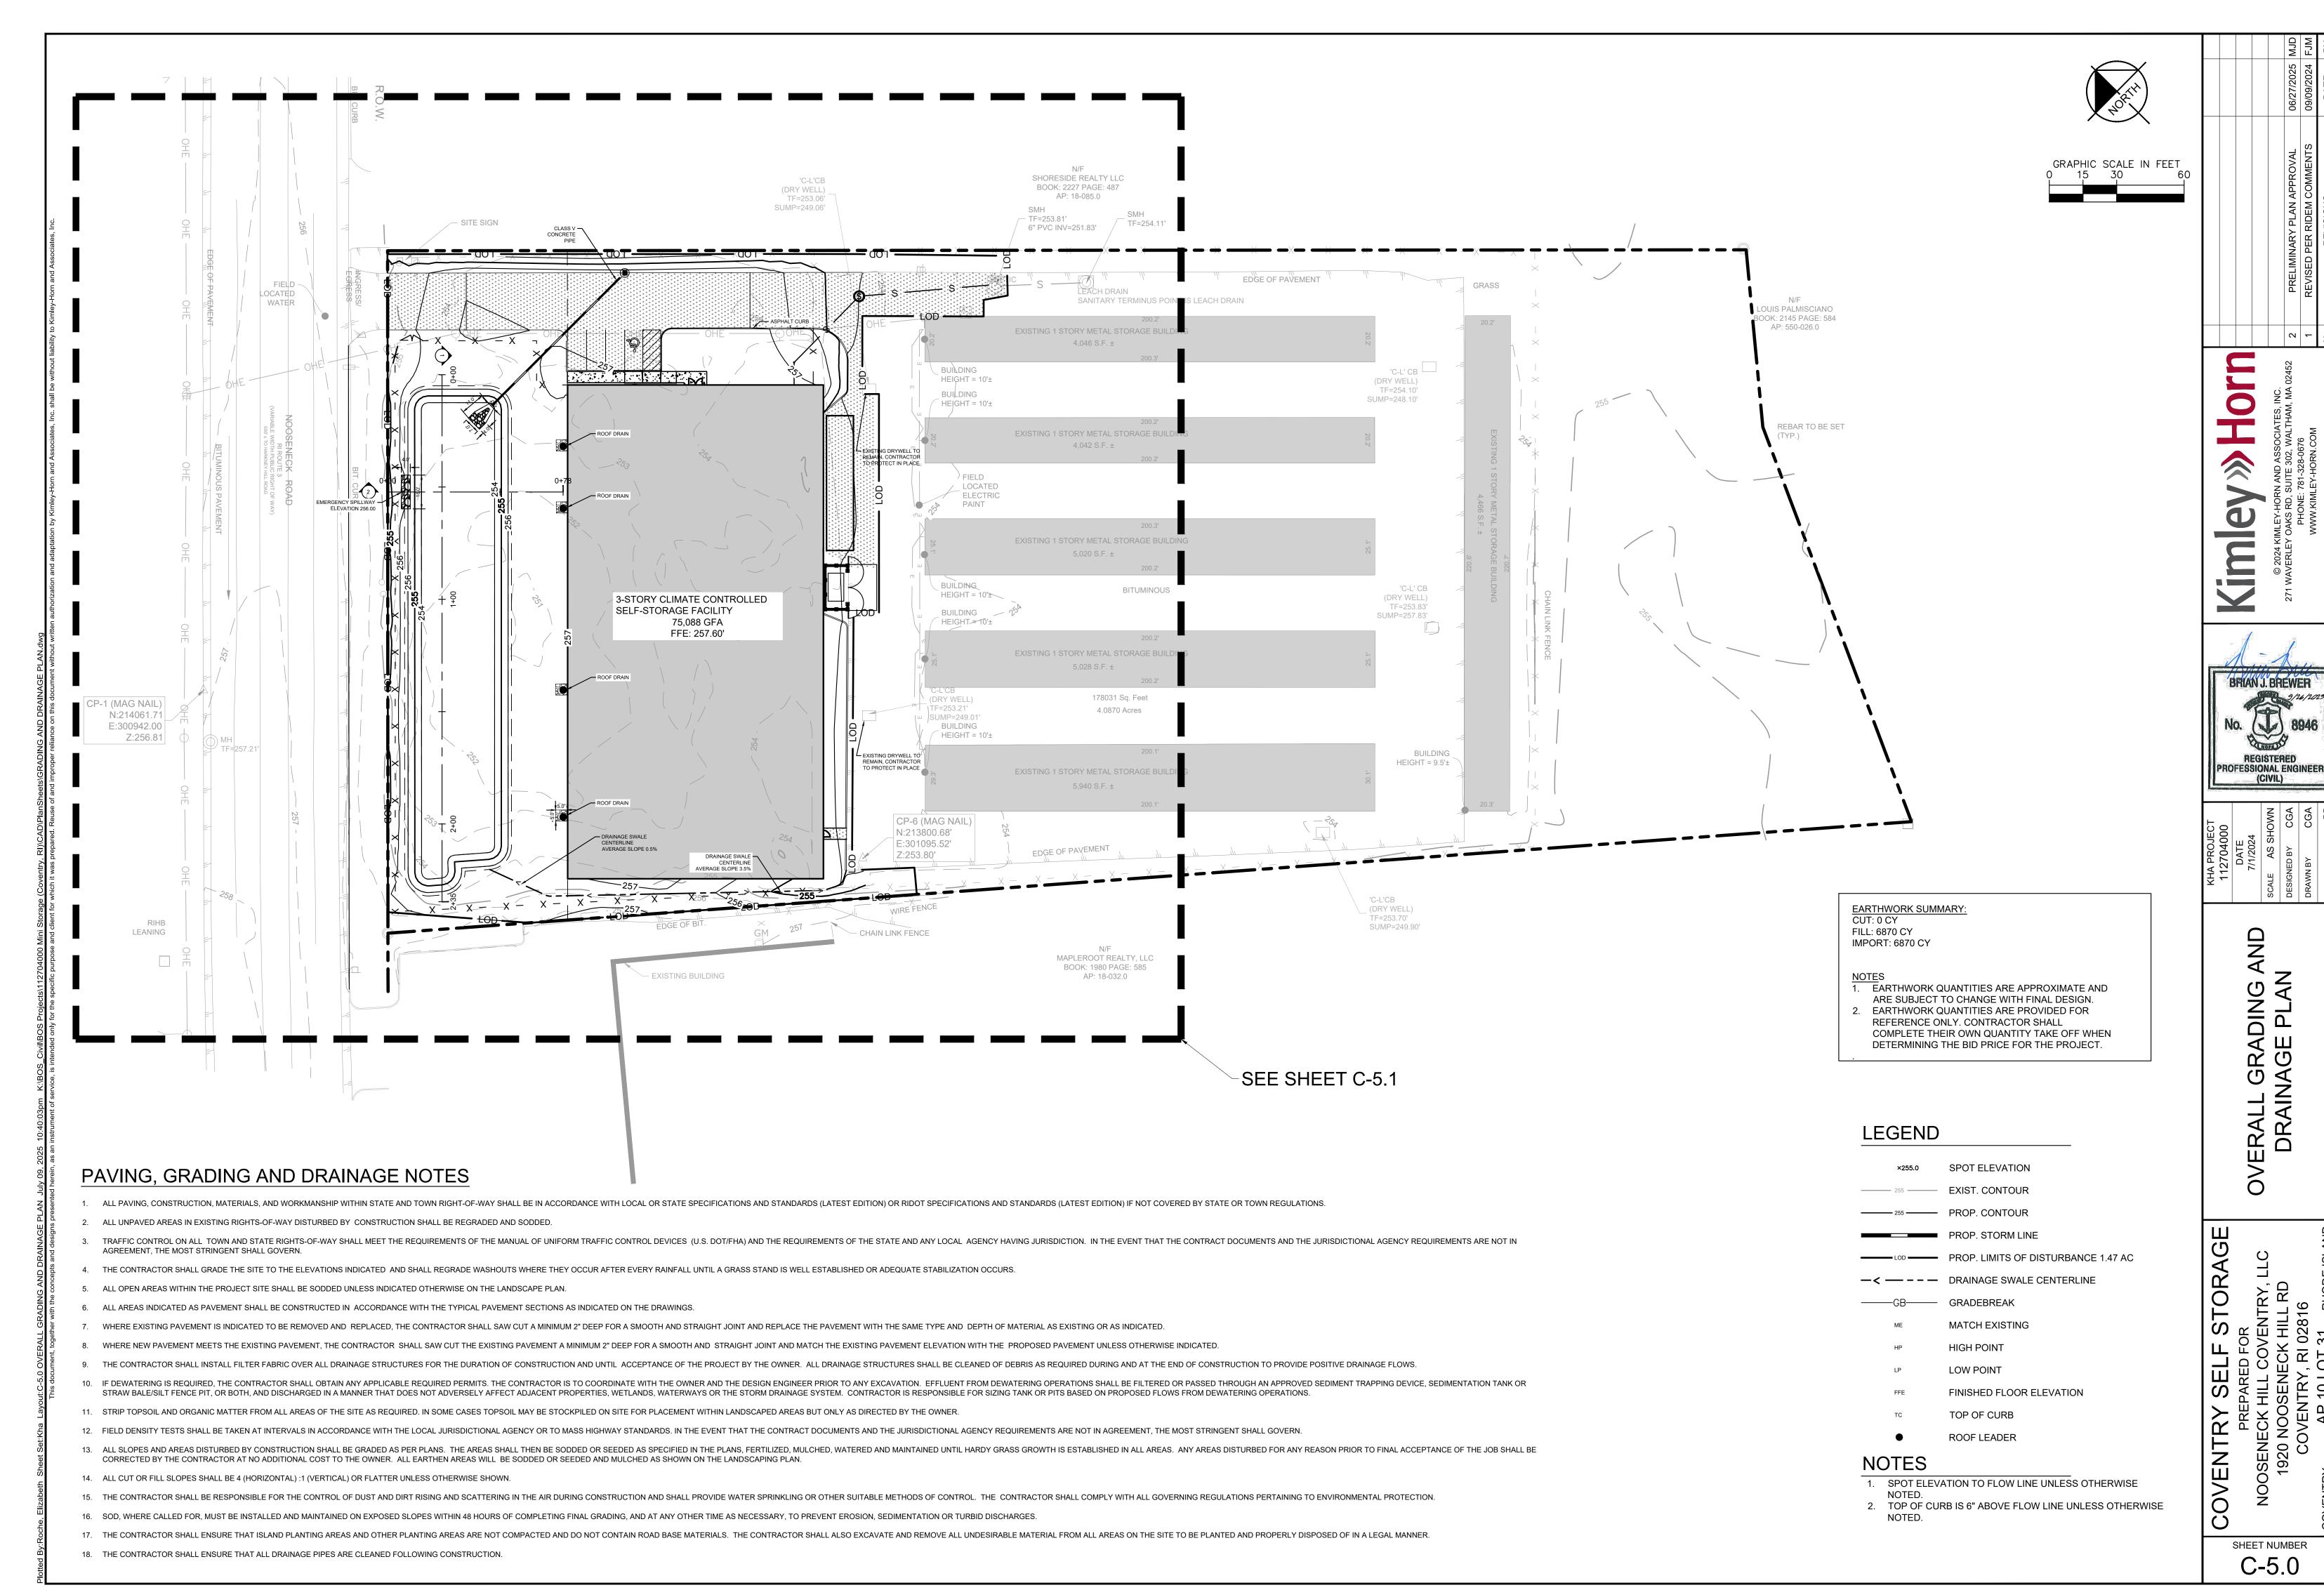

SHEET NUMBER C-5.0

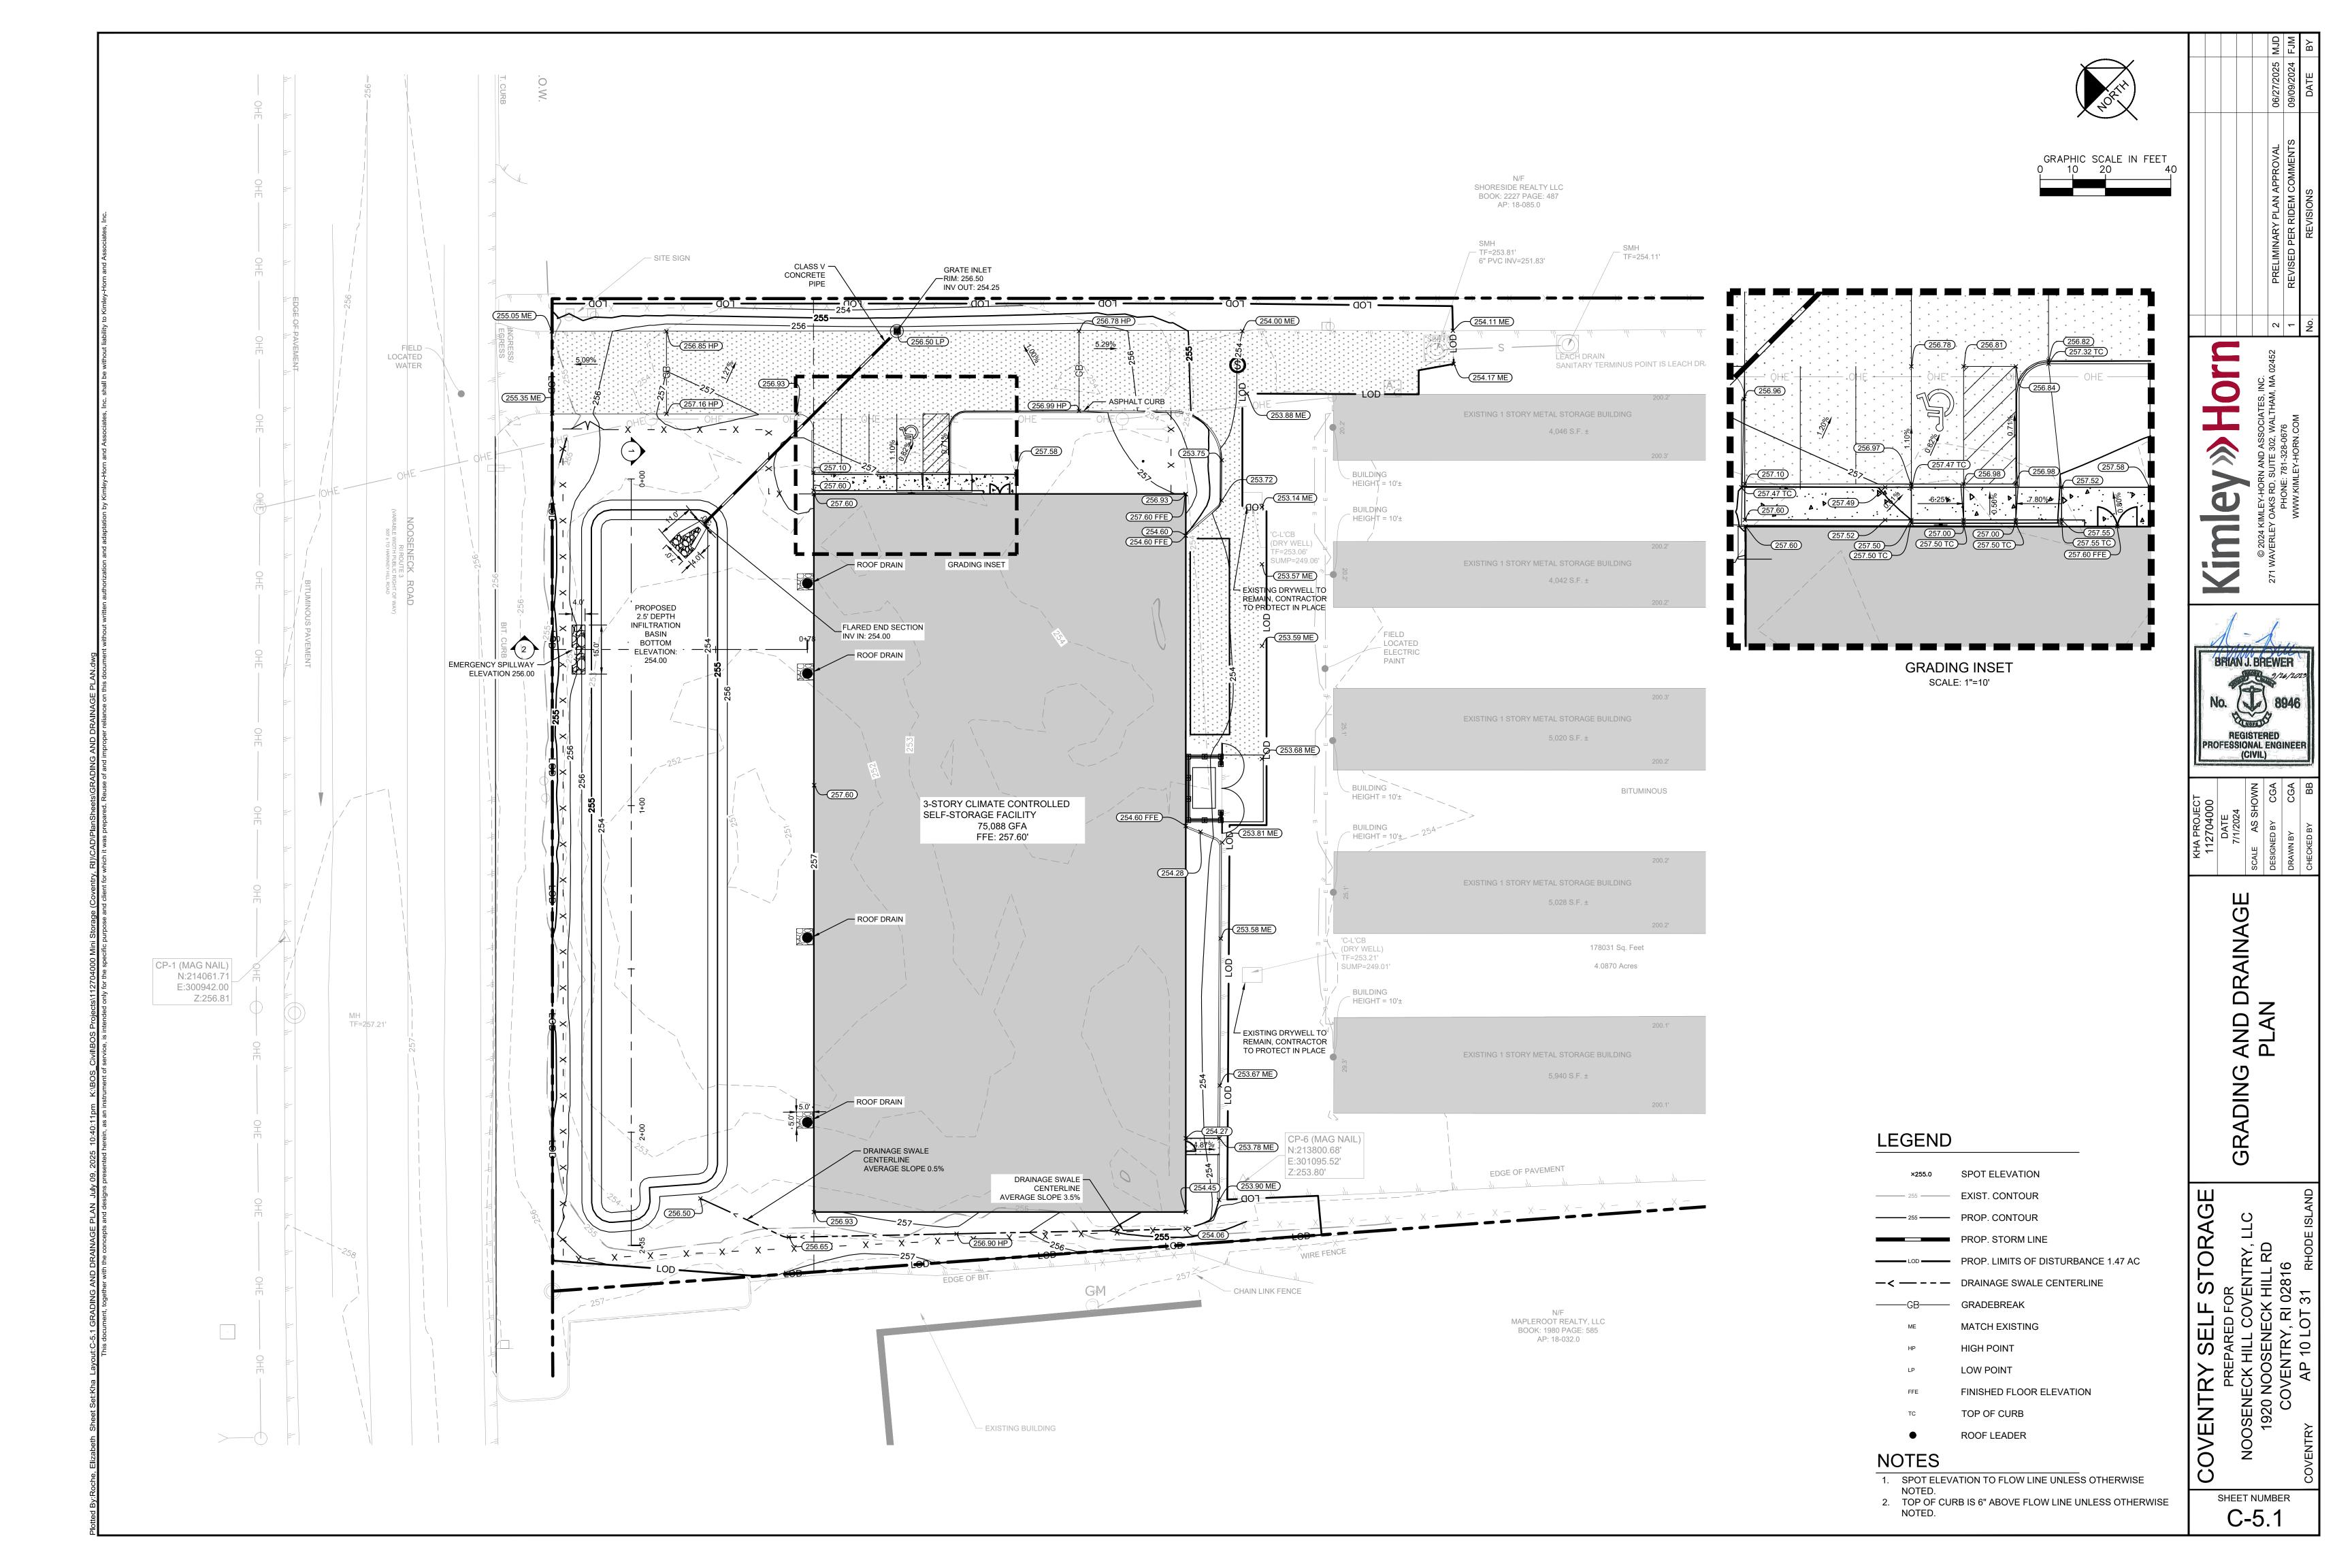

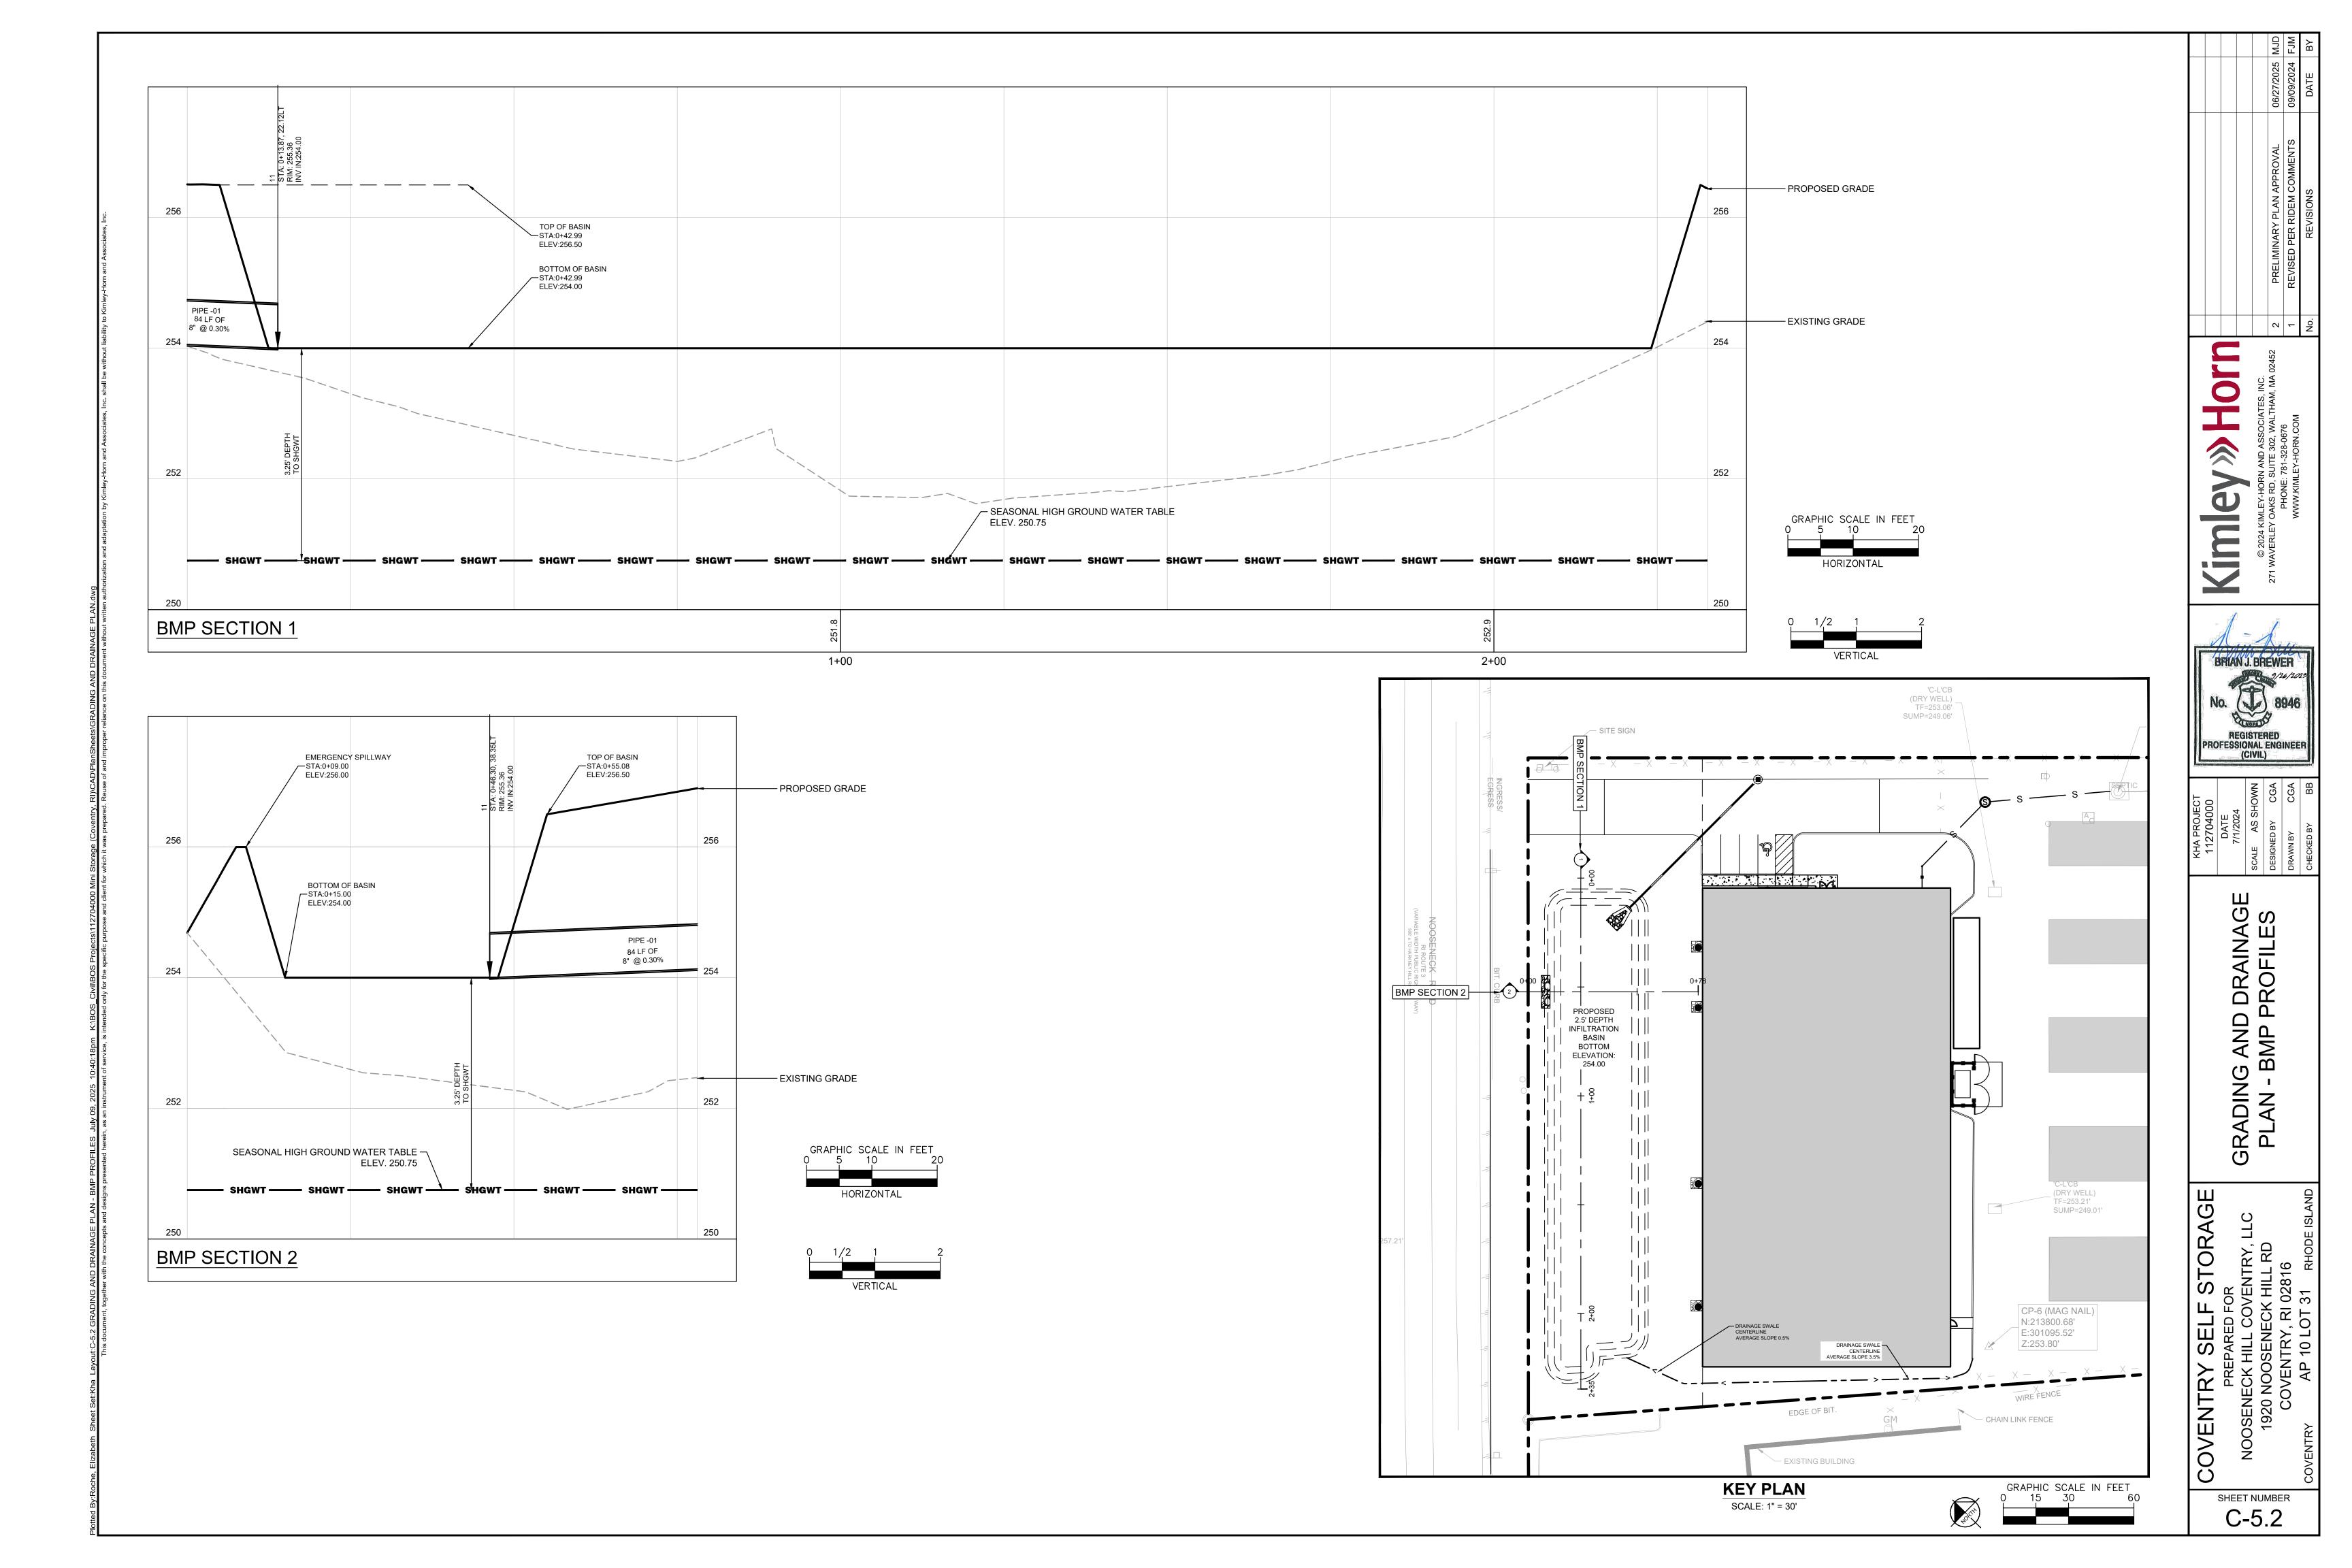

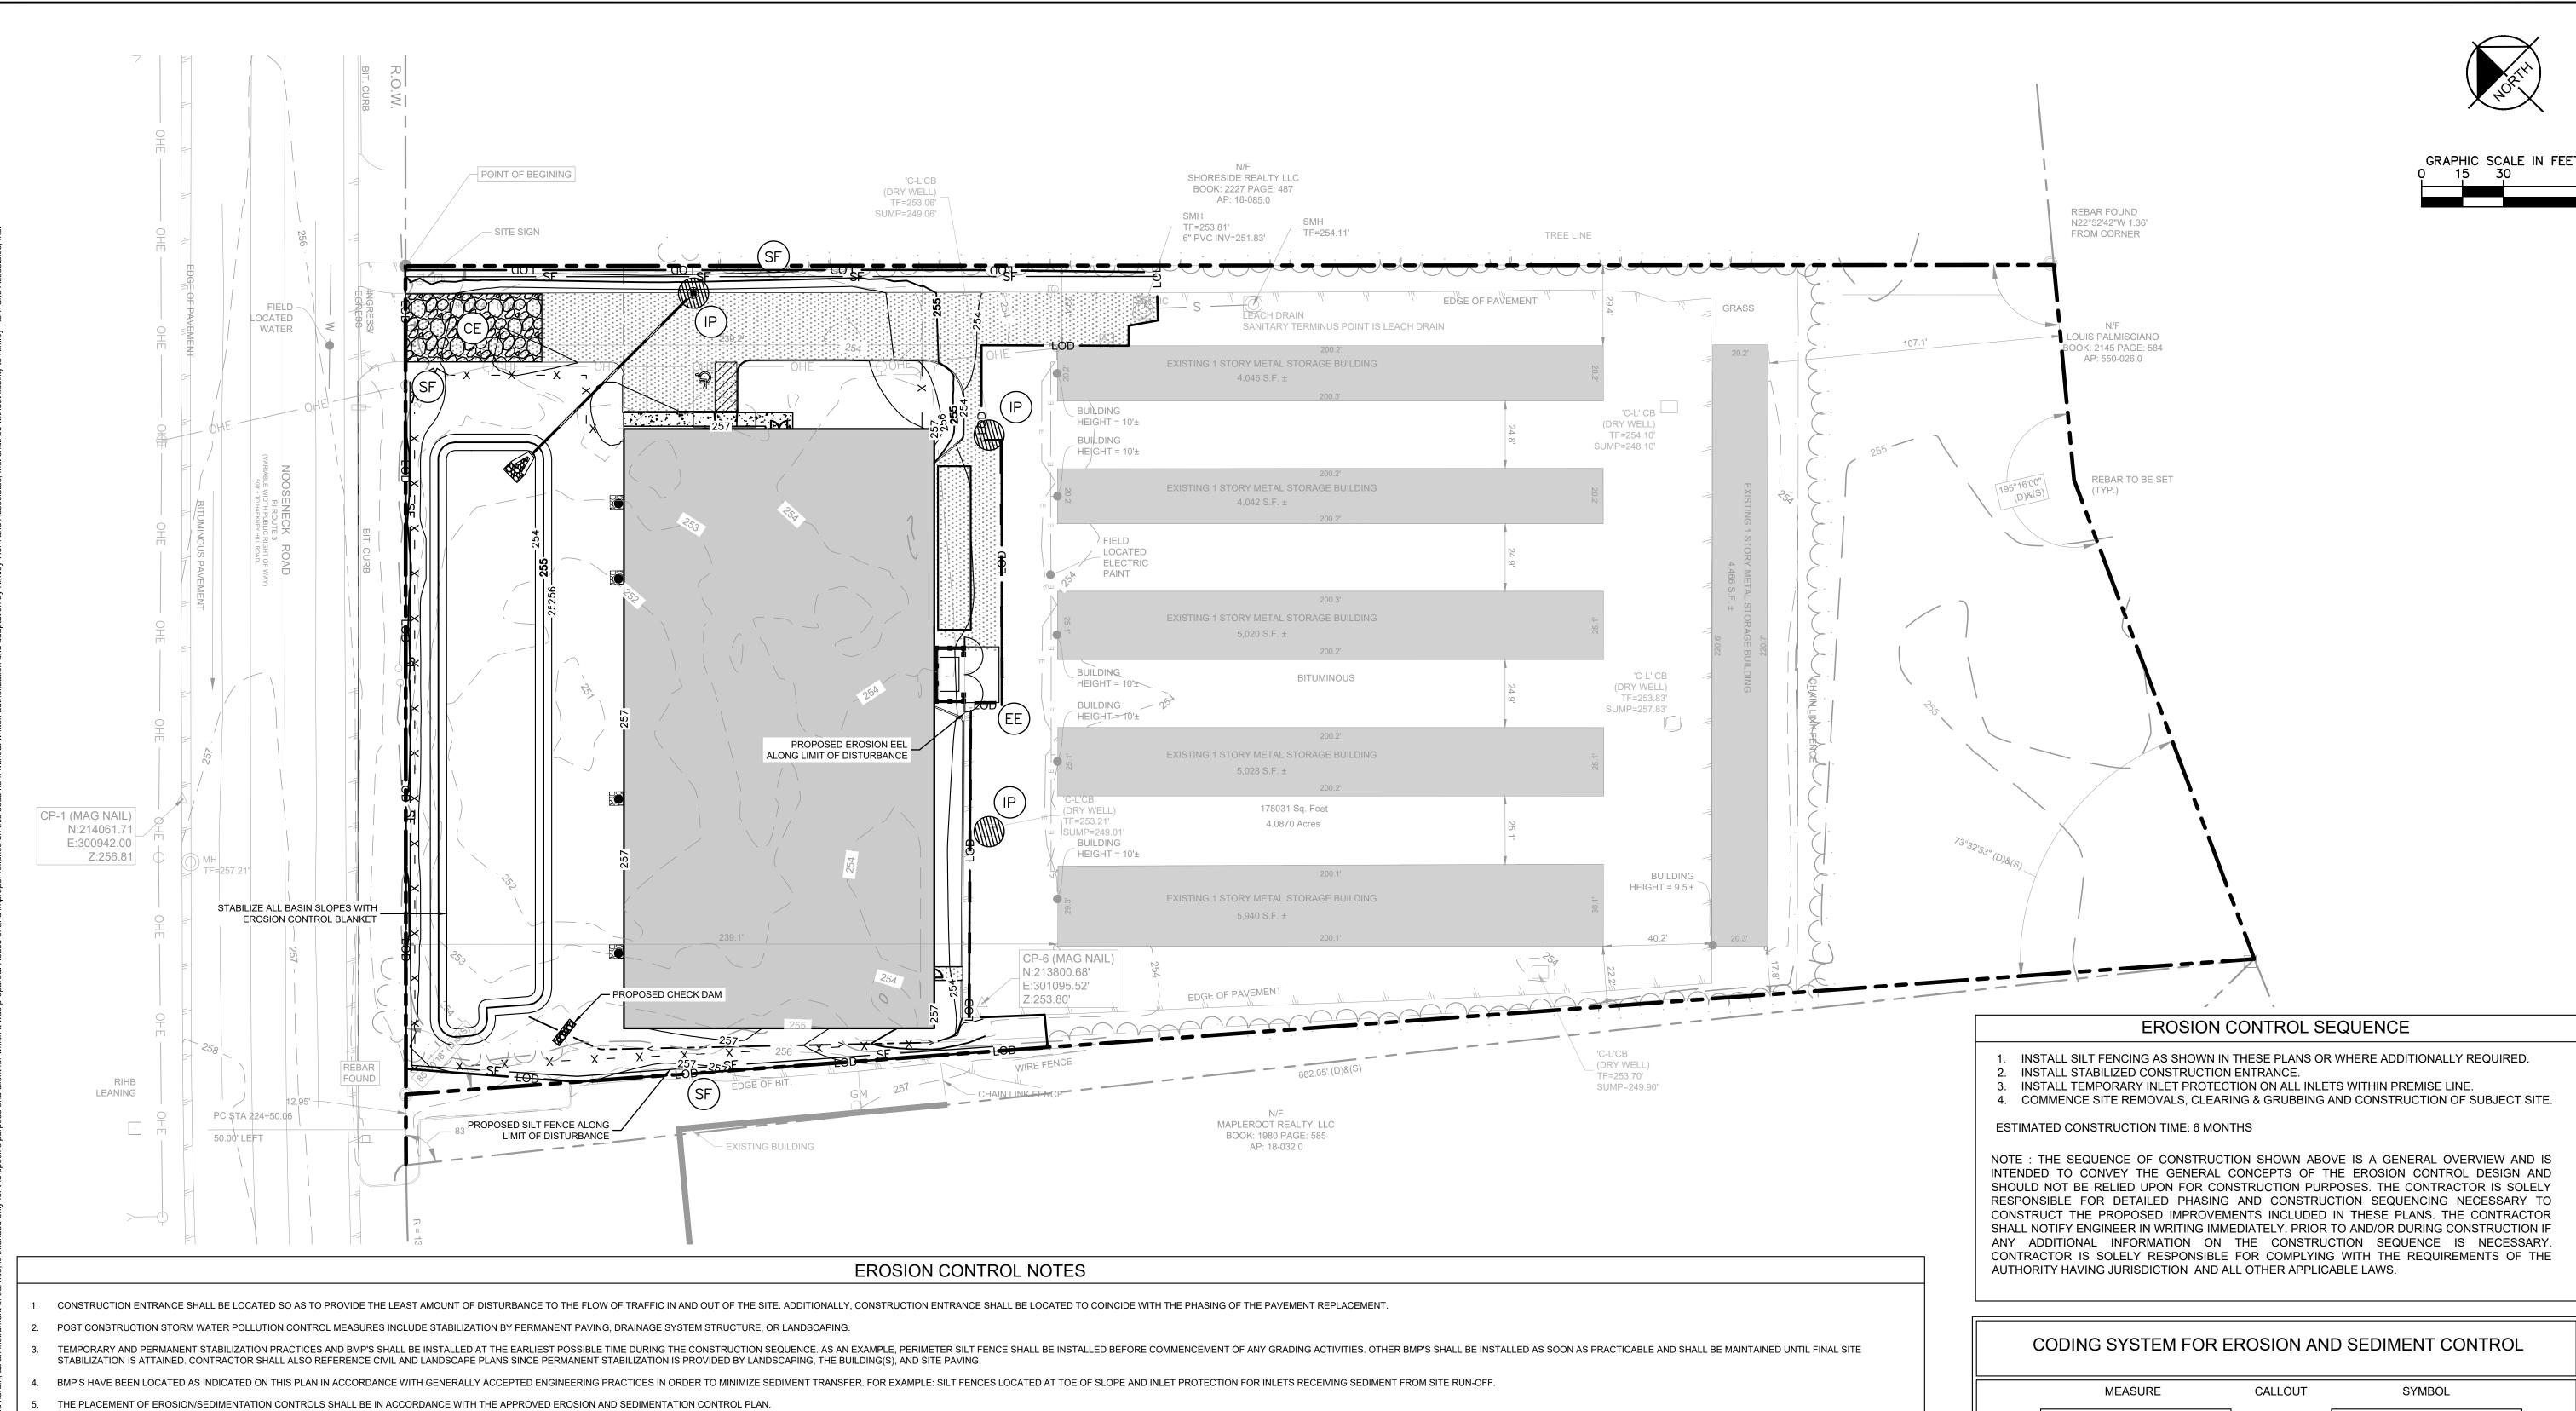

- ANY MAJOR VARIATION IN MATERIALS OR LOCATIONS OF CONTROLS OR FENCES FROM THOSE SHOWN ON THE APPROVED BY THE REVISION AND MUST BE APPROVED BY THE PLANNING AND DEVELOPMENT DEPARTMENT AND THE DRAINAGE UTILITY DEPARTMENT. MINOR CHANGES OR ADDITIONAL CONTROL MEASURES TO BE MADE AS FIELD REVISIONS TO THE ENVIRONMENTAL INSPECTOR DURING THE COURSE OF CONSTRUCTION TO CORRECT CONTROL INADEQUACIES AT NO ADDITIONAL COST TO THE OWNER.
- CONTRACTOR SHALL PLACE EROSION CONTROL BLANKET (NORTH AMERICAN GREEN S150BN OR APPROVED EQUAL) ON ALL SITE AREAS WITH SLOPES GREATER THAN 4:1, AND IN THE BOTTOM AND SIDE SLOPES OF ALL SWALES.
- PRIOR TO FINAL ACCEPTANCE, HAUL ROADS AND WATERWAY CROSSINGS CONSTRUCTED FOR TEMPORARY CONTRACTOR ACCESS MUST BE REMOVED, ACCUMULATED SEDIMENT REMOVED FROM THE WATERWAY AND THE AREA RESTORED TO THE ORIGINAL GRADE AND REVEGETATED. ALL LAND CLEARING SHALL BE DISPOSED OF IN APPROVED SPOIL DISPOSAL SITES.
- PERMANENT, FINAL PLANT COVERING OR STRUCTURES SHALL BE INSTALLED PRIOR TO FINAL ACCEPTANCE.
- 10. ALL CONTROL DEVICES THAT FUNCTION SIMILARLY TO SILT FENCE OR FIBER ROLLS MUST BE REPAIRED, REPLACED OR SUPPLEMENTED WITH EFFECTIVE CONTROLS WHEN THEY BECOME NONFUNCTIONAL OR THE RAINFALL EVENT OR AS SOON AS FIELD CONDITIONS ALLOW ACCESS.
- 11. ALL SEDIMENT DELTAS AND DEPOSITS MUST BE REMOVED FROM SURFACE WATERS, DRAINAGE WAYS, CATCH BASINS AND OTHER DRAINAGE SYSTEMS. ALL AREAS WHERE SEDIMENT REMOVAL RESULTED IN EXPOSED SOIL MUST BE RESTABILIZED. THE REMOVAL AND STABILIZED. THE REMOVAL AND STABILIZED. THE REMOVAL AND STABILIZED. THE REMOVAL RESULTED IN EXPOSED SOIL MUST BE RESTABILIZED. THE REMOVAL AND STABILIZED. THE REMOVAL AND STABILIZED. THE REMOVAL AND STABILIZED. THE REMOVAL RESULTED IN EXPOSED SOIL MUST BE RESTABILIZED. THE REMOVAL AND STABILIZED. REGULATORY OR PHYSICAL ACCESS CONSTRAINTS. ALL REASONABLE EFFORTS MUST BE USED TO OBTAIN ACCESS. ONCE ACCESS IS OBTAINED, REMOVAL AND STABILIZATION MUST TAKE PLACE IMMEDIATELY, BUT NO MORE THAN 7 DAYS LATER. CONTRACTOR IS RESPONSIBLE FOR CONTACTING ALL APPROPRIATE AUTHORITIES AND RECEIVING THE APPLICABLE PERMITS PRIOR TO CONDUCTING ANY
- ACCUMULATIONS OF TRACKED AND DEPOSITED SEDIMENT MUST BE REMOVED FROM OFF-SITE PAVED SURFACES WITHIN 24 HOURS OR SOONER IF REQUIRED. SEDIMENT TRACKING MUST BE MINIMIZED BY THE APPROPRIATE MANAGEMENT PRACTICE, LIKE A DEDICATED SITE EXIT WITH AN AGGREGATE SURFACE OR DESIGNATED OFFSITE PARKING AREA. CONTRACTOR IS RESPONSIBLE FOR STREET SWEEPING AND/OR SCRAPING IF YOUR PRACTICES ARE NOT ADEQUATE TO PREVENT SEDIMENT FROM BEING TRACKED FROM THE SITE.
- SURFACE WATERS, DRAINAGE DITCHES AND CONVEYANCE SYSTEMS MUST BE INSPECTED FOR SEDIMENT DEPOSITS.
- 14. THE CONTRACTOR SHALL INSTALL AND MAINTAIN ALL EROSION CONTROL MEASURES AS INDICATED ON THIS SHEET IN ACCORDANCE WITH THE STORMWATER POLLUTION PREVENTION PLAN (SWPPP) PREPARED BY KIMLEY-HORN AND ASSOCIATES, INC. THE CONTRACTOR IS RESPONSIBLE FOR IMPLEMENTING THE PROVISIONS INDICATED IN THE SWPPP, INCLUDING EROSION CONTROL MEASURES AND INSPECTION FREQUENCY, AS REQUIRED BY THE NYC DEC SWPPP REQUIPREMENTS.
- 15. PUMPING SEDIMENT LADEN WATER INTO ANY STORMWATER FACILITY THAT IS NOT DESIGNATED TO BE A SEDIMENT TRAP, DRAINAGEWAY, OR OFFSITE AREA EITHER DIRECTLY OR INDIRECTLY WITHOUT FILTRATION IS PROHIBITED.
- 16. SOIL STOCKPILES SHALL NOT BE LOCATED IN A DRAINAGEWAY, FLOOD PLAIN AREA OR A DESIGNATED BUFFER, UNLESS OTHERWISE APPROVED, UNDER SPECIFIC CONDITIONS TO BE ESTABLISHED BY THE DIRECTOR OR ADMINISTRATOR.
- 17. STOCKPILES TO REMAIN IN PLACE FOR MORE THAN THREE DAYS SHALL BE PROVIDED WITH SESC MEASURES. MATERIAL IS TO BE HAULED OFF IMMEDIATELY AND LEGALLY IF NO STOCKPILE IS TO REMAIN IN PLACE.
- 18. ALL TEMPORARY SESC MEASURES SHALL BE REMOVED WITHIN 30 DAYS AFTER FINAL STABILIZATION IS ACHIEVED.TRAPPED SEDIMENT AND OTHER DISTURBED SOILS RESULTING FROM TEMPORARY MEASURES SHALL BE PROPERLY DISPOSED OF PRIOR TO PERMANENT STABILIZATION.
- 19. WATER REMOVED FROM TRAPS, BASINS, AND OTHER WATER HOLDING DEPRESSIONS OR EXCAVATIONS MUST FIRST PASS THROUGH A SEDIMENT CONTROL AND/OR FILTRATION DEVICE. WHEN DEWATERING DEVICES ARE USED, DISCHARGE LOCATIONS SHALL BE PROTECTED FROM EROSION.
- 20. SITE STABILIZATION REQUIREMENTS ARE AS FOLLOWS:
- 20.1. WHERE THE INITIATION OF STABILIZATION MEASURE BY THE 7TH DAY AFTER CONSTRUCTION ACTIVITY TEMPORARILY OR PERMANENTLY CEASES ON A PORTION OF THE SITE IS PRECLUDED BY SNOW COVER, STABILIZATION MEASURE SHALL BE INITIATED AS SOON AS PRACTICABLE.
- 20.2. WHERE CONSTRUCTION ACTIVITY WILL RESUME ON A PORTION OF THE SITE WITHIN 14 DAYS FROM WHEN ACTIVITY IS TEMPORARILY CEASED, (E.G. THE TOTAL TIME PERIOD THAT CONSTRUCTION MEASURES DO NOT HAVE TO BE INITIATED ON THAT PORTION OF THE SITE BY THE 7TH DAY AFTER CONSTRUCTION ACTIVITY TEMPORARILY

# LIMIT OF DISTURBANCE - LOD --- LOD ---SAFETY FENCE CONSTRUCTION ENTRANCE SILT FENCE **INLET PROTECTION** (CIP) **CULVERT INLET PROTECTION** TEMPORARY SEEDING PERMANENT SEEDING TREE PROTECTION **EROSION EEL**


ENTR SHEET NUMBER


C-6.0


PROFESSIONAL ENGINEER


M A


ON AND ONTROL

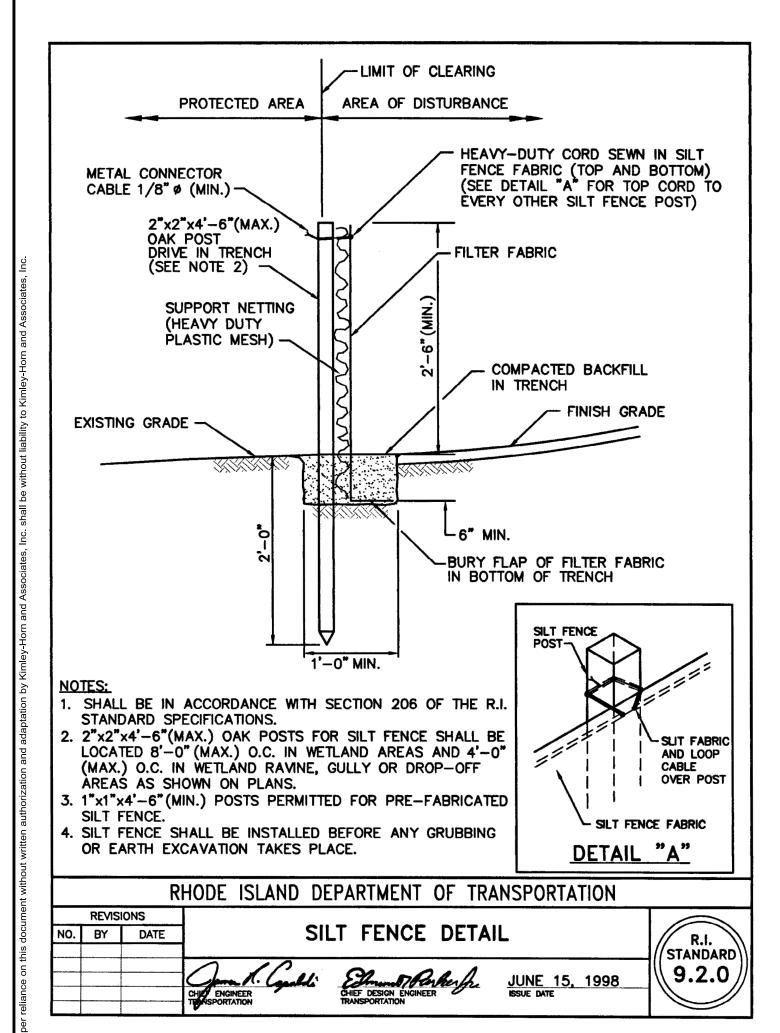


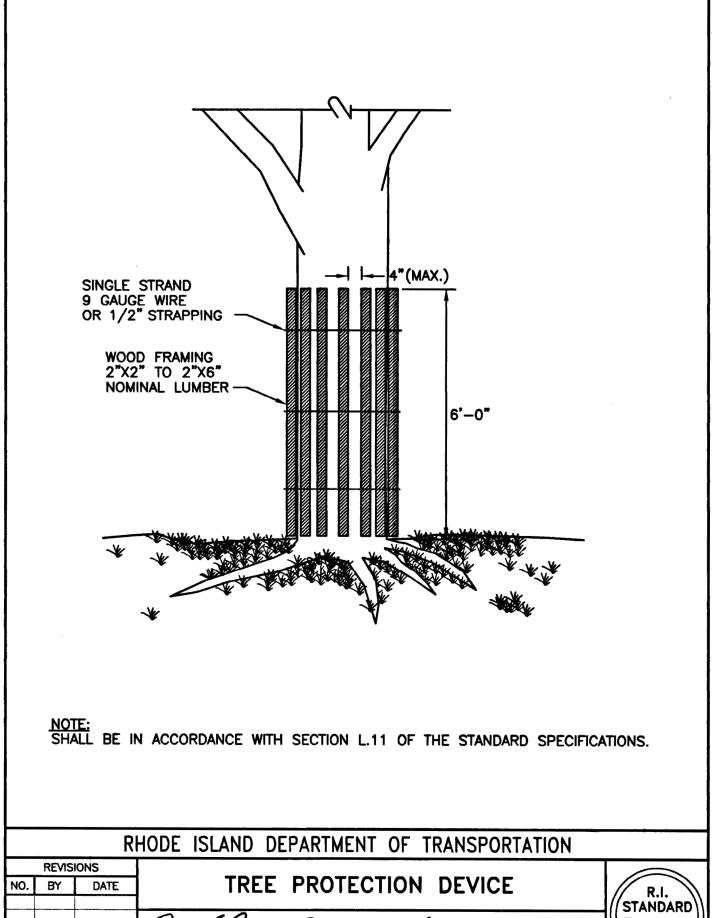


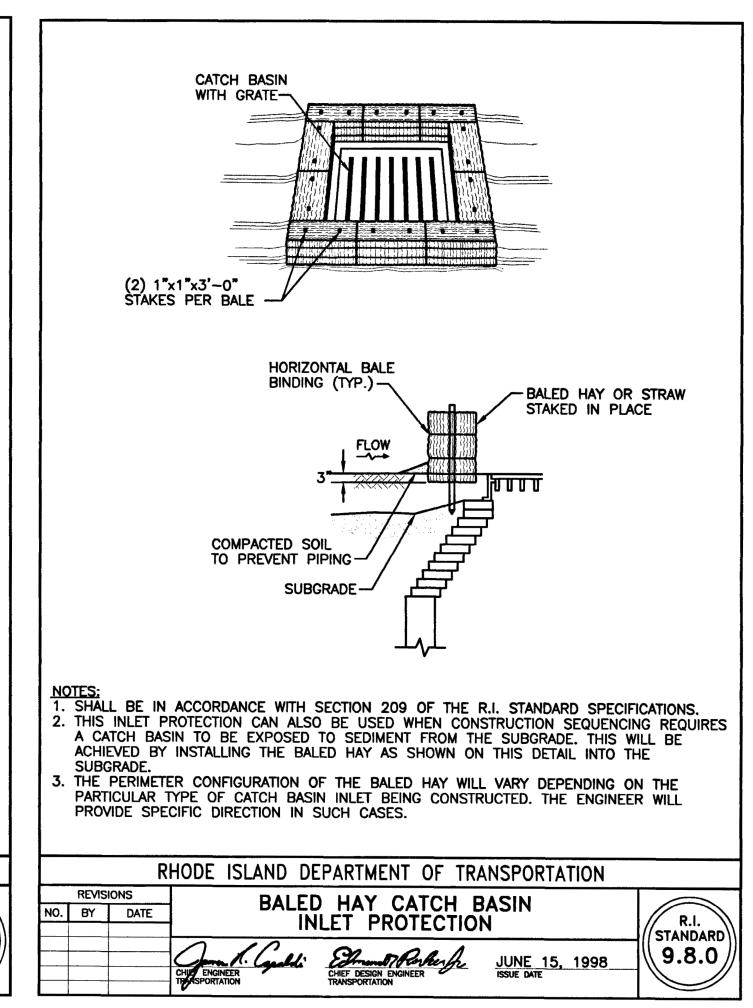

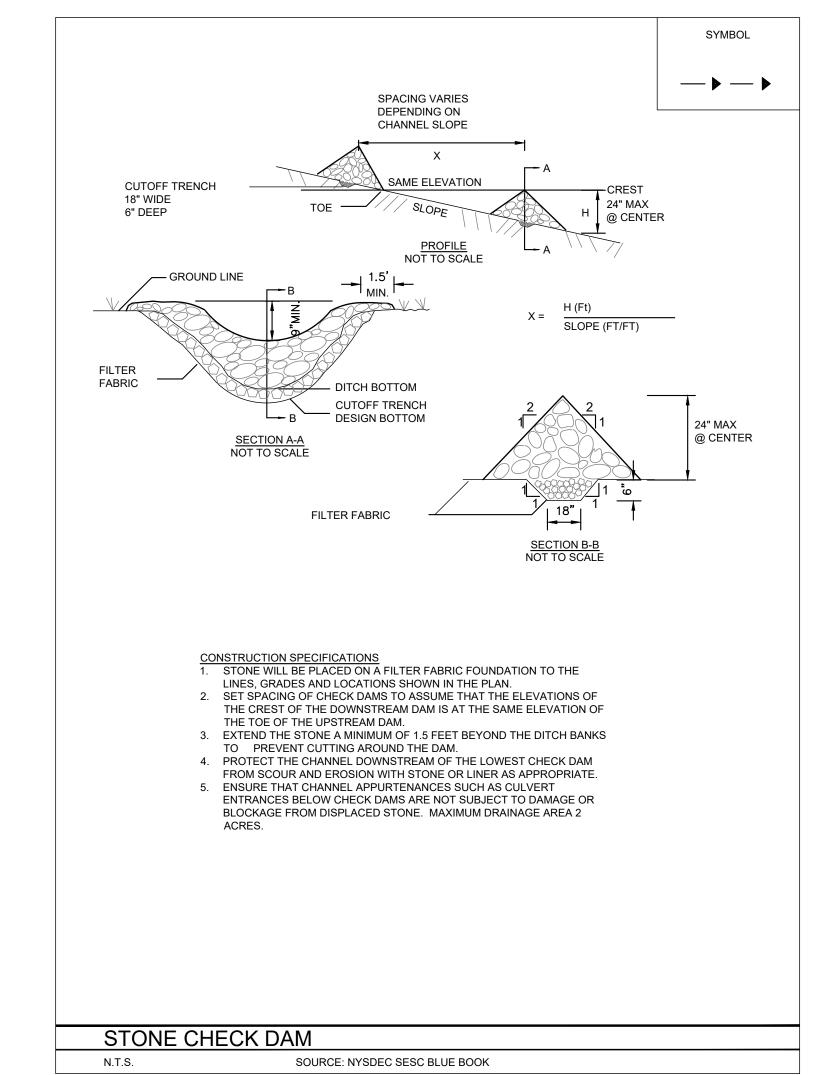

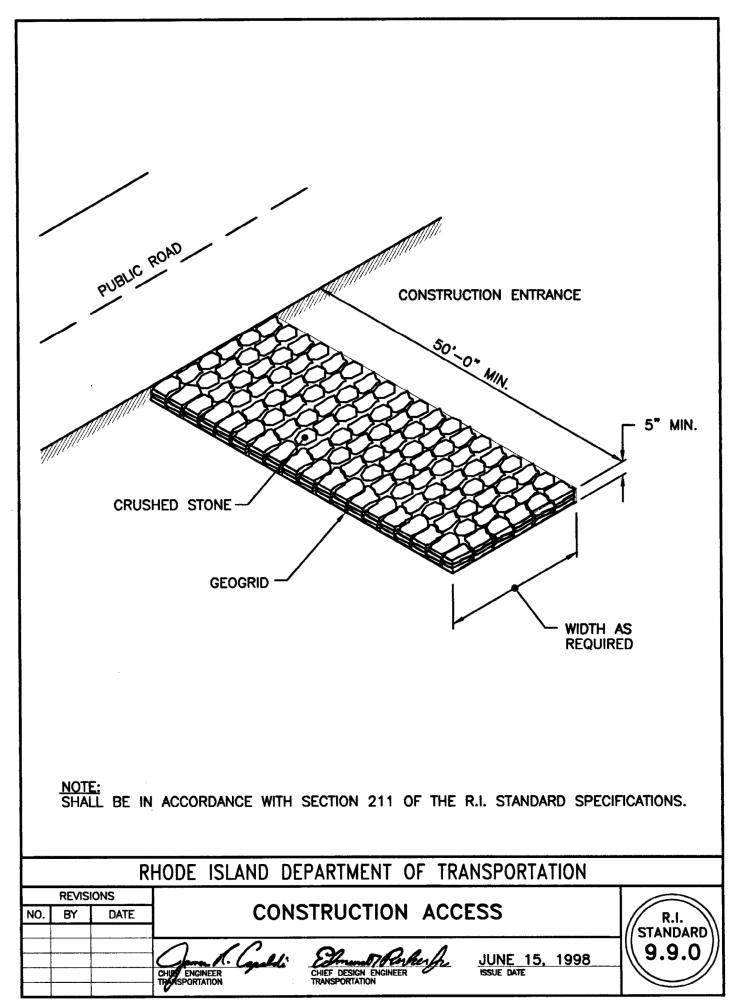

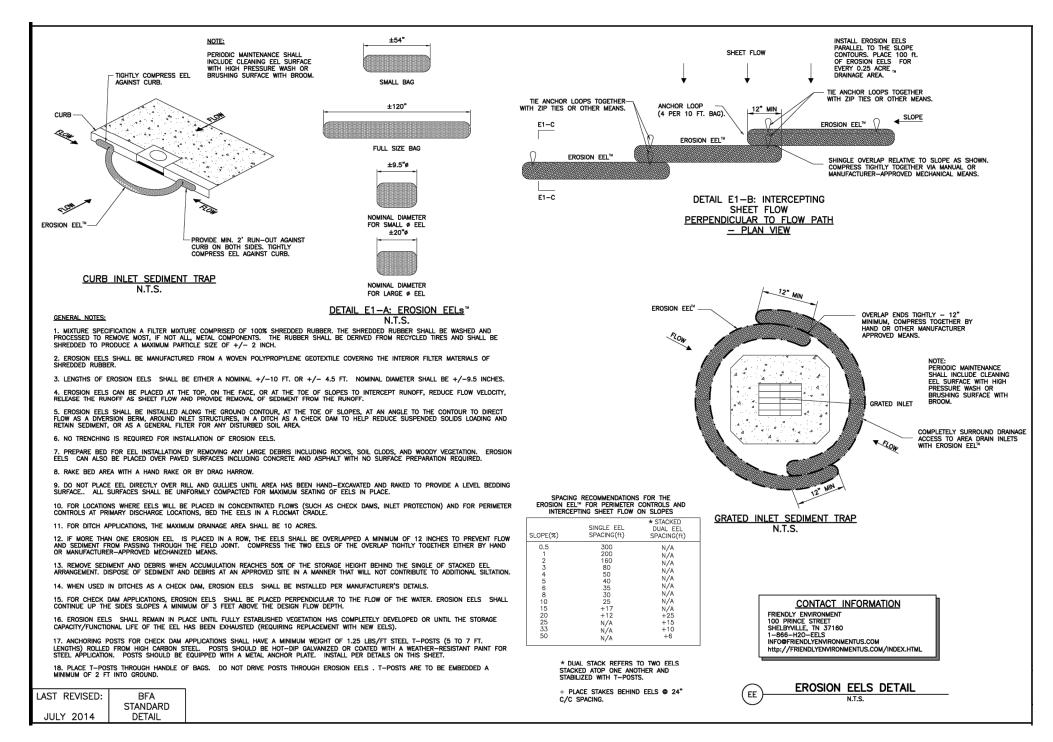

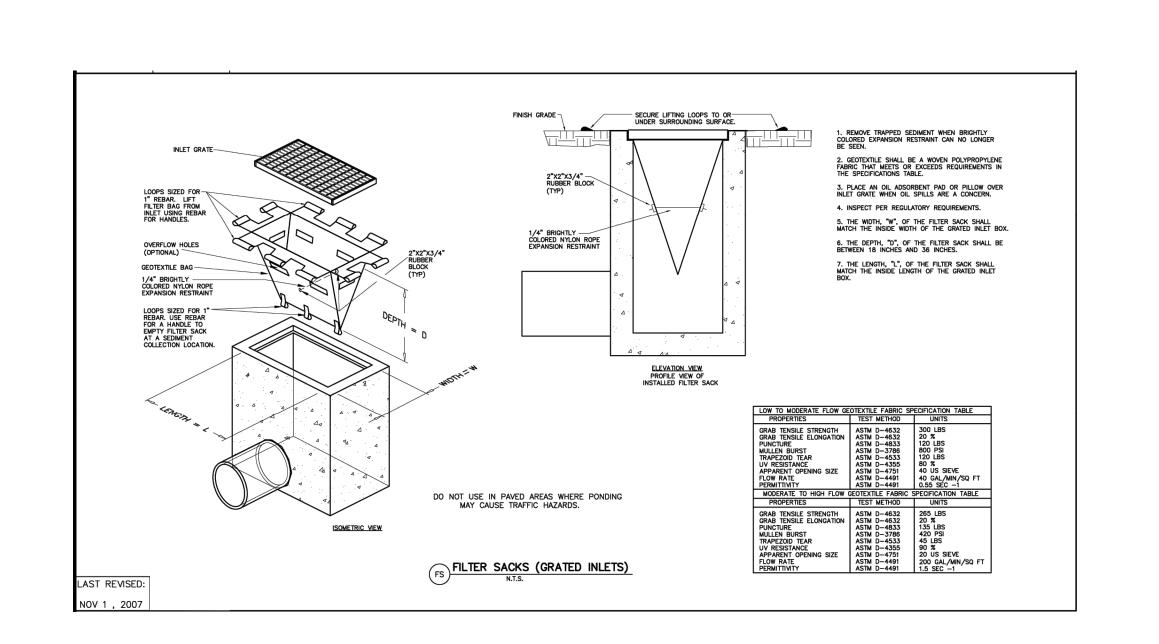

EDIMENT SETAILS SEC DE EROSION & CONTROL


REGISTERED **PROFESSIONAL ENGINEER** 

(CIVIL)

TORAGE

VENTR SHEET NUMBER

C-6.1

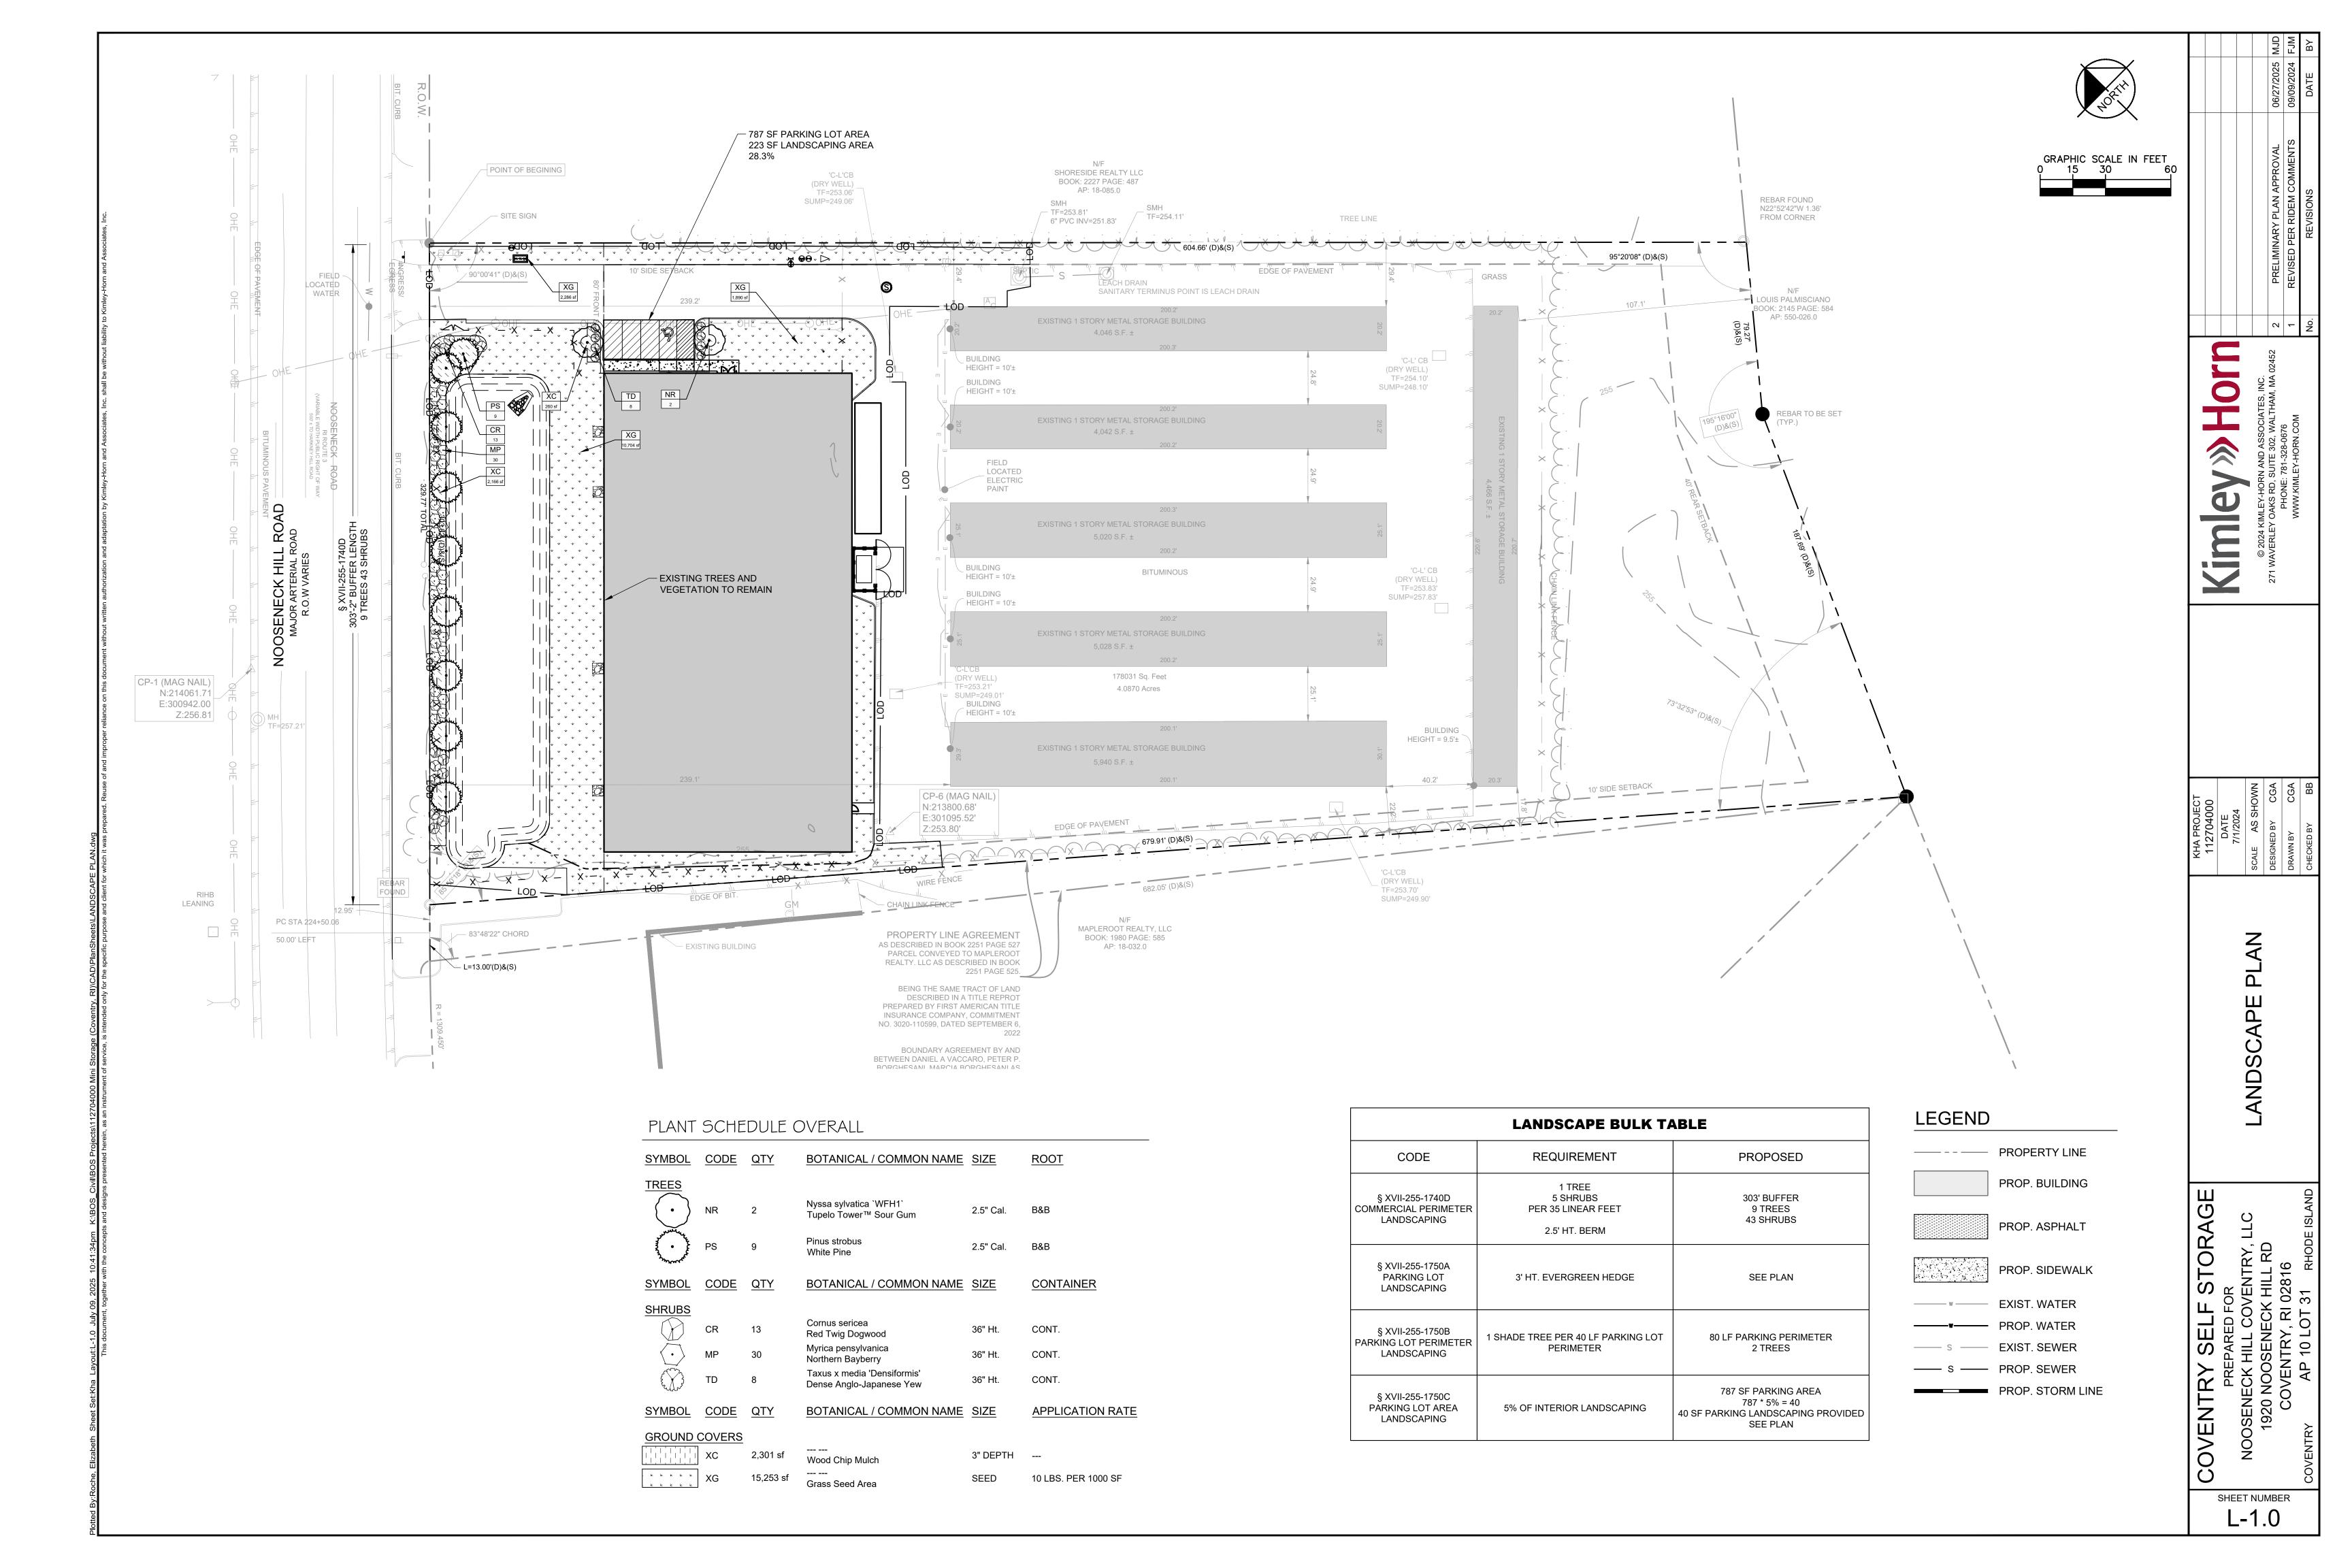

#### **GENERAL NOTES**

- 1. Plants shall be healthy, vigorous material, free of pests and diseases and are subject to approval/rejection of the Landscape Architect prior to, during and after installation.
- 2. Contractor shall identify all materials at growing location prior to purchase and submit digital photographs, and source list to the Landscape Architect for approval at a minimum of six (6) calendar weeks prior to installation. Plants not approved shall be resourced and resubmitted.
- 3. Planting beds and individual tree plantings shall be mulched continuously as specified.
- 4. Prior to construction the contractor shall be responsible for locating underground utilities and execute work in a manner that avoids damage to utilities during the course of work. Contractor shall be responsible or remedy of any damage to utilities, structures, site appurtenances that occur as a result of landscape related work.
- 5. Contractor is responsible for verifying quantities shown on documents. Field adjustments shall be approved by Landscape Architect prior to installation. Quantities indicated on drawings are for reference-it is the Contractor's responsibility to ensure full coverage of plants at the indicated spacing.
- 6. Contractor is responsible for maintenance of all plantings including, but not limited to watering, mowing, edging, spraying, mulching, fertilizing, of plantings and turf areas for one (1) calendar year from date of certificate of occupancy. Contractor is responsible for warranty of all plant material for a period of one (1) calendar year from date of certificate of occupancy. Warranty replacement planting shall meet or exceed the original specification identified on drawings. Replacement planting shall extend the same warranty as originally installed materials. Plantings and grass areas shall be flourishing and fully thriving at end of warranty period.
- 7. Plants identified for replacement by Owner, Landscape Architect shall be replaced immediately by the Contractor unless otherwise agreed upon. Plantings (trees, shrubs, groundcover) subject to replacement by warranty shall exhibit characteristics of 30% dead-per individual plant, non-contributing or disease compromised. Grass areas suitable for acceptance shall demonstrate 85% sustained/consistent and continuous, densely established coverage.
- Contractor shall perform a site review at end of warranty period and provide the Owner with written documentation of the site, including plant health, warranty replacement items, and conditions that may be influencing plant health. Contractor shall remove from plants and site, all staking and guying material at end of warranty period.
- 8. Contractor shall comply with all local, state and federal requirements, codes and regulations related to the work undertaken.
- 9. All material including planting operation appurtenances shall be of domestic origin manufacture and sourced within 100 miles of the project site.
- 10. Contractor is responsible for coordination among trades operating on site. Coordination and if necessary resulting modifications to schedules are responsibility of the Contractor.

#### PERFORMANCE SPECIFICATION

#### I. PLANTS

#### A.General

- 1. Live healthy plants free of dead branches and parts 2. Free of disease, insect, injury and damage
- 3. Unbroken, intact, dense and solid rootballs and containers, without cracks, flat sides or previously repaired
- 4. Free of girdling roots or rootbound/circling container conditions
- 5. Plants of consistent in growth habit and healthy character 6. Free of compromising growth conditions such as weak crotch connections, crossed branches, snags and
- 7. Point of origin growing location within 100 miles of project site
- 8. Graded, standards, caliper, sizes and stock consistent with ANSI Z60.1, American Standard for Nursery
- 9. Species identified consistent with <u>Hortus Third: Concise Dictionary of Plants Cultivated in the United</u> States and Canada, most current edition and Manual of Woody Plants: Their Identification, Ornamental Characteristics, Culture, Propagation and Uses, most current edition
- 10. All disturbed areas shall be grass seed unless otherwise identified on landscape plans

#### B. Trees:

#### 1. Deciduous Single Trunk

- a. Full, straight and upright with consistent symmetrical natural branching pattern throughout b. Branching Height-seven (7) feet to lowest branch in two years unless otherwise required by local jurisdiction
- 2. Deciduous Multi-Trunk
  - a. Full and upright with straight consistent symmetrical natural branching pattern throughout
- b. Canes evenly spaced and of similar growth habit c. Free of suckers and extraneous branching

#### 3. Evergreen Single-Trunk

- a. Full and upright with continuous symmetrical dense natural habit b. Clear branching height twelve (12) inches above top of rootball
- c. Free of suckers and extraneous branching d. Do not shear or otherwise prune to shape plantings

#### C.Evergreen and Deciduous Shrubs

- 1. Full, dense and naturally symmetrical.
- 2. Consistent with container and/or balled and burlapped size
- 3. Free of suckers and extraneous branching 4. Do not shear or otherwise prune or shape plantings

#### D. Evergreen and Deciduous Groundcover 1. Full and dense in pots or flats

- E. Perennials and Seasonal Color
- 1. Full and dense in pots or flats

#### F. Turf Grass

#### 1. Subgrade

- a. Soil Mix-10% Compost, 90% topsoil by volume
- b. Preparation-loosen subgrade to a minimum depth of four (4) inches. Remove all non-natural materials including litter, stones, sticks and all items greater than 3/4 inch in any dimension
- c. Preparation-spread soil mix at a depth of four (4) inches continuously to meet grade elevations shown on drawings. Allow for thickness of sod when applicable

#### 2. Grass Sod

#### a. Install not longer than twenty-four (24) hours from harvest

- b. Grass bed not less than two (2) inches in continuous thickness
- c. 100% continuous live sod coverage after first growing season and at end of warranty period.
- d. Of uniform non-varying density and continuous texture quality capable of growth and development
- immediately upon installation. Weed and noxious plant free e. Stagger installation rows and place aligned parallel to contours
- f. Fill joints solidly with planting bed preparation soil
- g. Provide anchor pins at twenty-four (24) inches on center for slopes greater than 4:1

#### 3. Grass Seed

- a. Mix approved by the Landscape Architect
- b. Provide first and new of year seed crops in mix free of weed seeds and deleterious matter c. Provide seed mix not greater than 15% annual or perennial rye
- d. Coverage 85% continuous coverage live stand after first growing season and at end of warranty
- e. Replacement or overseeding mixes consistent with original application/installation
- f. Provide erosion blankets or other slope retention methods as noted on drawings

#### II. Materials and Appurtenances A.Testing

1. Materials testing information/certificates/dated labels shall be current to the project and performed/certified not greater than 120 calendar previous days from current date of submittal for review

#### B. Top Soil

1. Neutral Ph balance 5.5 -7.5. Friable and containing 2.0-5.0% organic matter by dry weight. Continuously free of non-soil items such as stones, debris, sticks, trash, and deleterious matter greater than 3/4 inch in any direction. Clay content shall not exceed 25%. Gravel content shall not exceed 10%. Silt shall not exceed 25%

#### C.Use of Existing Topsoil

- 1. Existing topsoil on-site may be repurposed with prior Owner approval. Contractor shall provide soil testing and additive program that demonstrates consistent performance and characteristics and composition as
- identified herein. Owner shall approve soil testing and soil amendment/additive methods and procedures

#### D. Shredded Hardwood Mulch

1.100% organic shredded first year hardwood free of deleterious matter, rock, gravel and weed seed. Neutral Ph balance 5.5-7.5

#### E. Compost Ph

1. Balanced 5.0-8.5 mature, stable and weed free produced by natural aerobic decomposition. Free of visible contaminants and toxic substances. Not greater than 5% sand, silt, clay or rock by dry weight. Consistent with US-EPA CFR Title 40 Part 503 Standards for Class A biosolids

#### **G.Compost Testing**

- 1. Prior to delivery on-site, the following items are required for approval by Owner: Feedstock percentage in final compost product; statement that the products meets federal, state and local health safety requirements
- 2. Provide copy of lab analysis less than 120 calendar days old verifying that the product meets described physical requirements; chemical contaminants; Ph; physical contaminants; biological contaminants (including a statement that fecal coliform and salmonella testing and results comply with requirements of the US Composting Council Seal of Testing approval programs

#### **H.Planting Mix**

#### 1. 85% topsoil and 15% Compost

I. Fertilizer 1. Granular 10% nitrogen, 6% Phosphorous, 4% Potassium granular form with 50% Nitrogen in organic form.

1. Product and Material Safety Data as approved by Owner

Product and Material Safety Data as approved by Owner

#### K. Water

1. Potable only unless otherwise approved by Owner

M.Tree Ties

1. 2 x 2 x 48 inch square of sound hardwood, painted flat black on all sides

#### 1. Villa Non-Abrasive Rubber Tree Ties or approved equal

N. Filter Fabric 1. Mirafi 140-N or approved equal

#### III. Execution

#### **A.Site Conditions** 15. Inspect site and notify Owner in writing of acceptance with indication that project conditions are acceptable are suitable to proceed with work. Notify Owner of any existing damage and/or other conflicting

- conditions. 16. Do not proceed with work until unsatisfactory conditions have been satisfactorily remedied. Notify
- Owner of acceptance prior to commencement of work. 17. Notify Owner in writing of any conditions that may preclude successful completion of work including items such as coordination with other trades, incomplete work, drainage, soil temperature and/or
- composition, access to storage/work areas, damage to conditions, etc. 18. Notify Owner in writing immediately of any items that may influence work schedule, timing of tasks,
- materials delivery and/or installation and warranty responsibilities. 19. Coordinate and cooperate with other trades working in and adjacent to work areas. Examine drawings of other trades which show development of the entire project and become familiar with the scope of

#### **B. Planting Seasons**

required work by others.

Recommended seasons are a general guide based on historical climatic data and typical performance of plantings, and which vary dependent on project-specific environmental conditions. Due to construction schedules, recommended planting seasons may/may not coincide with request(s) for certificate of occupancy for projects. Coordination of planting installation and seasons shall be reviewed with Owner on an individual project basis.

#### **Deciduous and Evergreen Trees**

- Do not install/plant the following trees between September 15 and March 15 1. Oaks (Quercus Sp., Such as Q. rubra, Q. alba, Q. phellos, Q. coccinnea)
- 3. Sweetgum (Liquidambar Sp.) 4. All Conifers and Evergreens except White Pine (Pinus strobus Sp.)

#### Deciduous and Evergreen Shrubs a. Install/plant between March 15 and June 15 and/or September 15 and November 30

3. Perennials

a. Install/plant between March 15 and June 15 and/or September 15 and November 30

#### 4. Spring Flowering Bulbs a. Install/plant between September 15 and December 15

5. Seasonal Annuals

#### a. Install/plant in season per approved schedule

a. Install/plant between March 15 and May 15 and/or September 15 and November 30 b. Do not install/plant seed or sod turf grass areas when ambient air temperature is below forty (40) degrees Fahrenheit, or forecast for a twelve (12) hour period after completion of work

#### 7. No Plant Installation

a. Do not install plantings or turf grass between June 15 and September 15, without approval by Owner

#### **C.Positioning & Location of Plantings**

1. Position plants to show the most-prominent and well-formed face to most-public view

remedy of schedule delays. Do not work, place or modify frozen soil

- 2. Field locate plants and location/spacing/dimension of planting beds on project site prior to beginning 3. Verify location of individual plants and plant beds prior to beginning installation. Do not proceed without
- Owner approval

#### **D.Implementation**

- 1. Pursue work continuously without delay or interruption until completion unless notified otherwise by Owner 2. Provide project submittals ahead of commencement of work. Landscape Architect requires a minimum of ten (10) working days from date of receipt for review of submittals and response to Owner and Contractor.
- Plan accordingly for procurement of materials 3. Continuously update implementation schedule and notify Owner of progress. Delays related to material
- availability are not cause for non-completion of scheduled delivery of work 4. Report delays due to weather or site conditions immediately upon finding. Provide recommendation for


#### E. Clean Up


Architect.


1. Remove trash, debris and work materials from site prior to request for substantial completion. Thoroughly clean surfaces impacted by work including building, parking areas, roadways, sidewalks, signs, lights, site


5. Report delays due to extraordinary natural or other conditions beyond control of Contractor

2. Repair any damage to existing conditions that occurred during execution of work. 3. All clean-up and demobilization procedures shall be performed to satisfaction of the Owner and Landscape

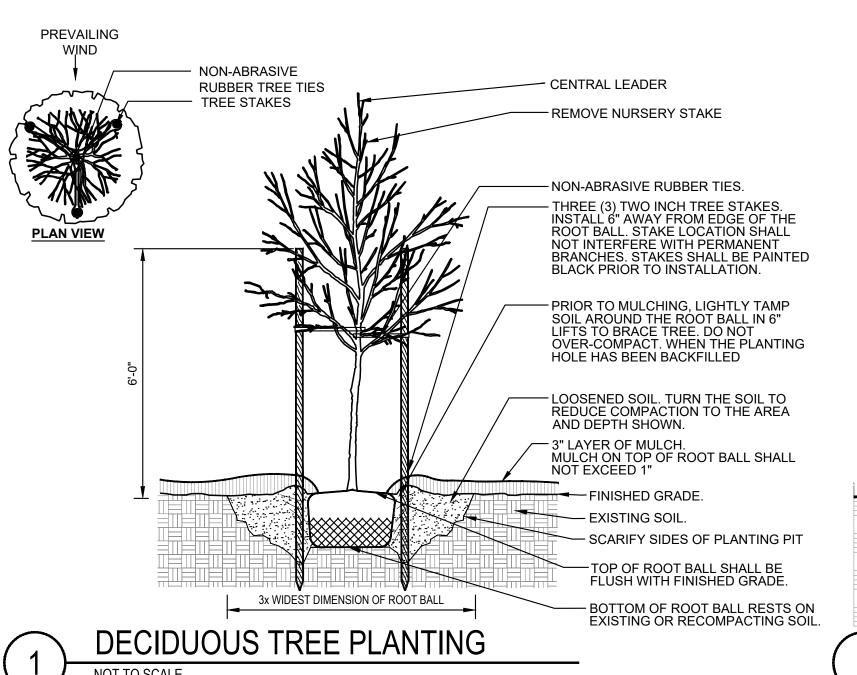

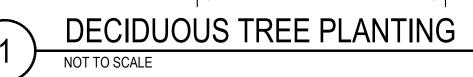

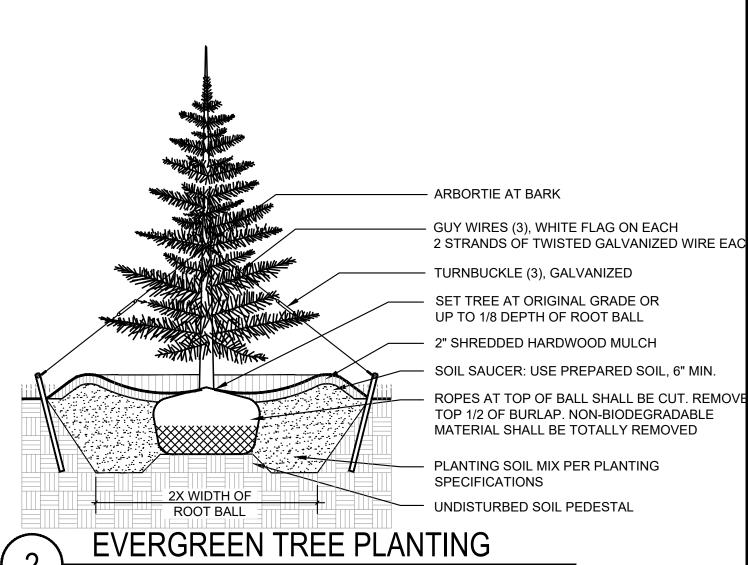

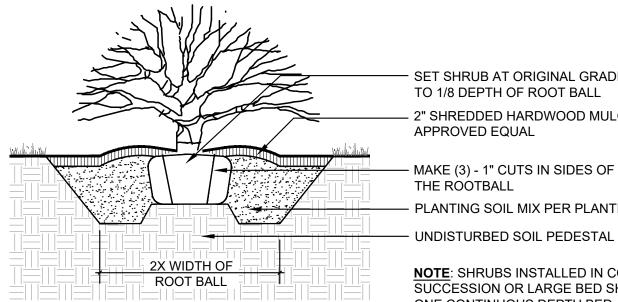

SET SHRUB AT ORIGINAL GRADE OR UP TO 1/8 DEPTH OF ROOT BALL 2" SHREDDED HARDWOOD MULCH OR APPROVED EQUAL

MAKE (3) - 1" CUTS IN SIDES OF THE ROOTBALL PLANTING SOIL MIX PER PLANTING SPECIFICATIONS

**NOTE**: SHRUBS INSTALLED IN CONTINUOUS SUCCESSION OR LARGE BED SHALL BE PLACED IN ONE CONTINUOUS DEPTH BED



0

NOT

A O

TORAG CHILL COVENTRY, LOSENECK HILL RD
NTRY, RI 02816
P 10 LOT 31 RHODE

VENTR OSENE 1920 N CO

> SHEET NUMBER L-1.1